


RAIN WATER HARVESTING PIT DETAILS

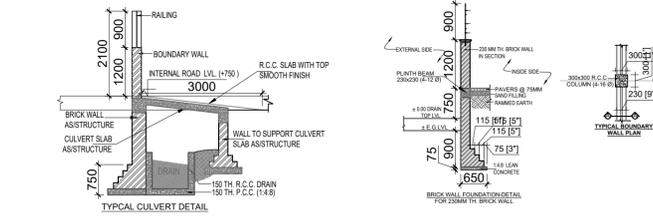

F.A.R. COVERED AREA CALCULATION FOR METER ROOM


| S.NO. | NO. | AREA (SQMT) |
|------------------------------|---------------|------------------|
| 1 | 8.950 X 4.950 | = 44.500 |
| 2 | 7.500 X 4.950 | = 37.225 |
| 3 | 9.500 X 4.950 | = 47.125 |
| TOTAL METER ROOM AREA | | = 128.850 |

AREA CALCULATION TOWARDS 18% SERVICES AREA AT GUARD ROOM

| S.NO. | PARTICULARS | AREA (SQMT) |
|------------------------------|---------------------|-----------------|
| A | 3.000 X 3.300 | = 9.900 |
| B | 3.000 X 0.250 X 0.5 | = 0.375 |
| C | 3.000 X 0.250 X 0.5 | = 0.375 |
| D | 3.000 X 3.300 | = 9.900 |
| E | 0.200 X 3.300 X 0.5 | = 0.660 |
| F | 3.000 X 2.400 | = 7.200 |
| TOTAL GUARD ROOM AREA | | = 29.475 |

AREA CALCULATION TOWARDS 18% SERVICES AREA AT COVERED WALKWAYS

| S.NO. | PARTICULARS | AREA (SQMT) |
|------------------------------------|-------------------|-----------------|
| Y1 | 6.000 X 6.000 X 2 | = 72.000 |
| Y2 | 4.500 X 4.500 | = 20.250 |
| TOTAL COVERED WALKWAYS AREA | | = 92.250 |

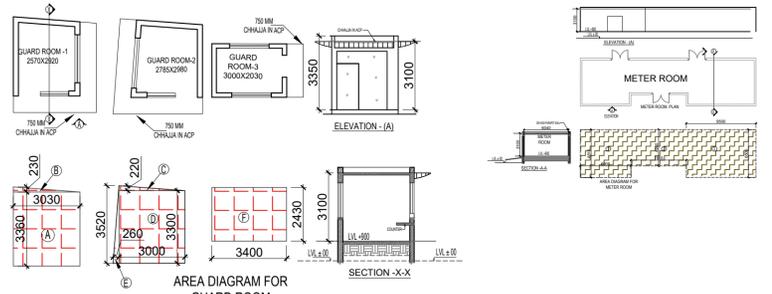

PLOT-GH-01A, OTHERS PLOT

PLOT LINE
2100 MM HIGH BOUNDARY WALL FROM DRAIN TOP
9.0 M SIDE SET BACK LINE
BASEMENT LINE


RAIN WATER HARVESTING DE-SILTING CHAMBER
DS COOL COOLER (OPEN TO SKY)

PLOT-GH-01N,M&L OTHER'S PLOT

PLOT LINE
2100 MM HIGH BOUNDARY WALL FROM DRAIN TOP
9.0 M SIDE SET BACK LINE
BASEMENT LINE

LEGEND :-

| | | |
|---|--|-----|
| 1 | SETBACK LINE | --- |
| 2 | BASEMENT LINE | --- |
| 3 | EXPANSION/SEISMIC JOINT AS PER STRUCTURE | --- |

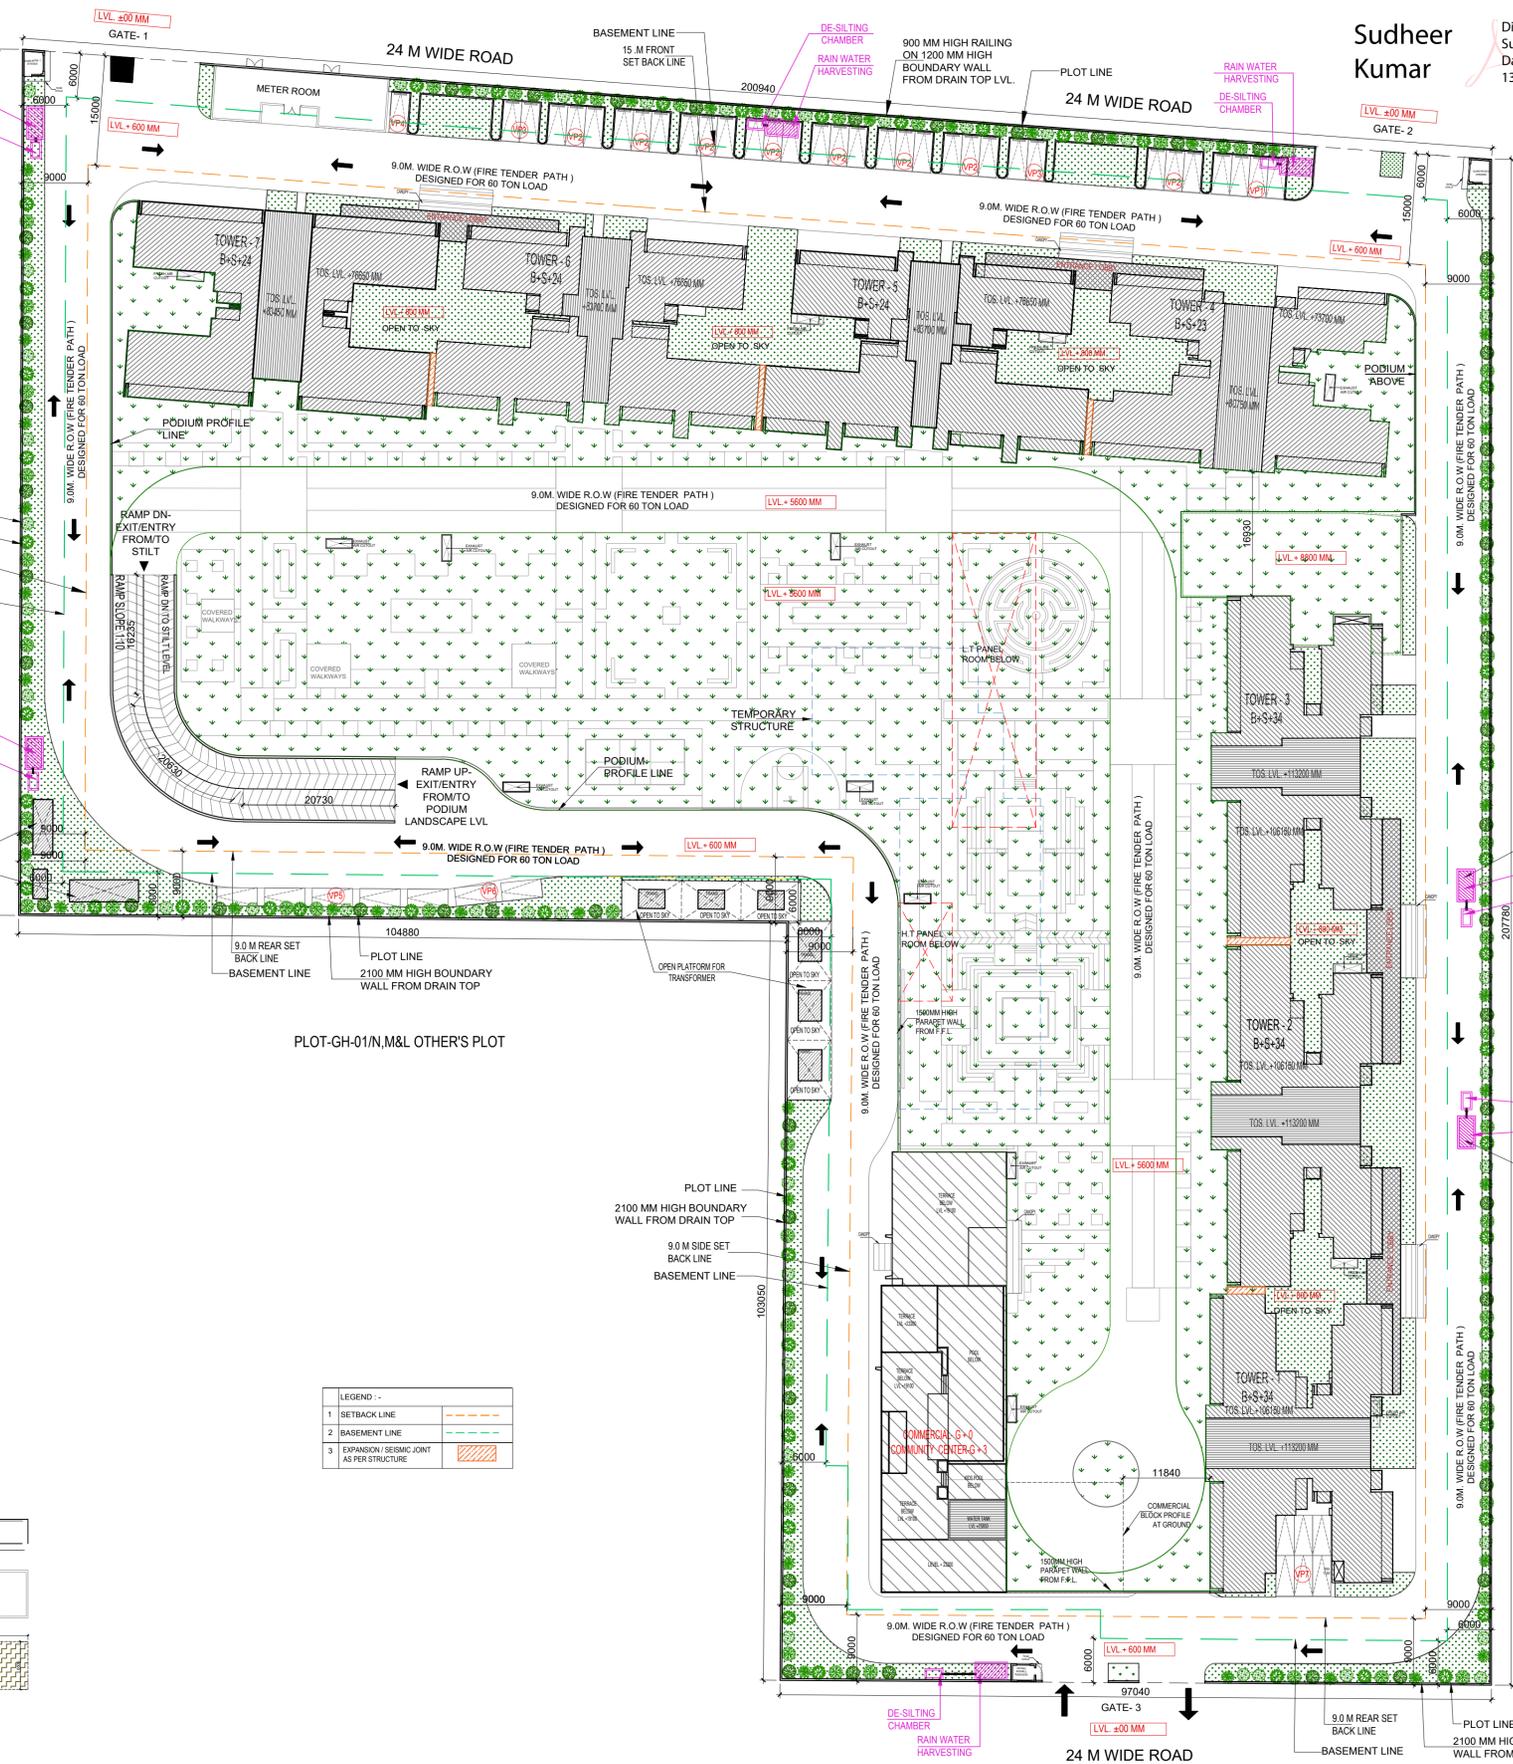

Sudheer Kumar
Digitally signed by Sudheer Kumar
Date: 2025.01.28
13:59:19 +05'30'

Amit Varma
Digitally signed by Amit Varma
Date: 2025.01.25
16:31:01 +05'30'

LAL SINGH
Digitally signed by LAL SINGH
Date: 2025.01.27
17:10:52 +05'30'


OWNER SIGN: **Rajat pathak** (Rajat pathak 2025.01.23 12:02:27 +05'30')

ARCHITECT SIGN: **AVANISH SRIVASTAV** (AVANISH SRIVASTAV 2025.01.23 12:02:18 +05'30')

TOWN PLANNER SIGN: **Abhishek Singh k Singh** (Abhishek Singh 2025.01.23 12:02:00 +05'30')

OWNER: **GODREJ PROPERTIES LIMITED**

SUBMISSION DRAWING

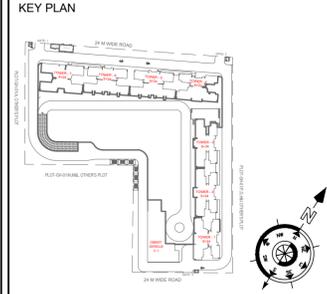

PROJECT: **PROPOSED GROUP HOUSING FOR PLOT NO :- GH-01/B,C,D,E,J & K SECTOR -12, GREATER NOIDA, G.B. NAGAR, (U.P.)**


| | | |
|----------------|---------------|---------------|
| DATE | PROJECT INCH. | CHECKED BY |
| 08 - 01 - 2025 | BALRAJ SINGH | BALRAJ SINGH |
| SCALE | DEALT BY | APPROVED BY |
| 1:100 | ABDHESH JHA | VISHAL SHARMA |

DRAWING TITLE: **SITE PLAN**

ARCHITECTS: **GOLDEN INDIA ARCHITECTS**
THE TEAM OF ARCHITECTS
FF-37, KADAMBA SHOPPING COMPLEX
GAMMA-1 GREATER NOIDA
CON... +91-94-1585-6777

DESIGN BY: **Confluence**
NEW DELHI, INDIA
F-1, FIRST FLOOR, MIRA CORPORATE SUITES,
ISHWAR NAGAR, NEW DELHI 110065
Ph: +91-11-26525684 cca@confluence.com Member of IGBC
Ph: +91-11-43564768 www.confluence.com ISO - 9001 2000
architecture urban design hospitality interiors

DRAWING NO. **S-02** REVISION

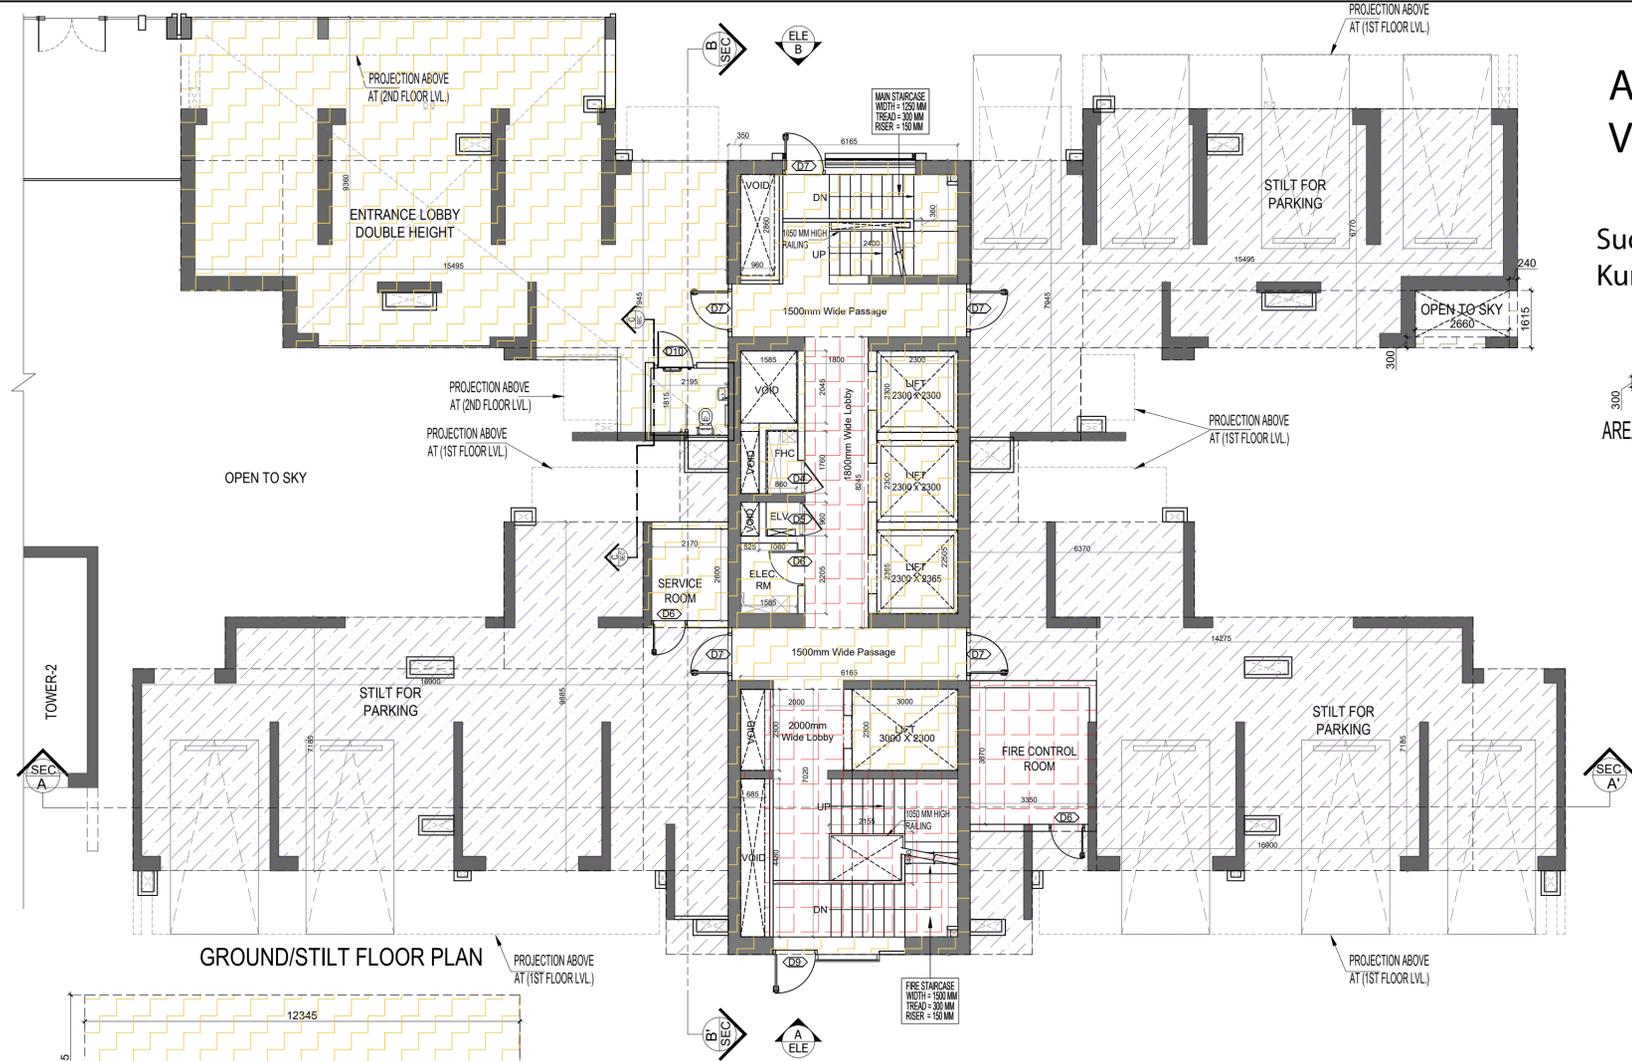

Amit Varma
Digitally signed by Amit Varma
Date: 2025.01.25
16:34:09 +05'30'

Sudheer Kumar
Digitally signed by Sudheer Kumar
Date: 2025.01.28 14:01:25
+05'30'




| S.NO. | AREA (SQMT) | AREA (SQMT) | AREA (SQMT) | AREA (SQMT) | |
|------------------------------|-------------|-------------|-------------|-------------|----------------|
| 1 | 12345 | X | 4.055 | = | 50.059 |
| 2 | 2900 | X | 3.690 | = | 10.701 |
| 3 | 12640 | X | 5.305 | = | 67.055 |
| 4 | 3215 | X | 0.350 | = | 1.125 |
| 5 | 3150 | X | 2.640 | = | 8.316 |
| 6 | 2410 | X | 3.000 | = | 7.230 |
| 7 | 6885 | X | 22.805 | = | 154.487 |
| B1 | 2660 | X | 0.300 | = | 0.798 |
| B2 | 0.240 | X | 1.615 | = | 0.388 |
| TOTAL F.A.R. AREA (A) | | | | = | 300.169 |

| S.NO. | PARTICULARS | AREA (SQMT) |
|---|---------------|-----------------|
| FIRE TOWER AREA | | |
| FS1 | 3.165 X 7.020 | = 22.218 |
| FS2 | 3.000 X 4.720 | = 14.160 |
| FC1 | 3.590 X 4.270 | = 15.329 |
| LIFT LOBBY | | |
| LL1 | 1.800 X 8.245 | = 14.841 |
| AREA SUBTRACTION | | |
| H5 | 0.685 X 2.300 | = 1.576 |
| H6 | 0.685 X 4.480 | = 3.069 |
| TOTAL AREA (E) | | = 4.644 |
| TOTAL GROUND COVERAGE AREA = F (D-E) | | = 61.904 |

| S.NO. | AREA (SQMT) |
|---|---------------------------|
| S1 | 1.375 X 2.300 X 2 = 6.325 |
| S2 | 3.955 X 4.165 = 16.473 |
| S3 | 7.915 X 1.465 = 11.595 |
| S4 | 14.485 X 5.720 = 82.854 |
| S5 | 2.410 X 8.885 = 21.413 |
| S6 | 1.765 X 2.375 X 2 = 8.384 |
| S7 | 3.590 X 1.115 = 4.003 |
| S8 | 10.690 X 7.185 = 76.808 |
| S9 | 2.620 X 5.720 = 14.986 |
| S10 | 3.590 X 1.795 = 6.444 |
| S11 | 6.365 X 2.700 = 17.186 |
| S12 | 3.150 X 2.640 = 8.316 |
| S13 | 0.915 X 0.350 = 0.320 |
| S14 | 9.445 X 1.620 = 15.301 |
| S15 | 3.200 X 5.305 = 16.976 |
| S16 | 12.345 X 5.155 = 63.638 |
| TOTAL GROUND FLOOR / STILT NON F.A.R. AREA (G) | = 366.202 |

| S.NO. | PARTICULARS | AREA (SQMT) |
|--------------------------|-------------|------------------|
| 1 | X | 241.535 |
| TOTAL F.A.R. AREA | | = 241.535 |

| | TOWER - 1 | | | | |
|----------------------------|-----------------|------------------|-----------------|---------------------------------|-------------------------|
| | GROUND COVERAGE | F.A.R. AREA | 15% AREA | STILT NON F.A.R. AREA (PARKING) | NON F.A.R. AREA BALCONY |
| GROUND / STILT FLOOR (FAR) | 690.204 | 241.535 | 66.549 | 366.202 | |
| 1ST FLOOR | | 449.172 | 52.988 | | 86.963 |
| 2ND FLOOR | | 551.539 | 53.882 | | 111.494 |
| 3RD FLOOR | | 551.539 | 53.882 | | 111.494 |
| 4TH FLOOR | | 551.539 | 53.882 | | 111.494 |
| 5TH FLOOR | | 551.539 | 53.882 | | 111.494 |
| 6TH FLOOR | | 551.539 | 53.882 | | 111.494 |
| 7TH FLOOR | | 551.539 | 53.882 | | 111.494 |
| 8TH FLOOR | | 551.539 | 53.882 | | 111.494 |
| 9TH FLOOR | | 551.539 | 53.882 | | 111.494 |
| 10TH FLOOR | | 551.539 | 53.882 | | 111.494 |
| 11TH FLOOR | | 551.539 | 53.882 | | 111.494 |
| 12TH FLOOR | | 551.539 | 53.882 | | 111.494 |
| 13TH FLOOR | | 551.539 | 53.882 | | 111.494 |
| 14TH FLOOR | | 551.539 | 53.882 | | 111.494 |
| 15TH FLOOR | | 551.539 | 53.882 | | 111.494 |
| 16TH FLOOR | | 551.539 | 53.882 | | 111.494 |
| 17TH FLOOR | | 551.539 | 53.882 | | 111.494 |
| 18TH FLOOR | | 551.539 | 53.882 | | 111.494 |
| 19TH FLOOR (REFUGE AREA) | | 530.141 | 89.964 | | 103.596 |
| 20TH FLOOR | | 551.539 | 53.882 | | 111.494 |
| 21ST FLOOR | | 551.539 | 53.882 | | 111.494 |
| 22ND FLOOR | | 551.539 | 53.882 | | 111.494 |
| 23RD FLOOR | | 551.539 | 53.882 | | 111.494 |
| 24TH FLOOR PLAN | | 551.539 | 53.882 | | 111.494 |
| 25TH FLOOR PLAN | | 551.539 | 53.882 | | 111.494 |
| 26TH FLOOR | | 551.539 | 53.882 | | 111.494 |
| 27TH FLOOR | | 551.539 | 53.882 | | 111.494 |
| 28TH FLOOR | | 551.539 | 53.882 | | 111.494 |
| 29TH FLOOR (REFUGE AREA) | | 530.141 | 89.964 | | 103.596 |
| 30TH FLOOR | | 551.539 | 53.882 | | 111.494 |
| 31ST FLOOR | | 551.539 | 53.882 | | 111.494 |
| 32ND FLOOR | | 551.539 | 53.882 | | 111.494 |
| 33RD FLOOR PLAN | | 551.539 | 53.882 | | 111.494 |
| 34TH FLOOR PLAN | | 551.539 | 53.882 | | 111.494 |
| TERRACE FLOOR | | 23.370 | 115.460 | | |
| MACHINE ROOM TOS LVL. | | | 79.176 | | |
| OHT | | | 54.009 | | |
| TOTAL | 690.204 | 18872.074 | 2218.455 | 366.202 | 3750.456 |

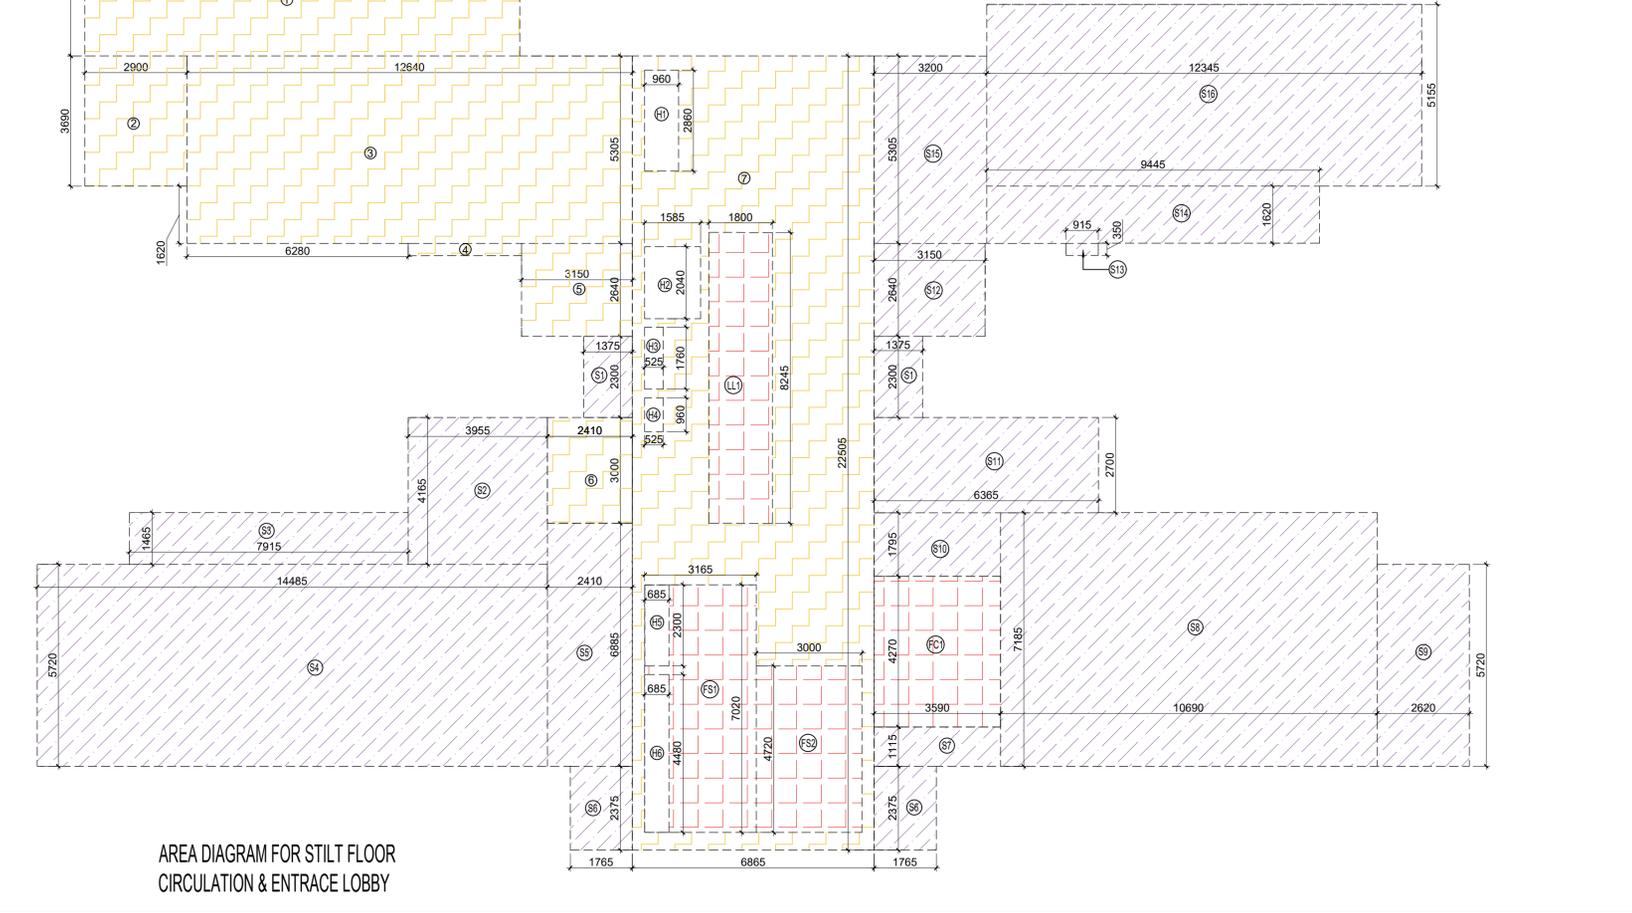

- LEGEND**
- F.A.R. AREA
 - 15% SERVICES AREA
 - NON F.A.R. AREA
 - COUNTED IN 1/4 F.A.R. AREA
 - NON F.A.R. AREA STILT
 - AREA FOR GROUND COVERAGE USE ONLY

OWNER SIGN
Rajat pathak
2025.01.2
3 12:06:12
+05'30'

ARCHITECT SIGN
AVANISH SRIVASTAV
2025.01.23
12:06:29
+05'30'

TOWN PLANNER SIGN

DOOR SCHEDULE

| S.NO. | TYPE | OPENING | HEIGHT | WELL | LEVEL | LOCATION | DESCRIPTION |
|-------|------|---------|--------|------|-------|----------|--|
| 1 | DOOR | 1200 | 2100 | 2100 | 2100 | LIVING | ALUMINUM JPPC FRAME DOUBLE GLAZED DOOR |
| 2 | DOOR | 1200 | 2100 | 2100 | 2100 | LIVING | ALUMINUM JPPC FRAME DOUBLE GLAZED DOOR |
| 3 | DOOR | 1200 | 2100 | 2100 | 2100 | LIVING | ALUMINUM JPPC FRAME DOUBLE GLAZED DOOR |
| 4 | DOOR | 1200 | 2100 | 2100 | 2100 | LIVING | ALUMINUM JPPC FRAME DOUBLE GLAZED DOOR |
| 5 | DOOR | 1200 | 2100 | 2100 | 2100 | LIVING | ALUMINUM JPPC FRAME DOUBLE GLAZED DOOR |
| 6 | DOOR | 1200 | 2100 | 2100 | 2100 | LIVING | ALUMINUM JPPC FRAME DOUBLE GLAZED DOOR |
| 7 | DOOR | 1200 | 2100 | 2100 | 2100 | LIVING | ALUMINUM JPPC FRAME DOUBLE GLAZED DOOR |
| 8 | DOOR | 1200 | 2100 | 2100 | 2100 | LIVING | ALUMINUM JPPC FRAME DOUBLE GLAZED DOOR |
| 9 | DOOR | 1200 | 2100 | 2100 | 2100 | LIVING | ALUMINUM JPPC FRAME DOUBLE GLAZED DOOR |
| 10 | DOOR | 1200 | 2100 | 2100 | 2100 | LIVING | ALUMINUM JPPC FRAME DOUBLE GLAZED DOOR |
| 11 | DOOR | 1200 | 2100 | 2100 | 2100 | LIVING | ALUMINUM JPPC FRAME DOUBLE GLAZED DOOR |
| 12 | DOOR | 1200 | 2100 | 2100 | 2100 | LIVING | ALUMINUM JPPC FRAME DOUBLE GLAZED DOOR |
| 13 | DOOR | 1200 | 2100 | 2100 | 2100 | LIVING | ALUMINUM JPPC FRAME DOUBLE GLAZED DOOR |
| 14 | DOOR | 1200 | 2100 | 2100 | 2100 | LIVING | ALUMINUM JPPC FRAME DOUBLE GLAZED DOOR |
| 15 | DOOR | 1200 | 2100 | 2100 | 2100 | LIVING | ALUMINUM JPPC FRAME DOUBLE GLAZED DOOR |
| 16 | DOOR | 1200 | 2100 | 2100 | 2100 | LIVING | ALUMINUM JPPC FRAME DOUBLE GLAZED DOOR |
| 17 | DOOR | 1200 | 2100 | 2100 | 2100 | LIVING | ALUMINUM JPPC FRAME DOUBLE GLAZED DOOR |
| 18 | DOOR | 1200 | 2100 | 2100 | 2100 | LIVING | ALUMINUM JPPC FRAME DOUBLE GLAZED DOOR |
| 19 | DOOR | 1200 | 2100 | 2100 | 2100 | LIVING | ALUMINUM JPPC FRAME DOUBLE GLAZED DOOR |
| 20 | DOOR | 1200 | 2100 | 2100 | 2100 | LIVING | ALUMINUM JPPC FRAME DOUBLE GLAZED DOOR |
| 21 | DOOR | 1200 | 2100 | 2100 | 2100 | LIVING | ALUMINUM JPPC FRAME DOUBLE GLAZED DOOR |
| 22 | DOOR | 1200 | 2100 | 2100 | 2100 | LIVING | ALUMINUM JPPC FRAME DOUBLE GLAZED DOOR |
| 23 | DOOR | 1200 | 2100 | 2100 | 2100 | LIVING | ALUMINUM JPPC FRAME DOUBLE GLAZED DOOR |
| 24 | DOOR | 1200 | 2100 | 2100 | 2100 | LIVING | ALUMINUM JPPC FRAME DOUBLE GLAZED DOOR |
| 25 | DOOR | 1200 | 2100 | 2100 | 2100 | LIVING | ALUMINUM JPPC FRAME DOUBLE GLAZED DOOR |
| 26 | DOOR | 1200 | 2100 | 2100 | 2100 | LIVING | ALUMINUM JPPC FRAME DOUBLE GLAZED DOOR |
| 27 | DOOR | 1200 | 2100 | 2100 | 2100 | LIVING | ALUMINUM JPPC FRAME DOUBLE GLAZED DOOR |
| 28 | DOOR | 1200 | 2100 | 2100 | 2100 | LIVING | ALUMINUM JPPC FRAME DOUBLE GLAZED DOOR |
| 29 | DOOR | 1200 | 2100 | 2100 | 2100 | LIVING | ALUMINUM JPPC FRAME DOUBLE GLAZED DOOR |
| 30 | DOOR | 1200 | 2100 | 2100 | 2100 | LIVING | ALUMINUM JPPC FRAME DOUBLE GLAZED DOOR |
| 31 | DOOR | 1200 | 2100 | 2100 | 2100 | LIVING | ALUMINUM JPPC FRAME DOUBLE GLAZED DOOR |
| 32 | DOOR | 1200 | 2100 | 2100 | 2100 | LIVING | ALUMINUM JPPC FRAME DOUBLE GLAZED DOOR |
| 33 | DOOR | 1200 | 2100 | 2100 | 2100 | LIVING | ALUMINUM JPPC FRAME DOUBLE GLAZED DOOR |
| 34 | DOOR | 1200 | 2100 | 2100 | 2100 | LIVING | ALUMINUM JPPC FRAME DOUBLE GLAZED DOOR |
| 35 | DOOR | 1200 | 2100 | 2100 | 2100 | LIVING | ALUMINUM JPPC FRAME DOUBLE GLAZED DOOR |
| 36 | DOOR | 1200 | 2100 | 2100 | 2100 | LIVING | ALUMINUM JPPC FRAME DOUBLE GLAZED DOOR |
| 37 | DOOR | 1200 | 2100 | 2100 | 2100 | LIVING | ALUMINUM JPPC FRAME DOUBLE GLAZED DOOR |
| 38 | DOOR | 1200 | 2100 | 2100 | 2100 | LIVING | ALUMINUM JPPC FRAME DOUBLE GLAZED DOOR |
| 39 | DOOR | 1200 | 2100 | 2100 | 2100 | LIVING | ALUMINUM JPPC FRAME DOUBLE GLAZED DOOR |
| 40 | DOOR | 1200 | 2100 | 2100 | 2100 | LIVING | ALUMINUM JPPC FRAME DOUBLE GLAZED DOOR |
| 41 | DOOR | 1200 | 2100 | 2100 | 2100 | LIVING | ALUMINUM JPPC FRAME DOUBLE GLAZED DOOR |
| 42 | DOOR | 1200 | 2100 | 2100 | 2100 | LIVING | ALUMINUM JPPC FRAME DOUBLE GLAZED DOOR |
| 43 | DOOR | 1200 | 2100 | 2100 | 2100 | LIVING | ALUMINUM JPPC FRAME DOUBLE GLAZED DOOR |
| 44 | DOOR | 1200 | 2100 | 2100 | 2100 | LIVING | ALUMINUM JPPC FRAME DOUBLE GLAZED DOOR |
| 45 | DOOR | 1200 | 2100 | 2100 | 2100 | LIVING | ALUMINUM JPPC FRAME DOUBLE GLAZED DOOR |
| 46 | DOOR | 1200 | 2100 | 2100 | 2100 | LIVING | ALUMINUM JPPC FRAME DOUBLE GLAZED DOOR |
| 47 | DOOR | 1200 | 2100 | 2100 | 2100 | LIVING | ALUMINUM JPPC FRAME DOUBLE GLAZED DOOR |
| 48 | DOOR | 1200 | 2100 | 2100 | 2100 | LIVING | ALUMINUM JPPC FRAME DOUBLE GLAZED DOOR |
| 49 | DOOR | 1200 | 2100 | 2100 | 2100 | LIVING | ALUMINUM JPPC FRAME DOUBLE GLAZED DOOR |
| 50 | DOOR | 1200 | 2100 | 2100 | 2100 | LIVING | ALUMINUM JPPC FRAME DOUBLE GLAZED DOOR |


WINDOW SCHEDULE

| S.NO. | TYPE | OPENING | HEIGHT | WELL | LEVEL | LOCATION | DESCRIPTION |
|-------|-------|---------|--------|------|-------|----------|--|
| 1 | WIN | 600 | 2100 | 1900 | 2100 | TOILET | SPECIAL ALUMINUM FRAME SHOROPLY GLASS WINDOW |
| 2 | WIN | 600 | 1100 | 1000 | 2100 | DRESS | SPECIAL ALUMINUM FRAME SHOROPLY GLASS WINDOW |
| 3 | WIN | 600 | 1100 | 1000 | 2100 | DRESS | SPECIAL ALUMINUM FRAME SHOROPLY GLASS WINDOW |
| 4 | WIN | 400 | 1100 | 1000 | 2100 | DRESS | SPECIAL ALUMINUM FRAME SHOROPLY GLASS WINDOW |
| 5 | WIN | 1000 | 1100 | 1000 | 2100 | LIVING | SPECIAL ALUMINUM FRAME SHOROPLY GLASS WINDOW |
| 6 | WIN | 1200 | 1100 | 1000 | 2100 | LIVING | SPECIAL ALUMINUM FRAME SHOROPLY GLASS WINDOW |
| 7 | WIN | 1200 | 1100 | 1000 | 2100 | LIVING | SPECIAL ALUMINUM FRAME SHOROPLY GLASS WINDOW |
| 8 | WIN | 1200 | 1100 | 1000 | 2100 | LIVING | SPECIAL ALUMINUM FRAME SHOROPLY GLASS WINDOW |
| 9 | WIN | 1200 | 1100 | 1000 | 2100 | LIVING | SPECIAL ALUMINUM FRAME SHOROPLY GLASS WINDOW |
| 10 | WIN | 1200 | 1100 | 1000 | 2100 | LIVING | SPECIAL ALUMINUM FRAME SHOROPLY GLASS WINDOW |
| 11 | WIN | 1200 | 1100 | 1000 | 2100 | LIVING | SPECIAL ALUMINUM FRAME SHOROPLY GLASS WINDOW |
| 12 | WIN | 1200 | 1100 | 1000 | 2100 | LIVING | SPECIAL ALUMINUM FRAME SHOROPLY GLASS WINDOW |
| 13 | WIN | 1200 | 1100 | 1000 | 2100 | LIVING | SPECIAL ALUMINUM FRAME SHOROPLY GLASS WINDOW |
| 14 | WIN | 1200 | 1100 | 1000 | 2100 | LIVING | SPECIAL ALUMINUM FRAME SHOROPLY GLASS WINDOW |
| 15 | WIN | 1200 | 1100 | 1000 | 2100 | LIVING | SPECIAL ALUMINUM FRAME SHOROPLY GLASS WINDOW |
| 16 | WIN | 1200 | 1100 | 1000 | 2100 | LIVING | SPECIAL ALUMINUM FRAME SHOROPLY GLASS WINDOW |
| 17 | WIN | 1200 | 1100 | 1000 | 2100 | LIVING | SPECIAL ALUMINUM FRAME SHOROPLY GLASS WINDOW |
| 18 | WIN | 1200 | 1100 | 1000 | 2100 | LIVING | SPECIAL ALUMINUM FRAME SHOROPLY GLASS WINDOW |
| 19 | WIN | 1200 | 1100 | 1000 | 2100 | LIVING | SPECIAL ALUMINUM FRAME SHOROPLY GLASS WINDOW |
| 20 | WIN | 1200 | 1100 | 1000 | 2100 | LIVING | SPECIAL ALUMINUM FRAME SHOROPLY GLASS WINDOW |
| 21 | WIN | 1200 | 1100 | 1000 | 2100 | LIVING | SPECIAL ALUMINUM FRAME SHOROPLY GLASS WINDOW |
| 22 | WIN | 1200 | 1100 | 1000 | 2100 | LIVING | SPECIAL ALUMINUM FRAME SHOROPLY GLASS WINDOW |
| 23 | WIN | 1200 | 1100 | 1000 | 2100 | LIVING | SPECIAL ALUMINUM FRAME SHOROPLY GLASS WINDOW |
| 24 | WIN | 1200 | 1100 | 1000 | 2100 | LIVING | SPECIAL ALUMINUM FRAME SHOROPLY GLASS WINDOW |
| 25 | WIN | 1200 | 1100 | 1000 | 2100 | LIVING | SPECIAL ALUMINUM FRAME SHOROPLY GLASS WINDOW |
| 26 | WIN | 1200 | 1100 | 1000 | 2100 | LIVING | SPECIAL ALUMINUM FRAME SHOROPLY GLASS WINDOW |
| 27 | WIN | 1200 | 1100 | 1000 | 2100 | LIVING | SPECIAL ALUMINUM FRAME SHOROPLY GLASS WINDOW |
| 28 | WIN | 1200 | 1100 | 1000 | 2100 | LIVING | SPECIAL ALUMINUM FRAME SHOROPLY GLASS WINDOW |
| 29 | WIN | 1200 | 1100 | 1000 | 2100 | LIVING | SPECIAL ALUMINUM FRAME SHOROPLY GLASS WINDOW |
| 30 | WIN | 1200 | 1100 | 1000 | 2100 | LIVING | SPECIAL ALUMINUM FRAME SHOROPLY GLASS WINDOW |
| 31 | WIN | 1200 | 1100 | 1000 | 2100 | LIVING | SPECIAL ALUMINUM FRAME SHOROPLY GLASS WINDOW |
| 32 | WIN | 1200 | 1100 | 1000 | 2100 | LIVING | SPECIAL ALUMINUM FRAME SHOROPLY GLASS WINDOW |
| 33 | WIN | 1200 | 1100 | 1000 | 2100 | LIVING | SPECIAL ALUMINUM FRAME SHOROPLY GLASS WINDOW |
| 34 | WIN | 1200 | 1100 | 1000 | 2100 | LIVING | SPECIAL ALUMINUM FRAME SHOROPLY GLASS WINDOW |
| 35 | WIN | 1200 | 1100 | 1000 | 2100 | LIVING | SPECIAL ALUMINUM FRAME SHOROPLY GLASS WINDOW |
| 36 | WIN | 1200 | 1100 | 1000 | 2100 | LIVING | SPECIAL ALUMINUM FRAME SHOROPLY GLASS WINDOW |
| 37 | WIN | 1200 | 1100 | 1000 | 2100 | LIVING | SPECIAL ALUMINUM FRAME SHOROPLY GLASS WINDOW |
| 38 | WIN | 1200 | 1100 | 1000 | 2100 | LIVING | SPECIAL ALUMINUM FRAME SHOROPLY GLASS WINDOW |
| 39 | WIN | 1200 | 1100 | 1000 | 2100 | LIVING | SPECIAL ALUMINUM FRAME SHOROPLY GLASS WINDOW |
| 40 | WIN</ | | | | | | |



Amit Varma
Digitally signed by Amit Varma
Date: 2025.01.25
16:34:44 +05'30'

Sudheer Kumar
Digitally signed by Sudheer Kumar
Date: 2025.01.28
14:01:50 +05'30'

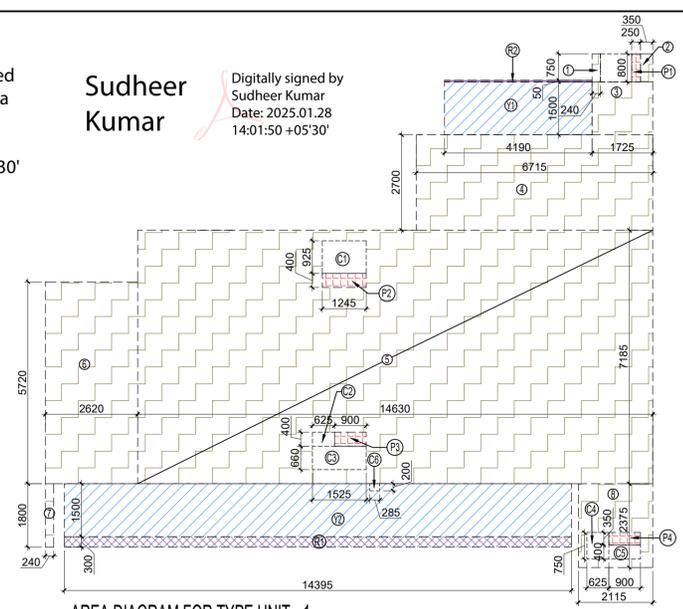

AREA DIAGRAM FOR TYPE UNIT - 1

| F.A.R. AREA AT CONNECTING BEAM (EVERY FLOOR) | | | |
|--|-------------------|-------------|----------------|
| S.NO. | PARTICULARS | AREA (SQMT) | |
| 1 | 0.300 X 4.590 X 2 | = 2.754 | |
| TOTAL F.A.R. AREA | | | = 2.754 |


| TOTAL F.A.R. AREA AT FIRST (PODIUM) FLOOR PLAN | | | |
|--|--------------------------------|-------------|------------------|
| S.NO. | PARTICULARS | AREA (SQMT) | |
| 1 | F.A.R. AREA OF UNIT - 1 | 2 X 143.470 | = 286.940 |
| 2 | F.A.R. AREA OF UNIT - 2 | 1 X 105.148 | = 105.148 |
| 3 | F.A.R. AREA OF CIRCULATION | 1 X 54.329 | = 54.329 |
| 4 | F.A.R. AREA OF CONNECTING BEAM | = 2.754 | |
| TOTAL F.A.R. AREA | | | = 449.172 |

| TOTAL NON F.A.R. AREA AT FIRST/PODIUM | | | |
|---------------------------------------|------------|----------|-----------------|
| UNIT | AREA | | |
| UNIT - 1 | 31.217 X 2 | = 62.433 | |
| UNIT - 2 | 24.530 X 1 | = 24.530 | |
| TOTAL BALCONY AREA | | | = 86.963 |


AREA DIAGRAM FOR CONNECTING BEAM EVERY FLOOR

| F.A.R. COVERED AREA CALCULATION FOR TYPE UNIT - 2 | | | |
|---|----------------|-------------|----------------|
| S.NO. | PARTICULARS | AREA (SQMT) | |
| 1 | 1.275 X 0.240 | = 0.306 | |
| 2 | 3.500 X 2.640 | = 9.240 | |
| 3 | 3.550 X 5.305 | = 18.833 | |
| 4 | 9.445 X 6.770 | = 63.943 | |
| 5 | 0.915 X 0.350 | = 0.320 | |
| 6 | 2.900 X 5.155 | = 14.950 | |
| 7 | 0.240 X 1.525 | = 0.366 | |
| UNIT FAR AREA = (A) | | | 107.957 |
| AREA SUBTRACTION PLUMBING CUTOFF | | | |
| P5 | 1.335 X 0.400 | = 0.534 | |
| P6 | 0.900 X 0.400 | = 0.360 | |
| C1 | 1.335 X 0.855 | = 1.141 | |
| C2 | 0.625 X 0.810 | = 0.506 | |
| C3 | 0.900 X 0.410 | = 0.369 | |
| TOTAL (B) | | | 2.911 |
| TOTAL F.A.R. AREA C = (A - B) | | | 105.046 |
| 1/4 F.A.R. AREA OF BALCONY | | | |
| R1 | 0.025 X 1.850 | = 0.046 | |
| R2 | 11.805 X 0.025 | = 0.295 | |
| R3 | 2.600 X 0.025 | = 0.065 | |
| TOTAL AREA (D) | | | 0.406 |
| 1/4 BALCONY F.A.R. AREA (E) | | | 0.102 |
| TOTAL UNIT F.A.R. AREA F = (C + E) | | | 105.148 |


| F.A.R. COVERED AREA CALCULATION FOR UNIT - 1 | | | |
|--|----------------|-------------|----------------|
| S.NO. | PARTICULARS | AREA (SQMT) | |
| 1 | 0.240 X 0.800 | = 0.192 | |
| 2 | 0.350 X 0.800 | = 0.280 | |
| 3 | 1.725 X 1.500 | = 2.588 | |
| 4 | 6.715 X 2.700 | = 18.131 | |
| 5 | 14.630 X 7.185 | = 105.117 | |
| 6 | 2.620 X 5.720 | = 14.986 | |
| 7 | 0.240 X 1.800 | = 0.432 | |
| 8 | 2.115 X 2.375 | = 5.023 | |
| UNIT FAR AREA = (A) | | | 146.748 |
| AREA SUBTRACTION PLUMBING CUTOFF | | | |
| P2 | 1.245 X 0.400 | = 0.498 | |
| P3 | 0.900 X 0.400 | = 0.360 | |
| P4 | 0.900 X 0.350 | = 0.315 | |
| C1 | 1.245 X 0.925 | = 1.152 | |
| C2 | 0.625 X 0.400 | = 0.250 | |
| C3 | 1.525 X 0.660 | = 1.007 | |
| C4 | 0.625 X 0.750 | = 0.469 | |
| C5 | 0.900 X 0.400 | = 0.360 | |
| TOTAL (B) | | | 4.410 |
| TOTAL F.A.R. AREA C = (A - B) | | | 142.338 |
| 1/4 F.A.R. AREA OF BALCONY | | | |
| R1 | 14.395 X 0.300 | = 4.319 | |
| R2 | 4.190 X 0.050 | = 0.210 | |
| TOTAL AREA (D) | | | 4.529 |
| 1/4 BALCONY F.A.R. AREA (E) | | | 1.132 |
| TOTAL UNIT F.A.R. AREA F = (C + E) | | | 143.470 |

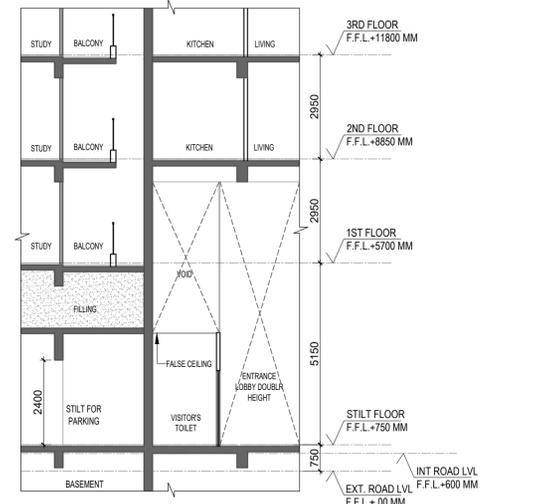

TYPICAL SECTION THRU TOILET STILT

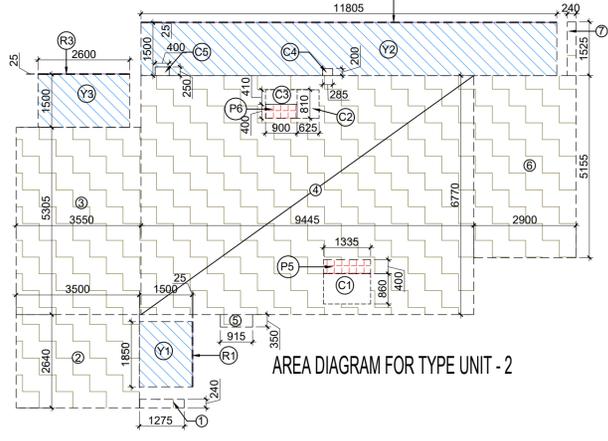

AREA DIAGRAM FOR TYPE UNIT - 2

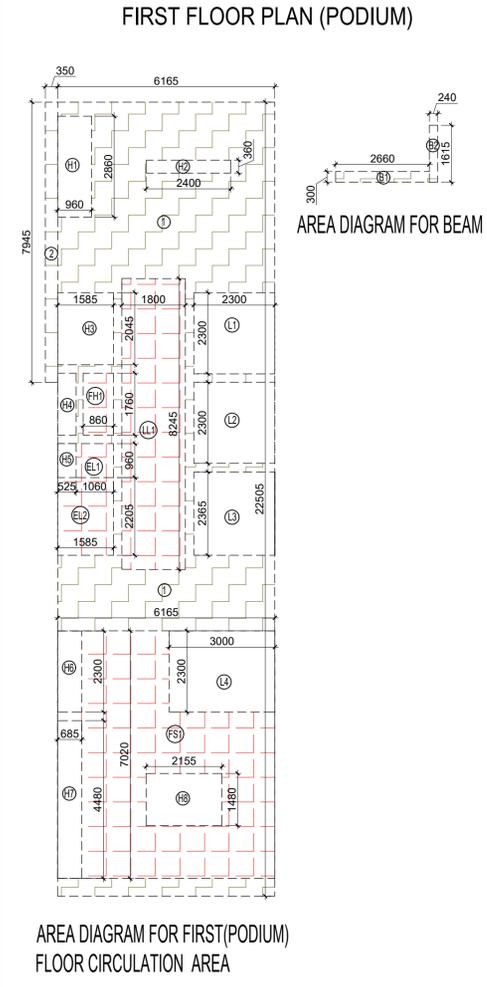

AREA DIAGRAM FOR FIRST (PODIUM) FLOOR CIRCULATION AREA

| F.A.R. COVERED AREA CALCULATION FOR CIRCULATION AREA | | | |
|--|----------------|-------------|----------------|
| S.NO. | PARTICULARS | AREA (SQMT) | |
| 1 | 6.165 X 22.505 | = 138.743 | |
| 2 | 0.350 X 7.945 | = 2.781 | |
| B1 | 2.660 X 0.300 | = 0.798 | |
| B2 | 0.240 X 1.615 | = 0.388 | |
| TOTAL AREA (A) | | | 142.710 |
| AREA SUBTRACTION | | | |
| FS1 | 6.165 X 7.020 | = 43.278 | |
| LL1 | 1.800 X 8.245 | = 14.841 | |
| FH1 | 0.860 X 1.760 | = 1.514 | |
| EL1 | 1.060 X 0.900 | = 0.954 | |
| EL2 | 1.585 X 2.205 | = 3.495 | |
| L1 | 2.300 X 2.300 | = 5.290 | |
| L2 | 2.300 X 2.300 | = 5.290 | |
| L3 | 2.300 X 2.365 | = 5.440 | |
| H1 | 0.960 X 2.860 | = 2.746 | |
| H2 | 2.400 X 0.360 | = 0.864 | |
| H3 | 1.585 X 2.045 | = 3.241 | |
| H4 | 0.525 X 1.760 | = 0.924 | |
| H5 | 0.525 X 0.960 | = 0.504 | |
| TOTAL (B) | | | 88.380 |
| TOTAL F.A.R. AREA CORRIDOR C = (A - B) | | | 54.329 |


| CORRIDOR AREA CALCULATION TOWARDS 15% ADDITIONAL F.A.R. | | | |
|---|-------------------|-------------|---------------|
| S.NO. | PARTICULARS | AREA (SQMT) | |
| FS1 | 6.165 X 7.020 | = 43.278 | |
| LL1 | 1.800 X 8.245 | = 14.841 | |
| EL1 | 1.060 X 0.900 | = 0.954 | |
| EL2 | 1.585 X 2.205 | = 3.495 | |
| FH1 | 0.860 X 1.760 | = 1.514 | |
| TOTAL CORRIDOR AREA CALCULATION TOWARDS 15% ADDITIONAL F.A.R. (A) | | | 64.082 |
| UNIT AREA CALCULATION TOWARDS 15% ADDITIONAL F.A.R. | | | |
| PLUMBING SHAFT | | | |
| P1 | 0.250 X 0.800 X 2 | = 0.400 | |
| P2 | 1.245 X 0.400 X 2 | = 0.996 | |
| P3 | 0.900 X 0.400 X 2 | = 0.720 | |
| P4 | 0.900 X 0.350 X 2 | = 0.630 | |
| P5 | 1.335 X 0.400 | = 0.534 | |
| P6 | 0.900 X 0.400 | = 0.360 | |
| TOTAL UNIT AREA CALCULATION TOWARDS 15% ADDITIONAL F.A.R. (B) | | | 3.840 |
| TOTAL 15% ADDITIONAL F.A.R. AREA (CORRIDOR AREA + UNIT AREA) = C (A+B) | | | 67.722 |
| AREA SUBTRACTION | | | |
| L4 | 3.600 X 2.300 | = 8.280 | |
| H6 | 0.685 X 2.300 | = 1.578 | |
| H7 | 0.685 X 4.480 | = 3.066 | |
| H8 | 2.155 X 1.480 | = 3.189 | |
| TOTAL AREA (D) | | | 14.734 |
| TOTAL 15% ADDITIONAL F.A.R. AREA E = (C - D) | | | 52.988 |

| NON F.A.R. AREA OF BALCONY | | | |
|--------------------------------------|----------------|-------------|---------------|
| S.NO. | PARTICULARS | AREA (SQMT) | |
| Y1 | 1.500 X 1.850 | = 2.775 | |
| Y2 | 11.805 X 1.500 | = 17.708 | |
| Y3 | 2.600 X 1.500 | = 3.900 | |
| 3/4 AREA OF BALCONY (D - E) | | | 0.305 |
| TOTAL BALCONY AREA (G) | | | 24.687 |
| AREA SUBTRACTION | | | |
| C4 | 0.285 X 0.200 | = 0.057 | |
| C5 | 0.400 X 0.250 | = 0.100 | |
| TOTAL (H) | | | 0.157 |
| TOTAL F.A.R. AREA J = (G - H) | | | 24.530 |

| 15% SERVICES AREA OF UNIT (PLUMBING SHAFT) | | | |
|--|-------------------------------|-------------|----------------|
| S.NO. | PARTICULARS | AREA (SQMT) | |
| P5 | 1.335 X 0.400 | = 0.534 | |
| P6 | 0.900 X 0.400 | = 0.360 | |
| TOTAL 15% SERVICES AREA OF UNIT (K) | | | 0.894 |
| COVERAGE AREA FOR UNIT = (F + J + K) | | | |
| 1 | TOTAL UNIT F.A.R. AREA (F) | = 105.148 | |
| 2 | NON FAR AREA OF UNIT (J) | = 24.530 | |
| 3 | 15% SERVICES AREA OF UNIT (K) | = 0.894 | |
| TOTAL UNIT COVERAGE AREA | | | 130.572 |


| 15% SERVICES AREA OF UNIT (PLUMBING SHAFT) | | | |
|--|-------------------------------|-------------|----------------|
| S.NO. | PARTICULARS | AREA (SQMT) | |
| P1 | 0.250 X 0.800 | = 0.200 | |
| P2 | 1.245 X 0.400 | = 0.498 | |
| P3 | 0.900 X 0.400 | = 0.360 | |
| P4 | 0.900 X 0.350 | = 0.315 | |
| TOTAL 15% SERVICES AREA OF UNIT (K) | | | 1.373 |
| COVERAGE AREA FOR UNIT = (F + J + K) | | | |
| 1 | TOTAL UNIT F.A.R. AREA (F) | = 143.470 | |
| 2 | NON FAR AREA OF UNIT (J) | = 31.217 | |
| 3 | 15% SERVICES AREA OF UNIT (K) | = 1.373 | |
| TOTAL UNIT COVERAGE AREA | | | 176.060 |

| | | |
|--|---|------------------------------|
| OWNER SIGN Rajat pathak 2025.01.2 3 12:06:59 +05'30' | ARCHITECT SIGN AVANISH SRIVASTAV 2025.01.23 12:06:50 +05'30' | |
| TOWN PLANNER SIGN | | |
| DOOR SCHEDULE | | |
| WINDOW SCHEDULE | | |
| <p>LAL SINGH Digitally signed by LAL SINGH Date: 2025.01.27 17:20:17 +05'30'</p> | | |
| OWNER GODREJ PROPERTIES LIMITED | | |
| SUBMISSION DRAWING | | |
| KEY PLAN | | |
| PROJECT PROPOSED GROUP HOUSING FOR PLOT NO. - GH-01/B,C,D,E,J & K SECTOR-12, GREATER NOIDA, G.B. NAGAR, (U.P.) | | |
| DATE 08 - 01 - 2025 | PROJECT INCH. BALRAJ SINGH | CHECKED BY BALRAJ SINGH |
| SCALE 1:100 | DEALT BY ABDHESH JHA | APPROVED BY VISHAL SHARMA |
| DRAWING TITLE FIRST FLOOR PLAN (PODIUM) | | |
| TOWER-1 | | |
| ARCHITECTS GI GOLDEN INDIA ARCHITECTS THE TEAM OF ARCHITECTS FF-37, KADAMBA SHOPPING COMPLEX GAMMA-1 GREATER NOIDA CON. +91-94-1585-6777 | | |
| DESIGN BY: Confluence NEW DELHI, INDIA | | |
| F-1, FIRST FLOOR, MIRA CORPORATE SUITES, ISHWAR NAGAR, NEW DELHI 110065 | | |
| Ph: +91-11-26925684 Pn: +91-11-40564768 architecture urban design hospitality interiors | ccs@confluence.com www.confluence.com ISO - 9001:2000 | Member of IGC |
| DRAWING NO. S-10 | REVISION | |

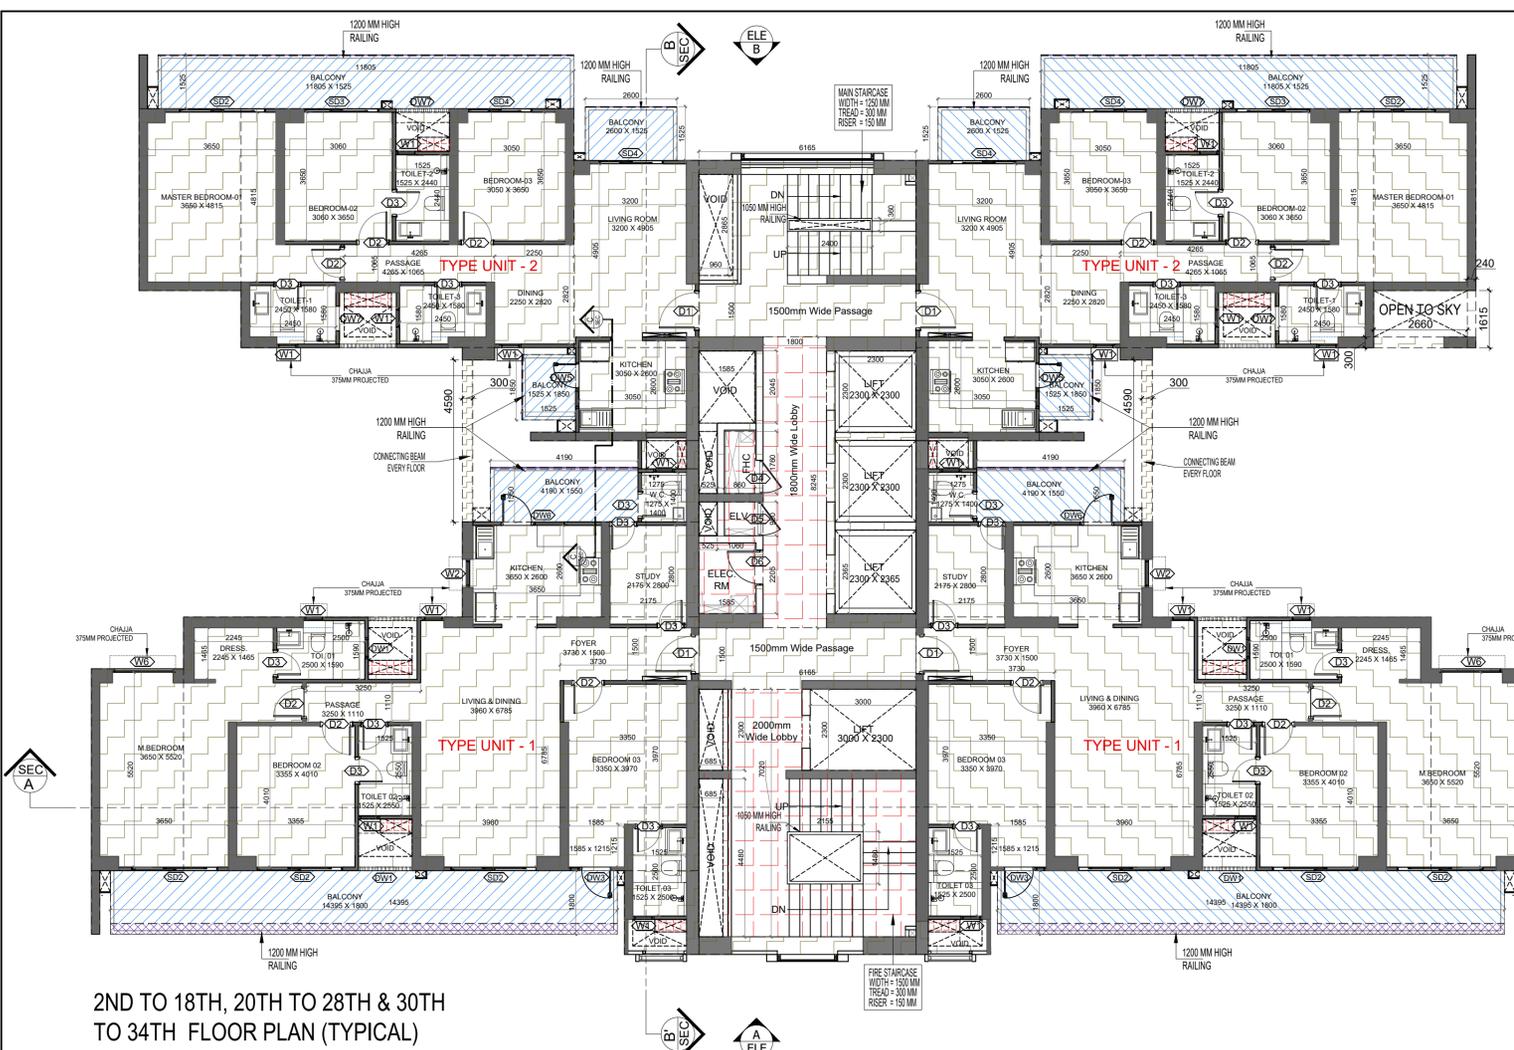

Amit Varma
Digitally signed by Amit Varma
Date: 2025.01.25
16:35:21 +05'30'

Sudheer Kumar
Digitally signed by Sudheer Kumar
Date: 2025.01.28
14:02:17 +05'30'

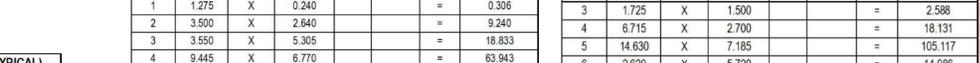

| F.A.R. AREA AT CONNECTING BEAM (EVERY FLOOR) | | | | |
|--|-------------|---------|---|----------------|
| S.NO. | PARTICULARS | | | AREA (SQMT) |
| 1 | 0.300 X | 4.590 X | 2 | = 2.754 |
| TOTAL F.A.R. AREA | | | | = 2.754 |



| F.A.R. COVERED AREA CALCULATION FOR TYPE UNIT - 2 | | | | |
|---|-------------|-------|--|------------------|
| S.NO. | PARTICULARS | | | AREA (SQMT) |
| 1 | 1.275 X | 0.240 | | = 0.306 |
| 2 | 3.500 X | 2.640 | | = 9.240 |
| 3 | 3.650 X | 5.305 | | = 18.833 |
| 4 | 9.445 X | 6.770 | | = 63.943 |
| 5 | 0.915 X | 0.350 | | = 0.320 |
| 6 | 2.900 X | 5.155 | | = 14.950 |
| 7 | 0.240 X | 1.525 | | = 0.366 |
| UNIT FAR AREA = (A) | | | | = 107.957 |

| F.A.R. COVERED AREA CALCULATION FOR UNIT - 1 | | | | |
|--|-------------|-------|--|------------------|
| S.NO. | PARTICULARS | | | AREA (SQMT) |
| 1 | 0.240 X | 0.800 | | = 0.192 |
| 2 | 0.350 X | 0.800 | | = 0.280 |
| 3 | 1.725 X | 1.500 | | = 2.588 |
| 4 | 6.715 X | 2.700 | | = 18.131 |
| 5 | 14.630 X | 7.185 | | = 105.117 |
| 6 | 2.620 X | 5.720 | | = 14.986 |
| 7 | 0.240 X | 1.800 | | = 0.432 |
| 8 | 2.115 X | 2.375 | | = 5.023 |
| UNIT FAR AREA = (A) | | | | = 146.748 |

| AREA SUBTRACTION PLUMBING CUTOFF | | | | |
|--------------------------------------|-------------|-------|--|------------------|
| S.NO. | PARTICULARS | | | AREA (SQMT) |
| P5 | 1.335 X | 0.400 | | = 0.534 |
| P6 | 0.900 X | 0.400 | | = 0.360 |
| C1 | 1.335 X | 0.855 | | = 1.141 |
| C2 | 0.625 X | 0.810 | | = 0.506 |
| C3 | 0.900 X | 0.410 | | = 0.369 |
| TOTAL (B) | | | | = 2.911 |
| TOTAL F.A.R. AREA C = (A - B) | | | | = 105.046 |

| 1/4 F.A.R. AREA OF BALCONY | | | | |
|---|-------------|-------|--|------------------|
| S.NO. | PARTICULARS | | | AREA (SQMT) |
| R1 | 0.025 X | 1.850 | | = 0.046 |
| R2 | 11.805 X | 0.025 | | = 0.295 |
| R3 | 2.600 X | 0.025 | | = 0.065 |
| TOTAL AREA (D) | | | | = 0.406 |
| 1/4 BALCONY F.A.R. AREA (E) | | | | = 0.102 |
| TOTAL UNIT F.A.R. AREA F = (C + E) | | | | = 105.148 |

| NON F.A.R. AREA OF BALCONY | | | | |
|------------------------------------|-------------|-------|--|-----------------|
| S.NO. | PARTICULARS | | | AREA (SQMT) |
| Y1 | 1.500 X | 1.850 | | = 2.775 |
| Y2 | 11.805 X | 1.500 | | = 17.708 |
| Y3 | 2.600 X | 1.500 | | = 3.900 |
| 3/4 AREA OF BALCONY (D - E) | | | | = 0.305 |
| TOTAL BALCONY AREA (G) | | | | = 24.687 |

| AREA SUBTRACTION | | | | |
|--------------------------------------|-------------|-------|--|-----------------|
| S.NO. | PARTICULARS | | | AREA (SQMT) |
| C4 | 0.285 X | 0.200 | | = 0.057 |
| C5 | 0.400 X | 0.250 | | = 0.100 |
| TOTAL (H) | | | | = 0.157 |
| TOTAL F.A.R. AREA J = (G - H) | | | | = 24.530 |


| 15% SERVICES AREA OF UNIT (PLUMBING SHAFT) | | | | |
|--|-------------|-------|--|----------------|
| S.NO. | PARTICULARS | | | AREA (SQMT) |
| P5 | 1.335 X | 0.400 | | = 0.534 |
| P6 | 0.900 X | 0.400 | | = 0.360 |
| TOTAL 15% SERVICES AREA OF UNIT (K) | | | | = 0.894 |

| COVERED AREA FOR UNIT = (F + J + K) | | | | |
|-------------------------------------|-------------------------------|--|--|------------------|
| S.NO. | PARTICULARS | | | AREA (SQMT) |
| 1 | TOTAL UNIT F.A.R. AREA (F) | | | = 105.148 |
| 2 | NON F.A.R. AREA OF UNIT (J) | | | = 24.530 |
| 3 | 15% SERVICES AREA OF UNIT (K) | | | = 0.894 |
| TOTAL UNIT COVERAGE AREA | | | | = 130.572 |

| 15% SERVICES AREA OF UNIT (PLUMBING SHAFT) | | | | |
|--|-------------|-------|--|----------------|
| S.NO. | PARTICULARS | | | AREA (SQMT) |
| P1 | 0.250 X | 0.800 | | = 0.200 |
| P2 | 1.245 X | 0.400 | | = 0.498 |
| P3 | 0.900 X | 0.400 | | = 0.360 |
| P4 | 0.900 X | 0.350 | | = 0.315 |
| TOTAL 15% SERVICES AREA OF UNIT (K) | | | | = 1.373 |

| COVERED AREA FOR UNIT = (F + J + K) | | | | |
|-------------------------------------|-------------------------------|--|--|------------------|
| S.NO. | PARTICULARS | | | AREA (SQMT) |
| 1 | TOTAL UNIT F.A.R. AREA (F) | | | = 143.470 |
| 2 | NON F.A.R. AREA OF UNIT (J) | | | = 31.217 |
| 3 | 15% SERVICES AREA OF UNIT (K) | | | = 1.373 |
| TOTAL UNIT COVERAGE AREA | | | | = 176.060 |

2ND TO 18TH, 20TH TO 28TH & 30TH TO 34TH FLOOR PLAN (TYPICAL)

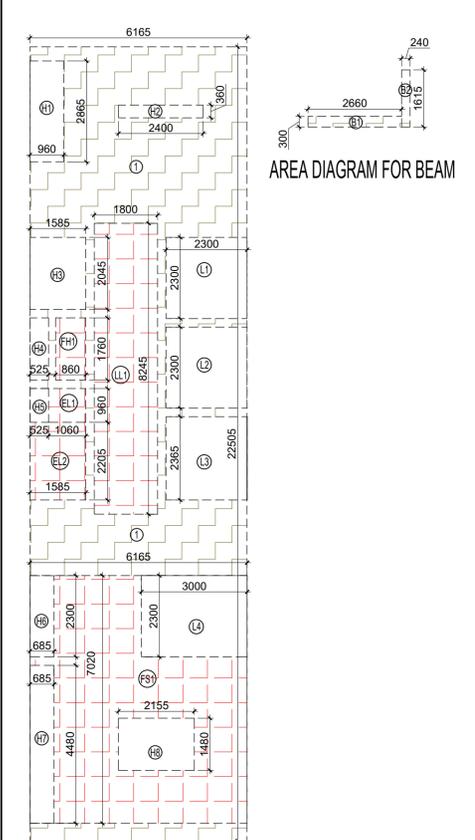


AREA DIAGRAM FOR TYPICAL FLOOR CIRCULATION AREA

| F.A.R. COVERED AREA CALCULATION FOR CIRCULATION AREA | | | | |
|--|-------------|--------|--|------------------|
| S.NO. | PARTICULARS | | | AREA (SQMT) |
| B1 | 6.165 X | 22.505 | | = 138.743 |
| B2 | 2.660 X | 0.300 | | = 0.798 |
| B3 | 0.240 X | 1.615 | | = 0.388 |
| TOTAL AREA (A) | | | | = 139.929 |


| CORRIDOR AREA CALCULATION TOWARDS 15% ADDITIONAL F.A.R. | | | | |
|--|-------------|-------|--|-----------------|
| S.NO. | PARTICULARS | | | AREA (SQMT) |
| FS1 | 6.165 X | 7.020 | | = 43.278 |
| LL1 | 1.800 X | 8.245 | | = 14.841 |
| EL1 | 1.060 X | 0.900 | | = 0.954 |
| EL2 | 1.585 X | 2.205 | | = 3.495 |
| ELV | 1.060 X | 0.900 | | = 0.954 |
| FHC SHAFT | 0.860 X | 1.760 | | = 1.514 |
| TOTAL CORRIDOR AREA CALCULATION TOWARDS 15% ADDITIONAL F.A.R. (A) | | | | = 64.082 |

| TOTAL F.A.R. AREA AT 2ND TO 18TH, 20TH TO 28TH & 30TH 34TH FLOOR PLAN (TYPICAL) | | | | | |
|---|--------------------------------|---|---|------------------|-----------|
| S.NO. | PARTICULARS | | | AREA (SQMT) | |
| 1 | F.A.R. AREA OF UNIT - 1 | 2 | X | 143.470 | = 286.940 |
| 2 | F.A.R. AREA OF UNIT - 2 | 2 | X | 105.148 | = 210.296 |
| 3 | F.A.R. AREA OF CIRCULATION | 1 | X | 51.549 | = 51.549 |
| 4 | F.A.R. AREA OF CONNECTING BEAM | | | = 2.754 | |
| TOTAL F.A.R. AREA | | | | = 551.539 | |


| TOTAL NON F.A.R. AREA AT 2ND TO 18TH, 20TH TO 28TH & 30TH TO 34TH FLOOR PLAN (TYPICAL) | | | | |
|--|-------------|----------|---|------------------|
| S.NO. | PARTICULARS | | | AREA (SQMT) |
| 1 | UNIT - 1 | 31.217 X | 2 | = 62.433 |
| 2 | UNIT - 2 | 24.530 X | 2 | = 49.061 |
| TOTAL BALCONY AREA | | | | = 111.494 |

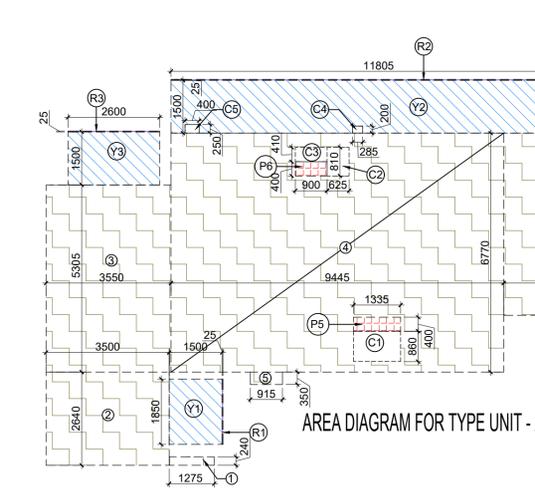

| | | |
|---|---|------------------------------|
| OWNER SIGN Rajat pathak 2025.01.2 3 12:07:20 +05'30' | ARCHITECT SIGN AVANI SRIVASTAVA 2025.01.2 3 12:07:30 +05'30' | |
| TOWN PLANNER SIGN | | |
| DOOR SCHEDULE | | |
| WINDOW SCHEDULE | | |
| LEGEND | | |
| OWNER GODREJ PROPERTIES LIMITED | | |
| SUBMISSION DRAWING | | |
| KEY PLAN | | |
| PROJECT PROPOSED GROUP HOUSING FOR PLOT NO. :- GH-01/B,C,D,E,J & K SECTOR-12, GREATER NOIDA, G.B. NAGAR, (U.P.) | | |
| DATE 08 - 01 - 2025 | PROJECT INCH. BALRAJ SINGH | CHECKED BY BALRAJ SINGH |
| SCALE 1:100 | DEALT BY ABDHESH JHA | APPROVED BY VISHAL SHARMA |
| DRAWING TITLE 2ND TO 18TH, 20TH TO 28TH & 30TH TO 34TH FLOOR PLAN (TYPICAL) | | |
| TOWER-1 | | |
| ARCHITECTS GOLDEN INDIA ARCHITECTS THE TEAM OF ARCHITECTS FF-37, KADAMBA SHOPPING COMPLEX GAMMA-1 GREATER NOIDA CON. +91-94-1585-6777 | | |
| DESIGN BY: Confluence NEW DELHI, INDIA | | |
| F-1, FIRST FLOOR, MIRA CORPORATE SUITES, ISHWAR NAGAR, NEW DELHI 110065 | | |
| Ph- +91-11-26925684 | ccs@inconfluence.com | Member of IGCBC |
| Ph- +91-11-40564768 | www.inconfluence.com | ISO - 9001:2000 |
| architecture | urban design | hospitality |
| interiors | | |
| DRAWING NO. S-11 | REVISION | |

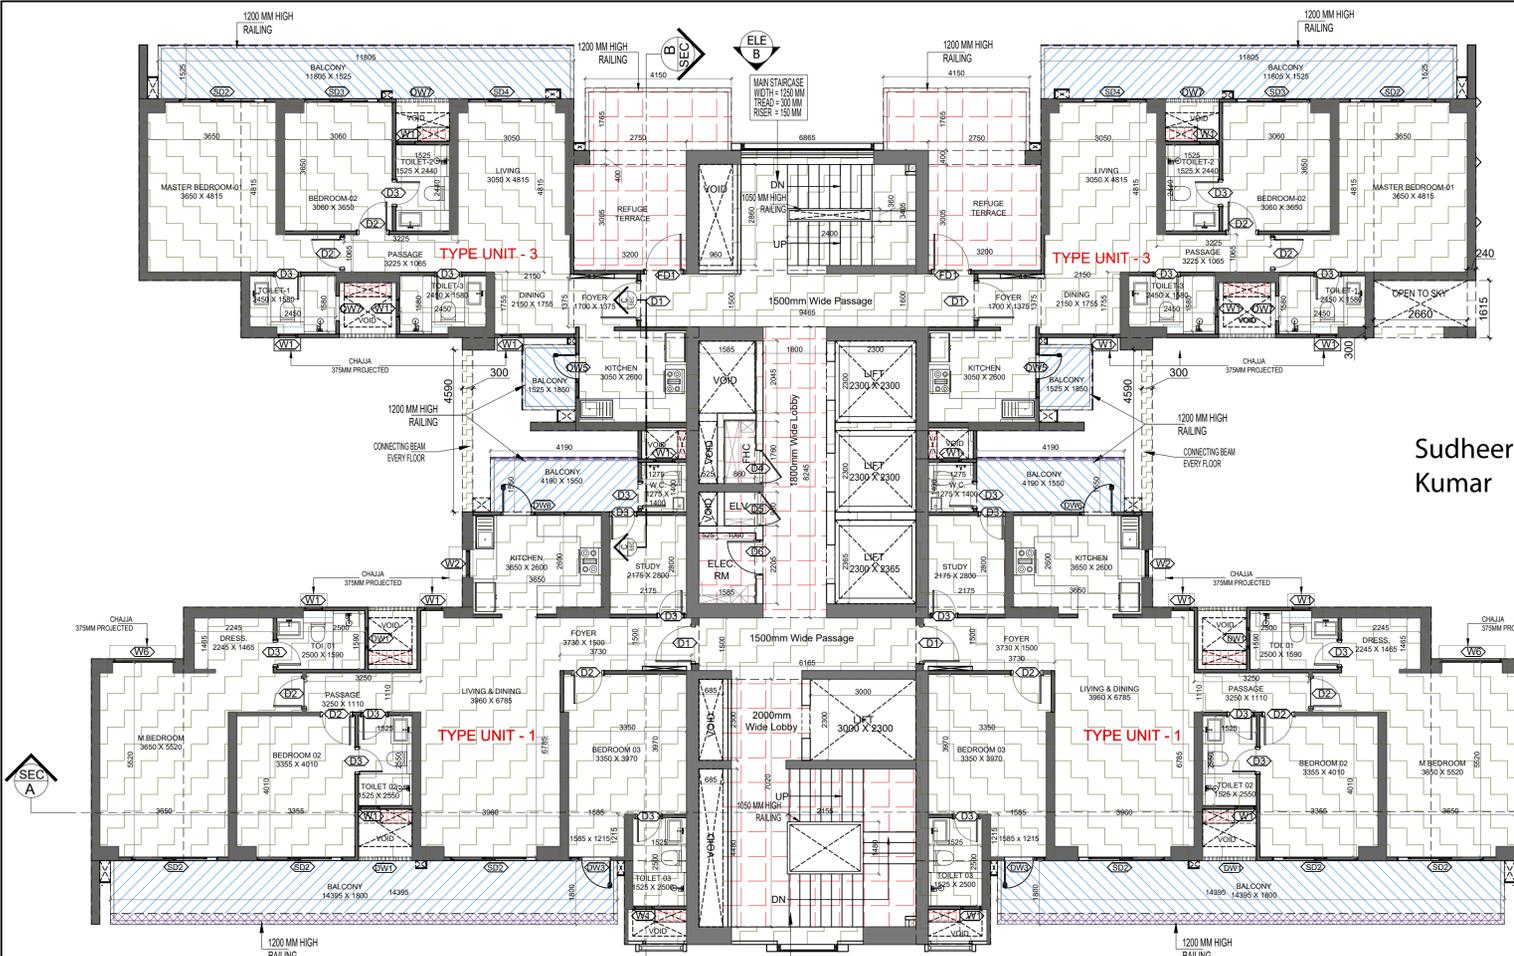

19TH & 29TH FLOOR PLAN (REFUGE LVL.)

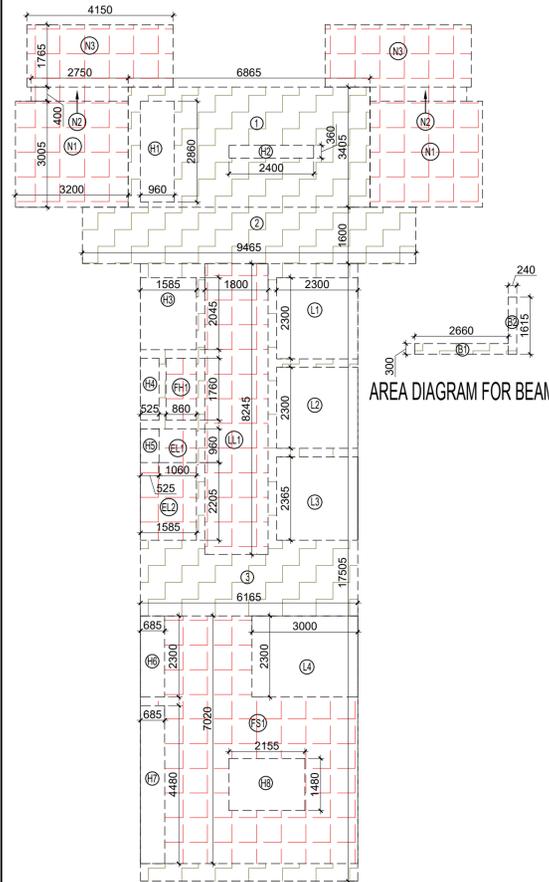


AREA DIAGRAM FOR BEAM

| F.A.R. COVERED AREA CALCULATION FOR CIRCULATION AREA | | | |
|--|----------------|---|-------------|
| S.NO. | PARTICULARS | | AREA (SQMT) |
| 1 | 6.865 X 3.405 | = | 23.375 |
| 2 | 9.465 X 1.600 | = | 15.144 |
| 3 | 6.165 X 17.505 | = | 107.918 |
| B1 | 2.660 X 0.300 | = | 0.798 |
| B2 | 0.240 X 1.815 | = | 0.388 |
| TOTAL AREA (A) | | | 147.623 |
| AREA SUBTRACTION | | | |
| FS1 | 6.165 X 7.020 | = | 43.278 |
| LL1 | 1.800 X 8.245 | = | 14.841 |
| FH1 | 0.860 X 1.780 | = | 1.514 |
| EL1 | 1.060 X 0.900 | = | 0.954 |
| EL2 | 1.585 X 2.205 | = | 3.495 |
| L1 | 2.300 X 2.300 | = | 5.290 |
| L2 | 2.300 X 2.300 | = | 5.290 |
| L3 | 2.300 X 2.385 | = | 5.440 |
| H1 | 0.960 X 2.880 | = | 2.748 |
| H2 | 2.460 X 0.360 | = | 0.884 |
| H3 | 1.585 X 2.045 | = | 3.241 |
| H4 | 0.525 X 1.780 | = | 0.924 |
| H5 | 0.525 X 0.990 | = | 0.504 |
| TOTAL (B) | | | 88.369 |
| TOTAL F.A.R. AREA CORRIDOR C = (A - B) | | | 59.243 |

| CORRIDOR AREA CALCULATION TOWARDS 15% ADDITIONAL F.A.R. | | | |
|--|-------------------|---|-------------|
| S.NO. | PARTICULARS | | AREA (SQMT) |
| FIRE TOWER AREA | | | |
| FS1 | 6.165 X 7.020 | = | 43.278 |
| LIFT LOBBY | | | |
| LL1 | 1.800 X 8.245 | = | 14.841 |
| ELECTRIC | | | |
| EL1 | 1.060 X 0.900 | = | 0.954 |
| ELV | | | |
| EL2 | 1.585 X 2.205 | = | 3.495 |
| FHC SHAFT | | | |
| FH1 | 0.860 X 1.780 | = | 1.514 |
| REFUGE AREA | | | |
| N1 | 3.200 X 3.005 X 2 | = | 19.232 |
| N2 | 2.750 X 0.400 X 2 | = | 2.200 |
| N3 | 4.150 X 1.785 X 2 | = | 14.850 |
| TOTAL CORRIDOR AREA CALCULATION TOWARDS 15% ADDITIONAL F.A.R. | | | 100.163 |
| UNIT AREA CALCULATION TOWARDS 15% ADDITIONAL F.A.R. | | | |
| PLUMBING SHAFT | | | |
| P1 | 0.250 X 0.800 X 2 | = | 0.400 |
| P2 | 1.245 X 0.400 X 2 | = | 0.996 |
| P3 | 0.900 X 0.400 X 2 | = | 0.720 |
| P4 | 0.900 X 0.350 X 2 | = | 0.630 |
| P5 | 1.335 X 0.400 X 2 | = | 1.068 |
| P6 | 0.900 X 0.400 X 2 | = | 0.720 |
| TOTAL UNIT AREA CALCULATION TOWARDS 15% ADDITIONAL F.A.R. (B) | | | 4.334 |
| TOTAL 15% ADDITIONAL F.A.R. AREA (CORRIDOR AREA + UNIT AREA) = (A + B) | | | 104.497 |
| AREA SUBTRACTION | | | |
| L4 | 3.800 X 2.300 | = | 6.800 |
| H6 | 0.865 X 2.300 | = | 1.978 |
| H7 | 0.685 X 4.480 | = | 3.069 |
| H8 | 2.155 X 1.480 | = | 3.189 |
| TOTAL AREA (D) | | | 14.734 |
| TOTAL 15% ADDITIONAL F.A.R. AREA E = (C - D) | | | 89.864 |

| TOTAL F.A.R. AREA AT 19TH & 29TH FLOOR PLAN (REFUGE LVL.) | | | |
|---|--------------------------------|---|-------------|
| S.NO. | PARTICULARS | | AREA (SQMT) |
| 1 | F.A.R. AREA OF UNIT -1 | 2 | 286.940 |
| 2 | F.A.R. AREA OF UNIT -3 | 2 | 181.204 |
| 3 | F.A.R. AREA OF CIRCULATION | 1 | 59.243 |
| 4 | F.A.R. AREA OF CONNECTING BEAM | | 2.754 |
| TOTAL F.A.R. AREA | | | 530.141 |


| TOTAL NON F.A.R. AREA AT 19TH & 29TH FLOOR PLAN (REFUGE LVL.) | | | |
|---|-------------|---|-------------|
| S.NO. | PARTICULARS | | AREA (SQMT) |
| 1 | UNIT -1 | 2 | 62.433 |
| 2 | UNIT -3 | 2 | 41.163 |
| TOTAL BALCONY AREA | | | 103.596 |

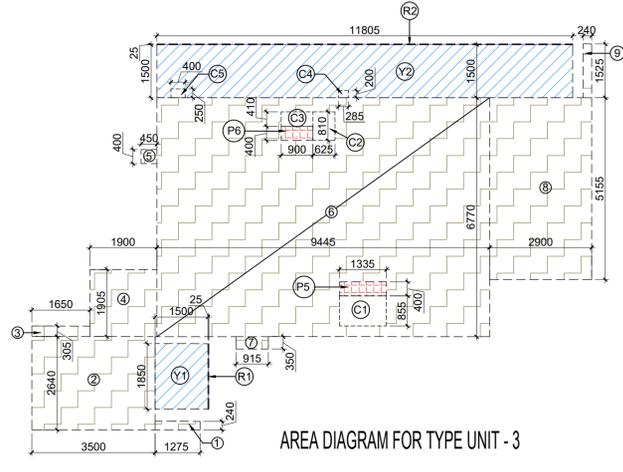

AREA DIAGRAM FOR TYPE UNIT -3

Amit Varma
Digitally signed by Amit Varma
Date: 2025.01.25 17:33:45 +05'30'


Sudheer Kumar
Digitally signed by Sudheer Kumar
Date: 2025.01.28 14:02:48 +05'30'

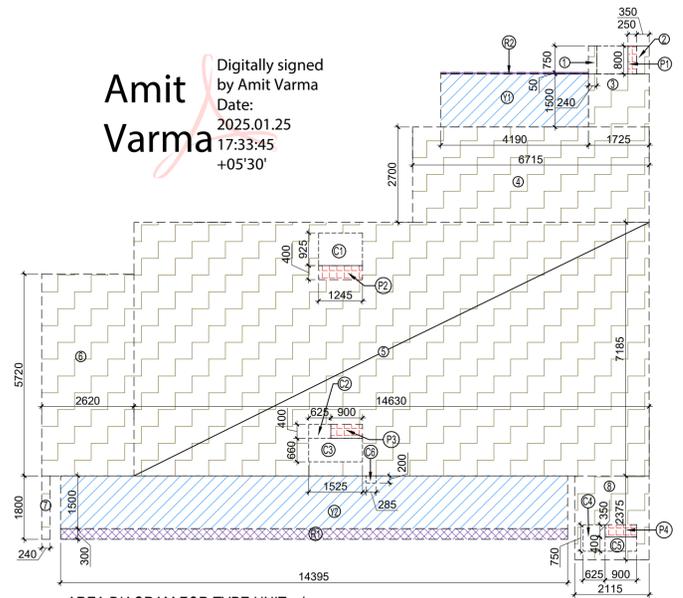

AREA DIAGRAM FOR TYPE UNIT -1

REFUGE AREA REQUIRED -
- 716.915 SQMTR (BLDG. PLATE) X 2 FLOORS X 0.3
= 430.149 SQMTR (for specified)
= 36.312 SQMTR (SAY - 36.00) SQMTR.
REFUGE AREA PROPOSED = 36.082 SQMTR

| F.A.R. AREA AT CONNECTING BEAM (EVERY FLOOR) | | | | |
|--|-------------------|---|--|-------------|
| S.NO. | PARTICULARS | | | AREA (SQMT) |
| 1 | 0.300 X 4.590 X 2 | = | | 2.754 |
| TOTAL F.A.R. AREA | | | | 2.754 |

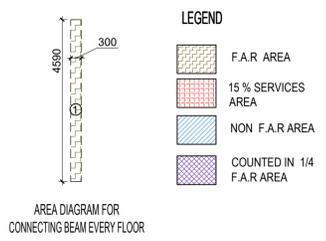

AREA DIAGRAM FOR CONNECTING BEAM EVERY FLOOR

| F.A.R. COVERED AREA CALCULATION FOR TYPE UNIT -3 | | | |
|--|----------------|---|-------------|
| S.NO. | PARTICULARS | | AREA (SQMT) |
| 1 | 1.275 X 0.240 | = | 0.306 |
| 2 | 3.500 X 2.640 | = | 9.240 |
| 3 | 1.650 X 0.305 | = | 0.503 |
| 4 | 1.900 X 1.905 | = | 3.620 |
| 5 | 4.450 X 0.400 | = | 1.780 |
| 6 | 9.445 X 6.770 | = | 63.943 |
| 7 | 0.915 X 0.350 | = | 0.320 |
| 8 | 2.900 X 5.155 | = | 14.950 |
| 9 | 0.240 X 1.525 | = | 0.366 |
| UNIT F.A.R. AREA = (A) | | | 93.427 |
| AREA SUBTRACTION PLUMBING CUTOFF | | | |
| P5 | 1.335 X 0.400 | = | 0.534 |
| P6 | 0.900 X 0.400 | = | 0.360 |
| C1 | 1.335 X 0.855 | = | 1.141 |
| C2 | 0.625 X 0.810 | = | 0.506 |
| C3 | 0.900 X 0.410 | = | 0.369 |
| TOTAL (B) | | | 2.911 |
| TOTAL F.A.R. AREA C = (A - B) | | | 90.516 |
| 1/4 F.A.R. AREA OF BALCONY | | | |
| R1 | 0.025 X 1.850 | = | 0.046 |
| R2 | 11.805 X 0.025 | = | 0.295 |
| TOTAL AREA (D) | | | 0.341 |
| 1/4 BALCONY F.A.R. AREA (E) | | | 0.085 |
| TOTAL UNIT F.A.R. AREA F = (C + E) | | | 90.602 |

| NON F.A.R. AREA OF BALCONY | | | |
|-------------------------------|----------------|---|-------------|
| S.NO. | PARTICULARS | | AREA (SQMT) |
| Y1 | 1.500 X 1.850 | = | 2.775 |
| Y2 | 11.805 X 1.500 | = | 17.708 |
| 3/4 AREA OF BALCONY (D - E) | | | 0.256 |
| TOTAL BALCONY AREA (G) | | | 20.739 |
| AREA SUBTRACTION | | | |
| C4 | 0.285 X 0.200 | = | 0.057 |
| C5 | 0.400 X 0.250 | = | 0.100 |
| TOTAL (H) | | | 0.157 |
| TOTAL F.A.R. AREA J = (G - H) | | | 20.582 |

| 15% SERVICES AREA OF UNIT (PLUMBING SHAFT) | | | |
|--|-------------------------------|---|-------------|
| S.NO. | PARTICULARS | | AREA (SQMT) |
| P5 | 1.335 X 0.400 | = | 0.534 |
| P6 | 0.900 X 0.400 | = | 0.360 |
| TOTAL 15% SERVICES AREA OF UNIT (K) | | | 0.894 |
| COVERED AREA FOR UNIT = (F + J + K) | | | |
| 1 | TOTAL UNIT F.A.R. AREA (F) | = | 90.602 |
| 2 | NON F.A.R. AREA OF UNIT (J) | = | 20.582 |
| 3 | 15% SERVICES AREA OF UNIT (K) | = | 0.894 |
| TOTAL UNIT COVERED AREA | | | 112.077 |

| F.A.R. COVERED AREA CALCULATION FOR UNIT -1 | | | |
|---|----------------|---|-------------|
| S.NO. | PARTICULARS | | AREA (SQMT) |
| 1 | 0.240 X 0.800 | = | 0.192 |
| 2 | 0.350 X 0.800 | = | 0.280 |
| 3 | 1.725 X 1.500 | = | 2.588 |
| 4 | 6.715 X 2.700 | = | 18.131 |
| 5 | 14.630 X 7.185 | = | 105.117 |
| 6 | 2.620 X 5.720 | = | 14.986 |
| 7 | 0.240 X 1.800 | = | 0.432 |
| 8 | 2.115 X 2.375 | = | 5.023 |
| UNIT F.A.R. AREA = (A) | | | 146.748 |
| AREA SUBTRACTION PLUMBING CUTOFF | | | |
| P2 | 1.245 X 0.400 | = | 0.498 |
| P3 | 0.900 X 0.400 | = | 0.360 |
| P4 | 0.900 X 0.350 | = | 0.315 |
| C1 | 1.245 X 0.925 | = | 1.152 |
| C2 | 0.625 X 0.400 | = | 0.250 |
| C3 | 1.525 X 0.660 | = | 1.007 |
| C4 | 0.625 X 0.750 | = | 0.469 |
| C5 | 0.900 X 0.400 | = | 0.360 |
| TOTAL (B) | | | 4.410 |
| TOTAL F.A.R. AREA C = (A - B) | | | 142.338 |
| 1/4 F.A.R. AREA OF BALCONY | | | |
| R1 | 14.395 X 0.300 | = | 4.319 |
| R2 | 4.190 X 0.050 | = | 0.210 |
| TOTAL AREA (D) | | | 4.528 |
| 1/4 BALCONY F.A.R. AREA (E) | | | 1.132 |
| TOTAL UNIT F.A.R. AREA F = (C + E) | | | 143.470 |

| NON F.A.R. AREA OF BALCONY | | | |
|-------------------------------|----------------|---|-------------|
| S.NO. | PARTICULARS | | AREA (SQMT) |
| Y1 | 4.190 X 1.500 | = | 6.285 |
| Y2 | 14.395 X 1.500 | = | 21.593 |
| 3/4 AREA OF BALCONY (D - E) | | | 3.306 |
| TOTAL BALCONY AREA (G) | | | 31.274 |
| AREA SUBTRACTION | | | |
| C6 | 0.285 X 0.200 | = | 0.057 |
| TOTAL (H) | | | 0.057 |
| TOTAL F.A.R. AREA J = (G - H) | | | 31.217 |

| 15% SERVICES AREA OF UNIT (PLUMBING SHAFT) | | | |
|--|-------------------------------|---|-------------|
| S.NO. | PARTICULARS | | AREA (SQMT) |
| P1 | 0.250 X 0.800 | = | 0.200 |
| P2 | 1.245 X 0.400 | = | 0.498 |
| P3 | 0.900 X 0.400 | = | 0.360 |
| P4 | 0.900 X 0.350 | = | 0.315 |
| TOTAL 15% SERVICES AREA OF UNIT (K) | | | 1.373 |
| COVERED AREA FOR UNIT = (F + J + K) | | | |
| 1 | TOTAL UNIT F.A.R. AREA (F) | = | 143.470 |
| 2 | NON F.A.R. AREA OF UNIT (J) | = | 31.217 |
| 3 | 15% SERVICES AREA OF UNIT (K) | = | 1.373 |
| TOTAL UNIT COVERED AREA | | | 176.060 |

OWNER SIGN: **Rajat pathak**
Rajat pathak
2025.01.23 12:08:36 +05'30'

ARCHITECT SIGN: **AVANISH SRIVASTAV**
AVANISH SRIVASTAV
2025.01.23 12:08:27 +05'30'

| DOOR SCHEDULE | |
|---------------|-----------------------|
| S.NO. | DESCRIPTION |
| 1 | UPVC FRAME GLASS DOOR |
| 2 | UPVC FRAME GLASS DOOR |
| 3 | UPVC FRAME GLASS DOOR |
| 100 | UPVC FRAME GLASS DOOR |

| WINDOW SCHEDULE | |
|-----------------|-------------------------|
| S.NO. | DESCRIPTION |
| 1 | UPVC FRAME GLASS WINDOW |
| 2 | UPVC FRAME GLASS WINDOW |
| 3 | UPVC FRAME GLASS WINDOW |
| 73 | UPVC FRAME GLASS WINDOW |

OWNER SIGN
Rajat pathak
2025.01.23
12:11:07
+05'30'

ARCHITECT SIGN
AVANISH SRIVASTAVA
SH SRIVA STAV
2025.01.25
3:12:10.55
+05'30'

TOWN PLANNER SIGN

Digitally signed by LAL SINGH
Date: 2025.01.27
17:29:44
+05'30'


Digitally signed by Amit Varma
Date: 2025.01.25
16:39:57 +05'30'

Digitally signed by Sudheer Kumar
Date: 2025.01.28
14:05:45 +05'30'

LAL SINGH

Amit Varma


Sudheer Kumar

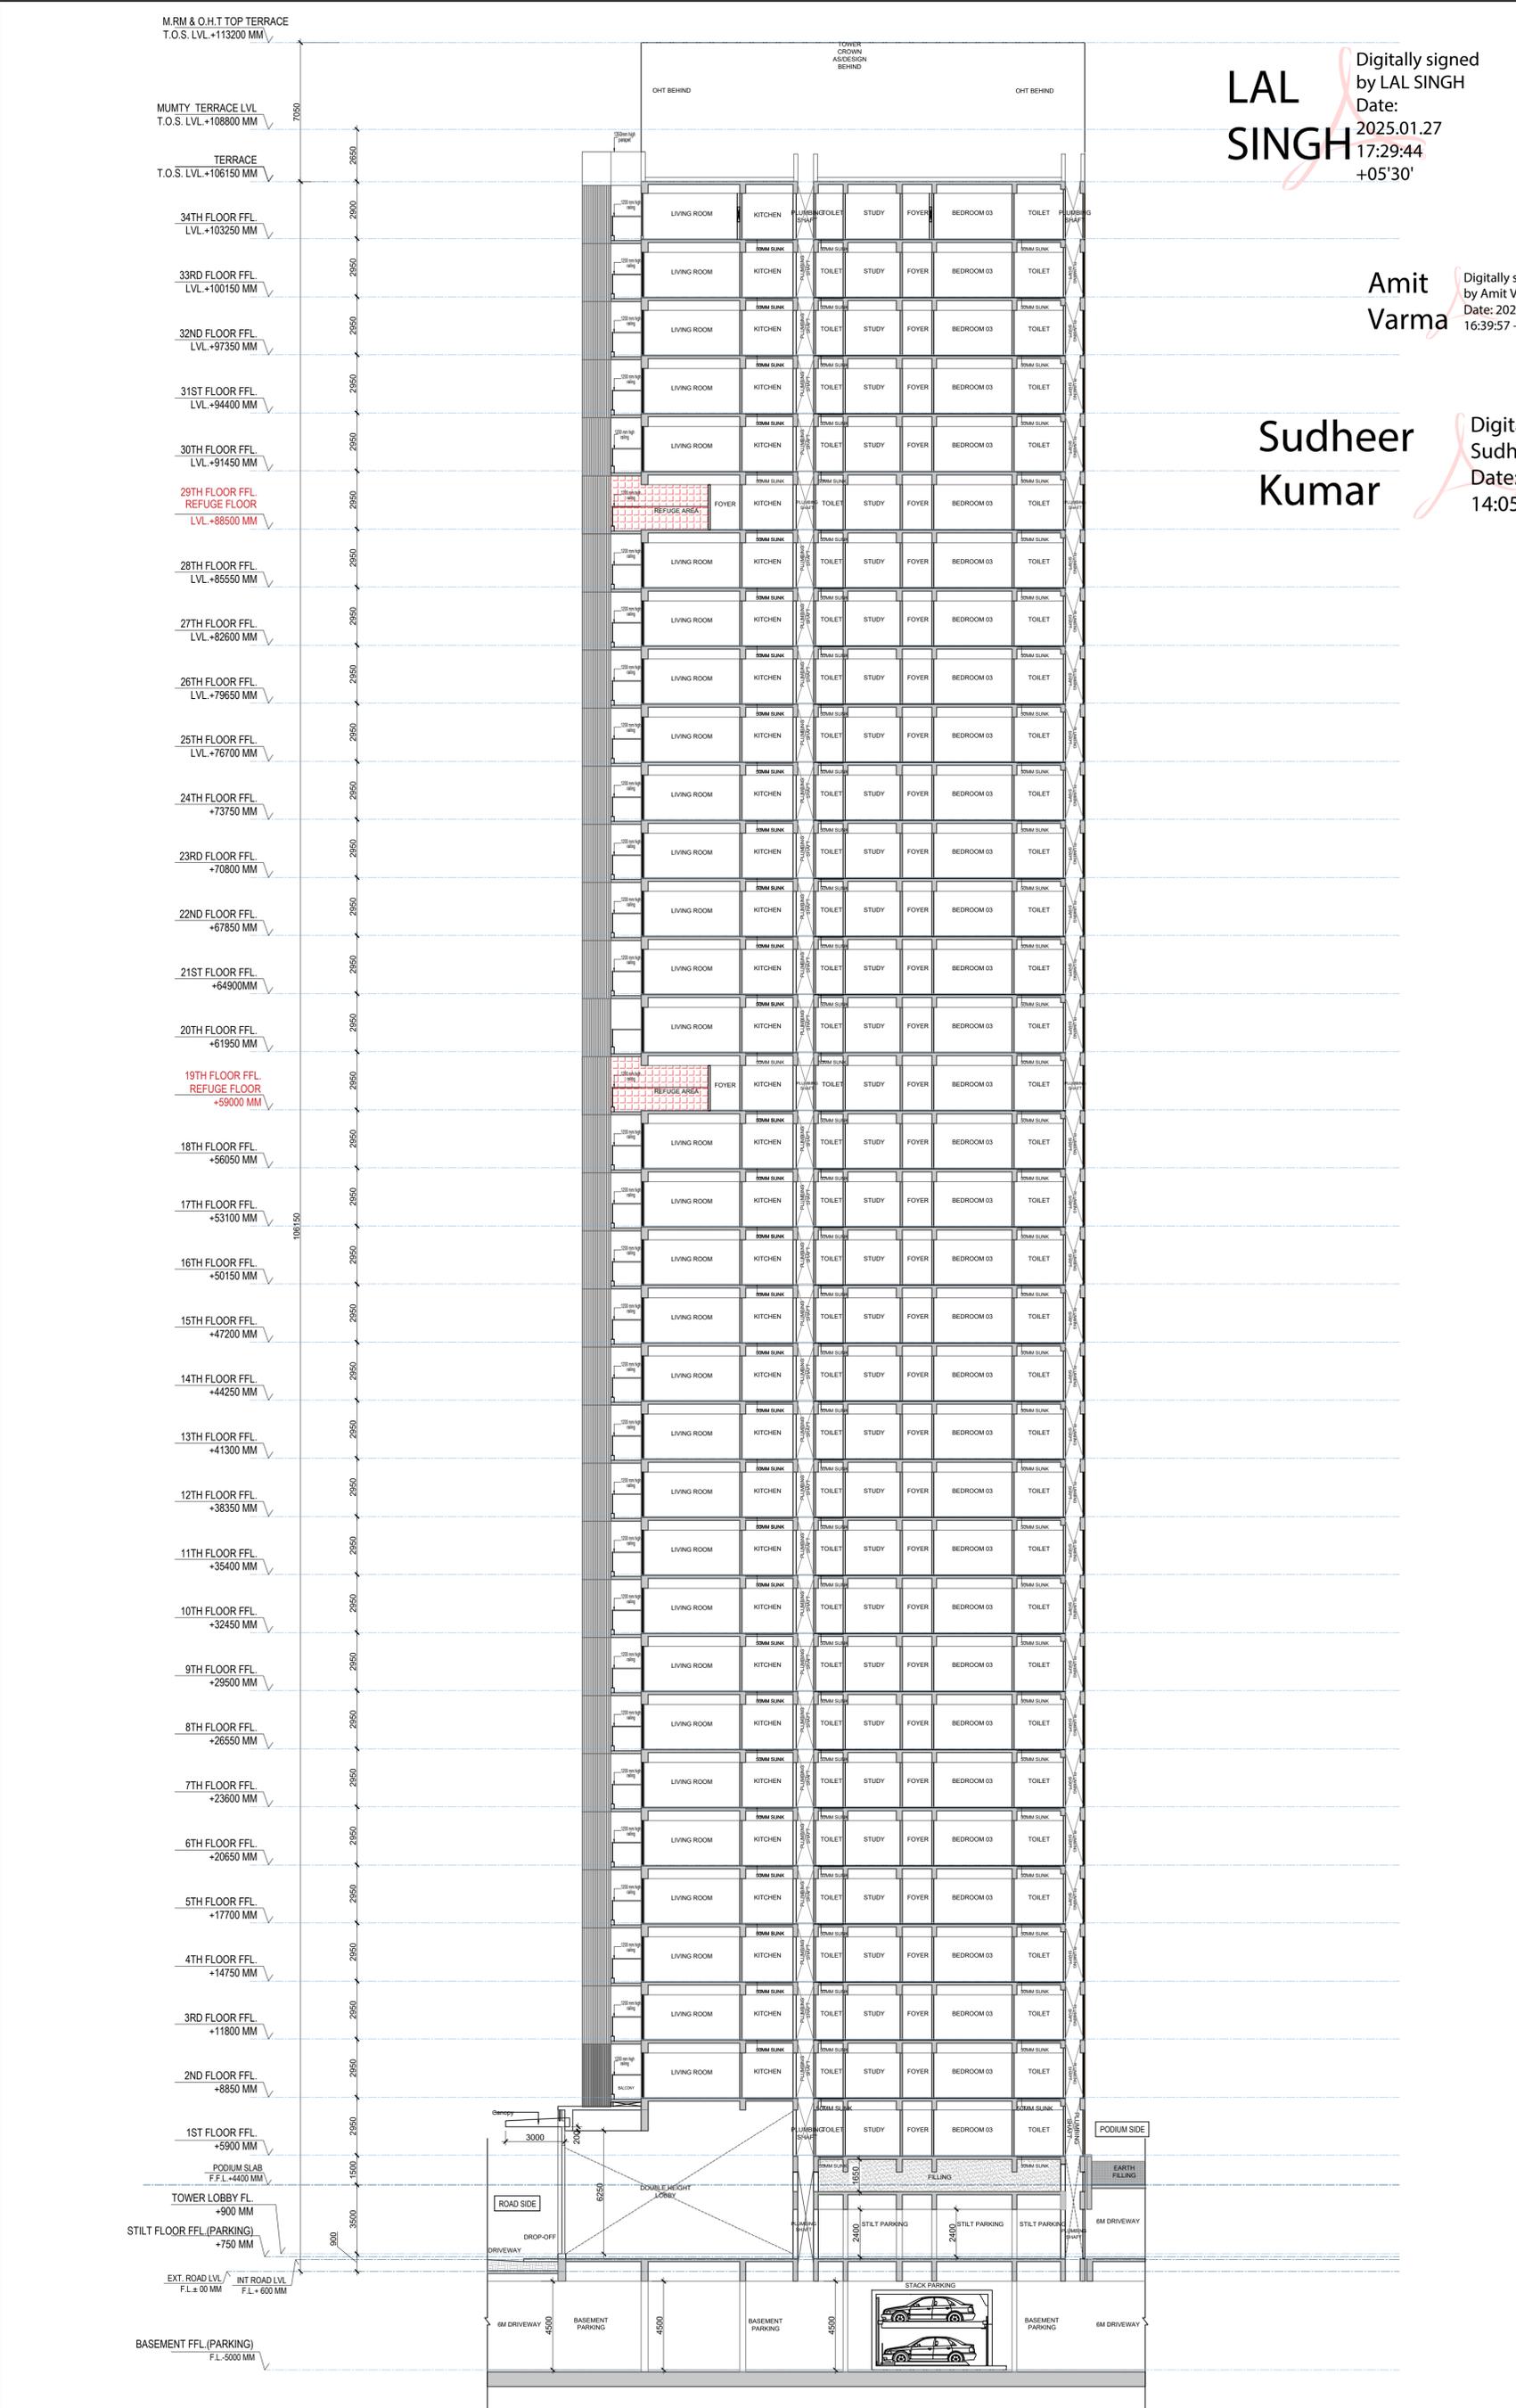

SECTION - BB'

OWNER
GODREJ PROPERTIES LIMITED

SUBMISSION DRAWING

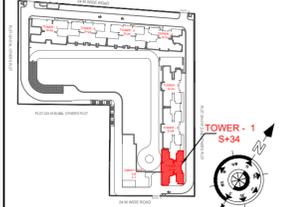

PROJECT
PROPOSED GROUP HOUSING FOR
PLOT NO. :- GH-01/B.C.D.E.J & K SECTOR -12,
GREATER NOIDA, G.B. NAGAR, (U.P.)

| | | |
|-----------------------|-------------------------------|------------------------------|
| DATE 08 - 01 -2025 | PROJECT INCH. BALRAJ SINGH | CHECKED BY BALRAJ SINGH |
| SCALE 1:100 | DEALT BY ABDRESH JHA | APPROVED BY VISHAL SHARMA |

DRAWING TITLE
SECTION - B-B'


TOWER - 1

ARCHITECTS
GOLDEN INDIA ARCHITECTS
THE TEAM OF ARCHITECTS
FF-37, KADAMBA SHOPPING COMPLEX
GAMMA-IGREATER NOIDA
CON...+91-94-1585-6777


DESIGN BY:
Confluence
NEW DELHI, INDIA
F-1, FIRST FLOOR, MIRA CORPORATE SUITES,
ISHWAR NAGAR, NEW DELHI 110065

PH: +91-11-26925684 ccs@confluence.com Member of IGBC
P: +91-11-40564768 www.confluence.com ISO - 9001 : 2000
architecture urban design hospitality Interiors

DRAWING NO. S-17 REVISION

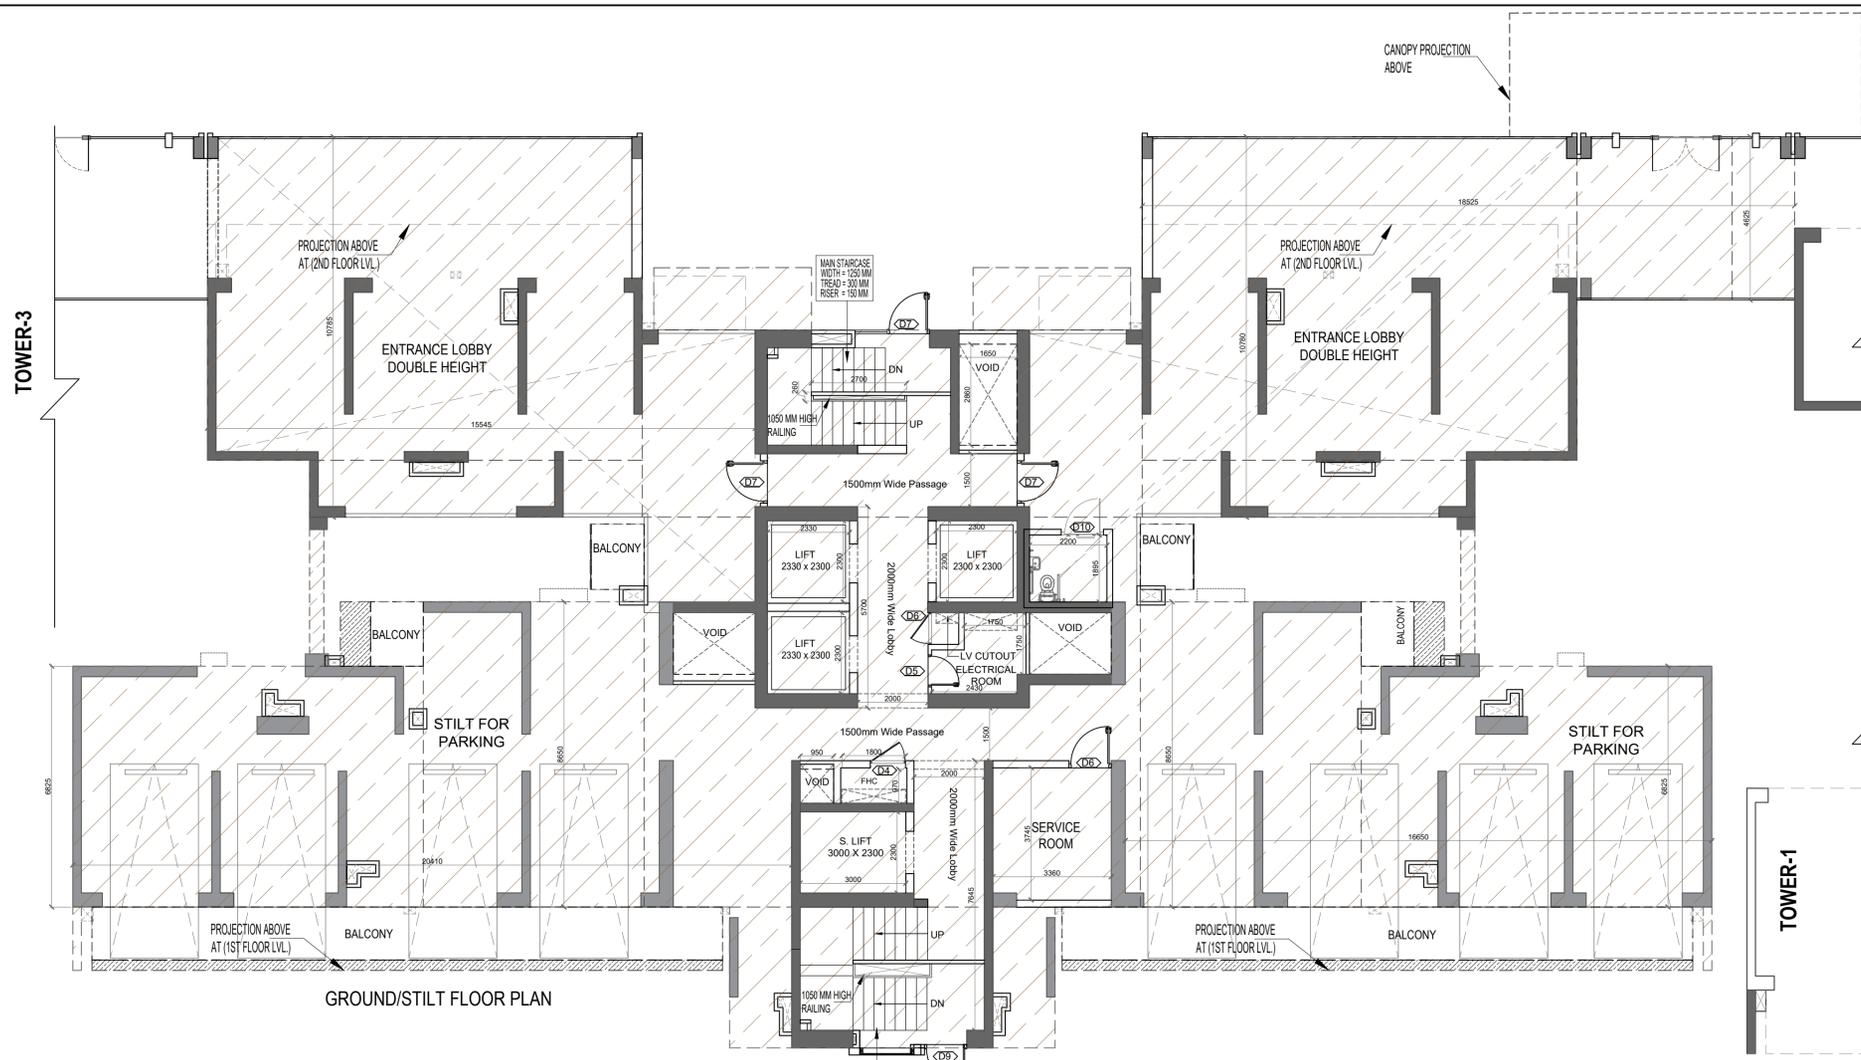


GROUND/STILT FLOOR PLAN

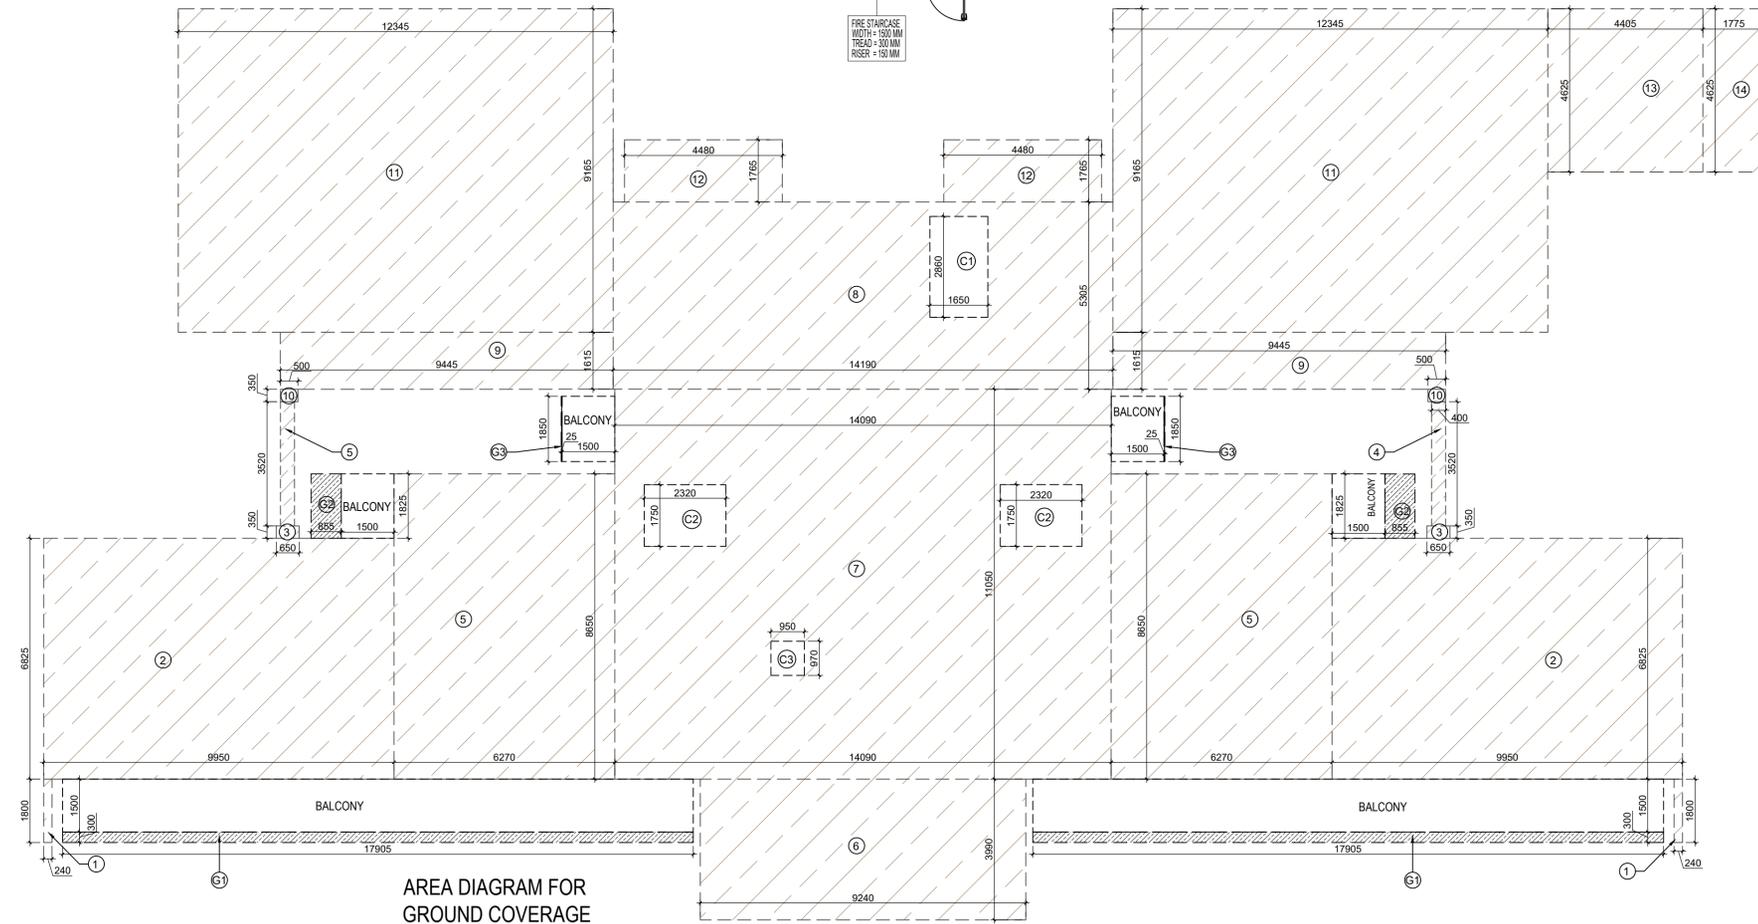

AREA DIAGRAM FOR GROUND COVERAGE

LAL SINGH
Digitally signed by LAL SINGH
Date: 2025.01.27 17:30:08 +05'30'

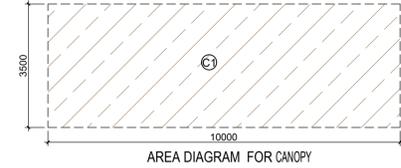

AREA DIAGRAM FOR CANOPY

Amit Varma
Digitally signed by Amit Varma
Date: 2025.01.25 16:40:51 +05'30'


Sudheer Kumar
Digitally signed by Sudheer Kumar
Date: 2025.01.28 14:06:24 +05'30'

LEGEND


| AREA CALCULATION FOR GROUND COVERAGE | | | | | | |
|--------------------------------------|-------------|---|--------|---|-------------|------------------|
| S.NO. | PARTICULARS | | | | AREA (SQMT) | |
| 1 | 0.240 | X | 1.800 | X | 2 | = 0.864 |
| 2 | 9.950 | X | 6.825 | X | 2 | = 135.818 |
| 3 | 0.650 | X | 0.350 | X | 2 | = 0.455 |
| 4 | 0.400 | X | 3.520 | X | 2 | = 2.816 |
| 5 | 6.270 | X | 8.650 | X | 2 | = 108.471 |
| 6 | 9.240 | X | 3.990 | | | = 36.868 |
| 7 | 14.090 | X | 11.050 | | | = 155.695 |
| 8 | 14.190 | X | 5.305 | | | = 75.278 |
| 9 | 9.445 | X | 1.615 | X | 2 | = 30.507 |
| 10 | 0.500 | X | 0.350 | X | 2 | = 0.350 |
| 11 | 12.345 | X | 9.165 | X | 2 | = 226.284 |
| 12 | 4.480 | X | 1.765 | X | 2 | = 15.814 |
| 13 | 4.405 | X | 4.625 | | | = 20.373 |
| 14 | 1.775 | X | 4.625 | | | = 8.209 |
| TOTAL AREA (A) | | | | | | = 817.802 |
| Subtraction | | | | | | |
| C1 | 1.650 | X | 2.860 | | | = 4.719 |
| C2 | 2.320 | X | 1.750 | X | 2 | = 8.120 |
| C3 | 0.950 | X | 0.970 | | | = 0.922 |
| TOTAL AREA (B) | | | | | | = 13.761 |
| TOTAL AREA = C (A-B) | | | | | | = 804.041 |

| 1/4 F.A.R AREA OF BALCONY FOR GROUND COVERAGE | | | | | | |
|--|--------|---|-------|---|---|------------------|
| G1 | 17.905 | X | 0.300 | X | 2 | = 10.743 |
| G2 | 0.855 | X | 1.825 | X | 2 | = 3.121 |
| G3 | 0.025 | X | 1.850 | X | 2 | = 0.093 |
| TOTAL AREA (D) | | | | | | = 13.956 |
| 1/4 BALCONY F.A.R AREA (E) | | | | | | = 3.489 |
| CANOPY AREA (C1) | | | | | | = 35.000 |
| TOTAL GROUND COVERAGE AREA F = (C+E+C1) | | | | | | = 842.530 |

| OWNER SIGN Rajat pathak Rajat pathak 2025.01.23 12:11:37 +05'30' | ARCHITECT SIGN AVANIS SRIVASTAV H SRIVASTAV 2025.01.23 12:11:29 +05'30' | |
|---|
| TOWN PLANNER SIGN | |
| <table border="1"> <thead> <tr> <th>DOOR TYPE</th> <th>SYMBOL</th> <th>HEIGHT</th> <th>RAIL</th> <th>RAILING</th> <th>LOCATION</th> <th>DESCRIPTION</th> </tr> </thead> <tbody> <tr><td>1</td><td>D01</td><td>2100</td><td>2000</td><td>2000</td><td>LUNGS</td><td>UPVC FRAME, 8 PANEL GLASS DOOR</td></tr> <tr><td>2</td><td>D02</td><td>2100</td><td>2000</td><td>2000</td><td>LUNGS</td><td>UPVC FRAME, 8 PANEL GLASS DOOR</td></tr> <tr><td>3</td><td>D03</td><td>2100</td><td>2000</td><td>2000</td><td>LUNGS</td><td>UPVC FRAME, 8 PANEL GLASS DOOR</td></tr> <tr><td>4</td><td>D04</td><td>2100</td><td>2000</td><td>2000</td><td>LUNGS</td><td>UPVC FRAME, 8 PANEL GLASS DOOR</td></tr> <tr><td>5</td><td>D05</td><td>2100</td><td>2000</td><td>2000</td><td>LUNGS</td><td>UPVC FRAME, 8 PANEL GLASS DOOR</td></tr> <tr><td>6</td><td>D06</td><td>2100</td><td>2000</td><td>2000</td><td>LUNGS</td><td>UPVC FRAME, 8 PANEL GLASS DOOR</td></tr> <tr><td>7</td><td>D07</td><td>2100</td><td>2000</td><td>2000</td><td>LUNGS</td><td>UPVC FRAME, 8 PANEL GLASS DOOR</td></tr> <tr><td>8</td><td>D08</td><td>2100</td><td>2000</td><td>2000</td><td>LUNGS</td><td>UPVC FRAME, 8 PANEL GLASS DOOR</td></tr> <tr><td>9</td><td>D09</td><td>2100</td><td>2000</td><td>2000</td><td>LUNGS</td><td>UPVC FRAME, 8 PANEL GLASS DOOR</td></tr> <tr><td>10</td><td>D10</td><td>2100</td><td>2000</td><td>2000</td><td>LUNGS</td><td>UPVC FRAME, 8 PANEL GLASS DOOR</td></tr> <tr><td>11</td><td>D11</td><td>2100</td><td>2000</td><td>2000</td><td>LUNGS</td><td>UPVC FRAME, 8 PANEL GLASS DOOR</td></tr> <tr><td>12</td><td>D12</td><td>2100</td><td>2000</td><td>2000</td><td>LUNGS</td><td>UPVC FRAME, 8 PANEL GLASS DOOR</td></tr> <tr><td>13</td><td>D13</td><td>2100</td><td>2000</td><td>2000</td><td>LUNGS</td><td>UPVC FRAME, 8 PANEL GLASS DOOR</td></tr> <tr><td>14</td><td>D14</td><td>2100</td><td>2000</td><td>2000</td><td>LUNGS</td><td>UPVC FRAME, 8 PANEL GLASS DOOR</td></tr> <tr><td>15</td><td>D15</td><td>2100</td><td>2000</td><td>2000</td><td>LUNGS</td><td>UPVC FRAME, 8 PANEL GLASS DOOR</td></tr> <tr><td>16</td><td>D16</td><td>2100</td><td>2000</td><td>2000</td><td>LUNGS</td><td>UPVC FRAME, 8 PANEL GLASS DOOR</td></tr> <tr><td>17</td><td>D17</td><td>2100</td><td>2000</td><td>2000</td><td>LUNGS</td><td>UPVC FRAME, 8 PANEL GLASS DOOR</td></tr> <tr><td>18</td><td>D18</td><td>2100</td><td>2000</td><td>2000</td><td>LUNGS</td><td>UPVC FRAME, 8 PANEL GLASS DOOR</td></tr> <tr><td>19</td><td>D19</td><td>2100</td><td>2000</td><td>2000</td><td>LUNGS</td><td>UPVC FRAME, 8 PANEL GLASS DOOR</td></tr> <tr><td>20</td><td>D20</td><td>2100</td><td>2000</td><td>2000</td><td>LUNGS</td><td>UPVC FRAME, 8 PANEL GLASS DOOR</td></tr> <tr><td>21</td><td>D21</td><td>2100</td><td>2000</td><td>2000</td><td>LUNGS</td><td>UPVC FRAME, 8 PANEL GLASS DOOR</td></tr> <tr><td>22</td><td>D22</td><td>2100</td><td>2000</td><td>2000</td><td>LUNGS</td><td>UPVC FRAME, 8 PANEL GLASS DOOR</td></tr> <tr><td>23</td><td>D23</td><td>2100</td><td>2000</td><td>2000</td><td>LUNGS</td><td>UPVC FRAME, 8 PANEL GLASS DOOR</td></tr> <tr><td>24</td><td>D24</td><td>2100</td><td>2000</td><td>2000</td><td>LUNGS</td><td>UPVC FRAME, 8 PANEL GLASS DOOR</td></tr> <tr><td>25</td><td>D25</td><td>2100</td><td>2000</td><td>2000</td><td>LUNGS</td><td>UPVC FRAME, 8 PANEL GLASS DOOR</td></tr> <tr><td>26</td><td>D26</td><td>2100</td><td>2000</td><td>2000</td><td>LUNGS</td><td>UPVC FRAME, 8 PANEL GLASS DOOR</td></tr> <tr><td>27</td><td>D27</td><td>2100</td><td>2000</td><td>2000</td><td>LUNGS</td><td>UPVC FRAME, 8 PANEL GLASS DOOR</td></tr> <tr><td>28</td><td>D28</td><td>2100</td><td>2000</td><td>2000</td><td>LUNGS</td><td>UPVC FRAME, 8 PANEL GLASS DOOR</td></tr> <tr><td>29</td><td>D29</td><td>2100</td><td>2000</td><td>2000</td><td>LUNGS</td><td>UPVC FRAME, 8 PANEL GLASS DOOR</td></tr> <tr><td>30</td><td>D30</td><td>2100</td><td>2000</td><td>2000</td><td>LUNGS</td><td>UPVC FRAME, 8 PANEL GLASS DOOR</td></tr> </tbody> </table> | | DOOR TYPE | SYMBOL | HEIGHT | RAIL | RAILING | LOCATION | DESCRIPTION | 1 | D01 | 2100 | 2000 | 2000 | LUNGS | UPVC FRAME, 8 PANEL GLASS DOOR | 2 | D02 | 2100 | 2000 | 2000 | LUNGS | UPVC FRAME, 8 PANEL GLASS DOOR | 3 | D03 | 2100 | 2000 | 2000 | LUNGS | UPVC FRAME, 8 PANEL GLASS DOOR | 4 | D04 | 2100 | 2000 | 2000 | LUNGS | UPVC FRAME, 8 PANEL GLASS DOOR | 5 | D05 | 2100 | 2000 | 2000 | LUNGS | UPVC FRAME, 8 PANEL GLASS DOOR | 6 | D06 | 2100 | 2000 | 2000 | LUNGS | UPVC FRAME, 8 PANEL GLASS DOOR | 7 | D07 | 2100 | 2000 | 2000 | LUNGS | UPVC FRAME, 8 PANEL GLASS DOOR | 8 | D08 | 2100 | 2000 | 2000 | LUNGS | UPVC FRAME, 8 PANEL GLASS DOOR | 9 | D09 | 2100 | 2000 | 2000 | LUNGS | UPVC FRAME, 8 PANEL GLASS DOOR | 10 | D10 | 2100 | 2000 | 2000 | LUNGS | UPVC FRAME, 8 PANEL GLASS DOOR | 11 | D11 | 2100 | 2000 | 2000 | LUNGS | UPVC FRAME, 8 PANEL GLASS DOOR | 12 | D12 | 2100 | 2000 | 2000 | LUNGS | UPVC FRAME, 8 PANEL GLASS DOOR | 13 | D13 | 2100 | 2000 | 2000 | LUNGS | UPVC FRAME, 8 PANEL GLASS DOOR | 14 | D14 | 2100 | 2000 | 2000 | LUNGS | UPVC FRAME, 8 PANEL GLASS DOOR | 15 | D15 | 2100 | 2000 | 2000 | LUNGS | UPVC FRAME, 8 PANEL GLASS DOOR | 16 | D16 | 2100 | 2000 | 2000 | LUNGS | UPVC FRAME, 8 PANEL GLASS DOOR | 17 | D17 | 2100 | 2000 | 2000 | LUNGS | UPVC FRAME, 8 PANEL GLASS DOOR | 18 | D18 | 2100 | 2000 | 2000 | LUNGS | UPVC FRAME, 8 PANEL GLASS DOOR | 19 | D19 | 2100 | 2000 | 2000 | LUNGS | UPVC FRAME, 8 PANEL GLASS DOOR | 20 | D20 | 2100 | 2000 | 2000 | LUNGS | UPVC FRAME, 8 PANEL GLASS DOOR | 21 | D21 | 2100 | 2000 | 2000 | LUNGS | UPVC FRAME, 8 PANEL GLASS DOOR | 22 | D22 | 2100 | 2000 | 2000 | LUNGS | UPVC FRAME, 8 PANEL GLASS DOOR | 23 | D23 | 2100 | 2000 | 2000 | LUNGS | UPVC FRAME, 8 PANEL GLASS DOOR | 24 | D24 | 2100 | 2000 | 2000 | LUNGS | UPVC FRAME, 8 PANEL GLASS DOOR | 25 | D25 | 2100 | 2000 | 2000 | LUNGS | UPVC FRAME, 8 PANEL GLASS DOOR | 26 | D26 | 2100 | 2000 | 2000 | LUNGS | UPVC FRAME, 8 PANEL GLASS DOOR | 27 | D27 | 2100 | 2000 | 2000 | LUNGS | UPVC FRAME, 8 PANEL GLASS DOOR | 28 | D28 | 2100 | 2000 | 2000 | LUNGS | UPVC FRAME, 8 PANEL GLASS DOOR | 29 | D29 | 2100 | 2000 | 2000 | LUNGS | UPVC FRAME, 8 PANEL GLASS DOOR | 30 | D30 | 2100 | 2000 | 2000 | LUNGS | UPVC FRAME, 8 PANEL GLASS DOOR |
| DOOR TYPE | SYMBOL | HEIGHT | RAIL | RAILING | LOCATION | DESCRIPTION | |
| 1 | D01 | 2100 | 2000 | 2000 | LUNGS | UPVC FRAME, 8 PANEL GLASS DOOR | |
| 2 | D02 | 2100 | 2000 | 2000 | LUNGS | UPVC FRAME, 8 PANEL GLASS DOOR | |
| 3 | D03 | 2100 | 2000 | 2000 | LUNGS | UPVC FRAME, 8 PANEL GLASS DOOR | |
| 4 | D04 | 2100 | 2000 | 2000 | LUNGS | UPVC FRAME, 8 PANEL GLASS DOOR | |
| 5 | D05 | 2100 | 2000 | 2000 | LUNGS | UPVC FRAME, 8 PANEL GLASS DOOR | |
| 6 | D06 | 2100 | 2000 | 2000 | LUNGS | UPVC FRAME, 8 PANEL GLASS DOOR | |
| 7 | D07 | 2100 | 2000 | 2000 | LUNGS | UPVC FRAME, 8 PANEL GLASS DOOR | |
| 8 | D08 | 2100 | 2000 | 2000 | LUNGS | UPVC FRAME, 8 PANEL GLASS DOOR | |
| 9 | D09 | 2100 | 2000 | 2000 | LUNGS | UPVC FRAME, 8 PANEL GLASS DOOR | |
| 10 | D10 | 2100 | 2000 | 2000 | LUNGS | UPVC FRAME, 8 PANEL GLASS DOOR | |
| 11 | D11 | 2100 | 2000 | 2000 | LUNGS | UPVC FRAME, 8 PANEL GLASS DOOR | |
| 12 | D12 | 2100 | 2000 | 2000 | LUNGS | UPVC FRAME, 8 PANEL GLASS DOOR | |
| 13 | D13 | 2100 | 2000 | 2000 | LUNGS | UPVC FRAME, 8 PANEL GLASS DOOR | |
| 14 | D14 | 2100 | 2000 | 2000 | LUNGS | UPVC FRAME, 8 PANEL GLASS DOOR | |
| 15 | D15 | 2100 | 2000 | 2000 | LUNGS | UPVC FRAME, 8 PANEL GLASS DOOR | |
| 16 | D16 | 2100 | 2000 | 2000 | LUNGS | UPVC FRAME, 8 PANEL GLASS DOOR | |
| 17 | D17 | 2100 | 2000 | 2000 | LUNGS | UPVC FRAME, 8 PANEL GLASS DOOR | |
| 18 | D18 | 2100 | 2000 | 2000 | LUNGS | UPVC FRAME, 8 PANEL GLASS DOOR | |
| 19 | D19 | 2100 | 2000 | 2000 | LUNGS | UPVC FRAME, 8 PANEL GLASS DOOR | |
| 20 | D20 | 2100 | 2000 | 2000 | LUNGS | UPVC FRAME, 8 PANEL GLASS DOOR | |
| 21 | D21 | 2100 | 2000 | 2000 | LUNGS | UPVC FRAME, 8 PANEL GLASS DOOR | |
| 22 | D22 | 2100 | 2000 | 2000 | LUNGS | UPVC FRAME, 8 PANEL GLASS DOOR | |
| 23 | D23 | 2100 | 2000 | 2000 | LUNGS | UPVC FRAME, 8 PANEL GLASS DOOR | |
| 24 | D24 | 2100 | 2000 | 2000 | LUNGS | UPVC FRAME, 8 PANEL GLASS DOOR | |
| 25 | D25 | 2100 | 2000 | 2000 | LUNGS | UPVC FRAME, 8 PANEL GLASS DOOR | |
| 26 | D26 | 2100 | 2000 | 2000 | LUNGS | UPVC FRAME, 8 PANEL GLASS DOOR | |
| 27 | D27 | 2100 | 2000 | 2000 | LUNGS | UPVC FRAME, 8 PANEL GLASS DOOR | |
| 28 | D28 | 2100 | 2000 | 2000 | LUNGS | UPVC FRAME, 8 PANEL GLASS DOOR | |
| 29 | D29 | 2100 | 2000 | 2000 | LUNGS | UPVC FRAME, 8 PANEL GLASS DOOR | |
| 30 | D30 | 2100 | 2000 | 2000 | LUNGS | UPVC FRAME, 8 PANEL GLASS DOOR | |
| OWNER GODREJ PROPERTIES LIMITED | |
| SUBMISSION DRAWING | |
| KEY PLAN | |
| PROJECT PROPOSED GROUP HOUSING FOR PLOT NO :- GH-01/B,C,D,E,J & K SECTOR -12, GREATER NOIDA, G.B. NAGAR, (U.P.) | |
| DATE 08 - 01 - 2025 | PROJECT INCH. BALRAJ SINGH | CHECKED BY BALRAJ SINGH | |
| SCALE 1:100 | DEALT BY ABDHESH JHA | APPROVED BY VISHAL SHARMA | |
| DRAWING TITLE GROUND COVERAGE PLAN | |
| TOWER-2 | |
| ARCHITECTS GI GOLDEN INDIA ARCHITECTS THE TEAM OF ARCHITECTS FF-37, KADAMBA SHOPPING COMPLEX GAMMA-IGREATER NOIDA CON. + 91-94-1585-6777 | |
| DESIGN BY: Confluence NEW DELHI, INDIA F-1, FIRST FLOOR, MIRA CORPORATE SUITES, ISHWAR NAGAR, NEW DELHI 110065 Ph: +91-11-26925684 ccs@inconfluence.com Member of IGBC Ph: +91-11-40564768 www.inconfluence.com ISO - 9001 - 2000 architecture urban design hospitality interiors | |
| DRAWING NO. S-18 | REVISION | |

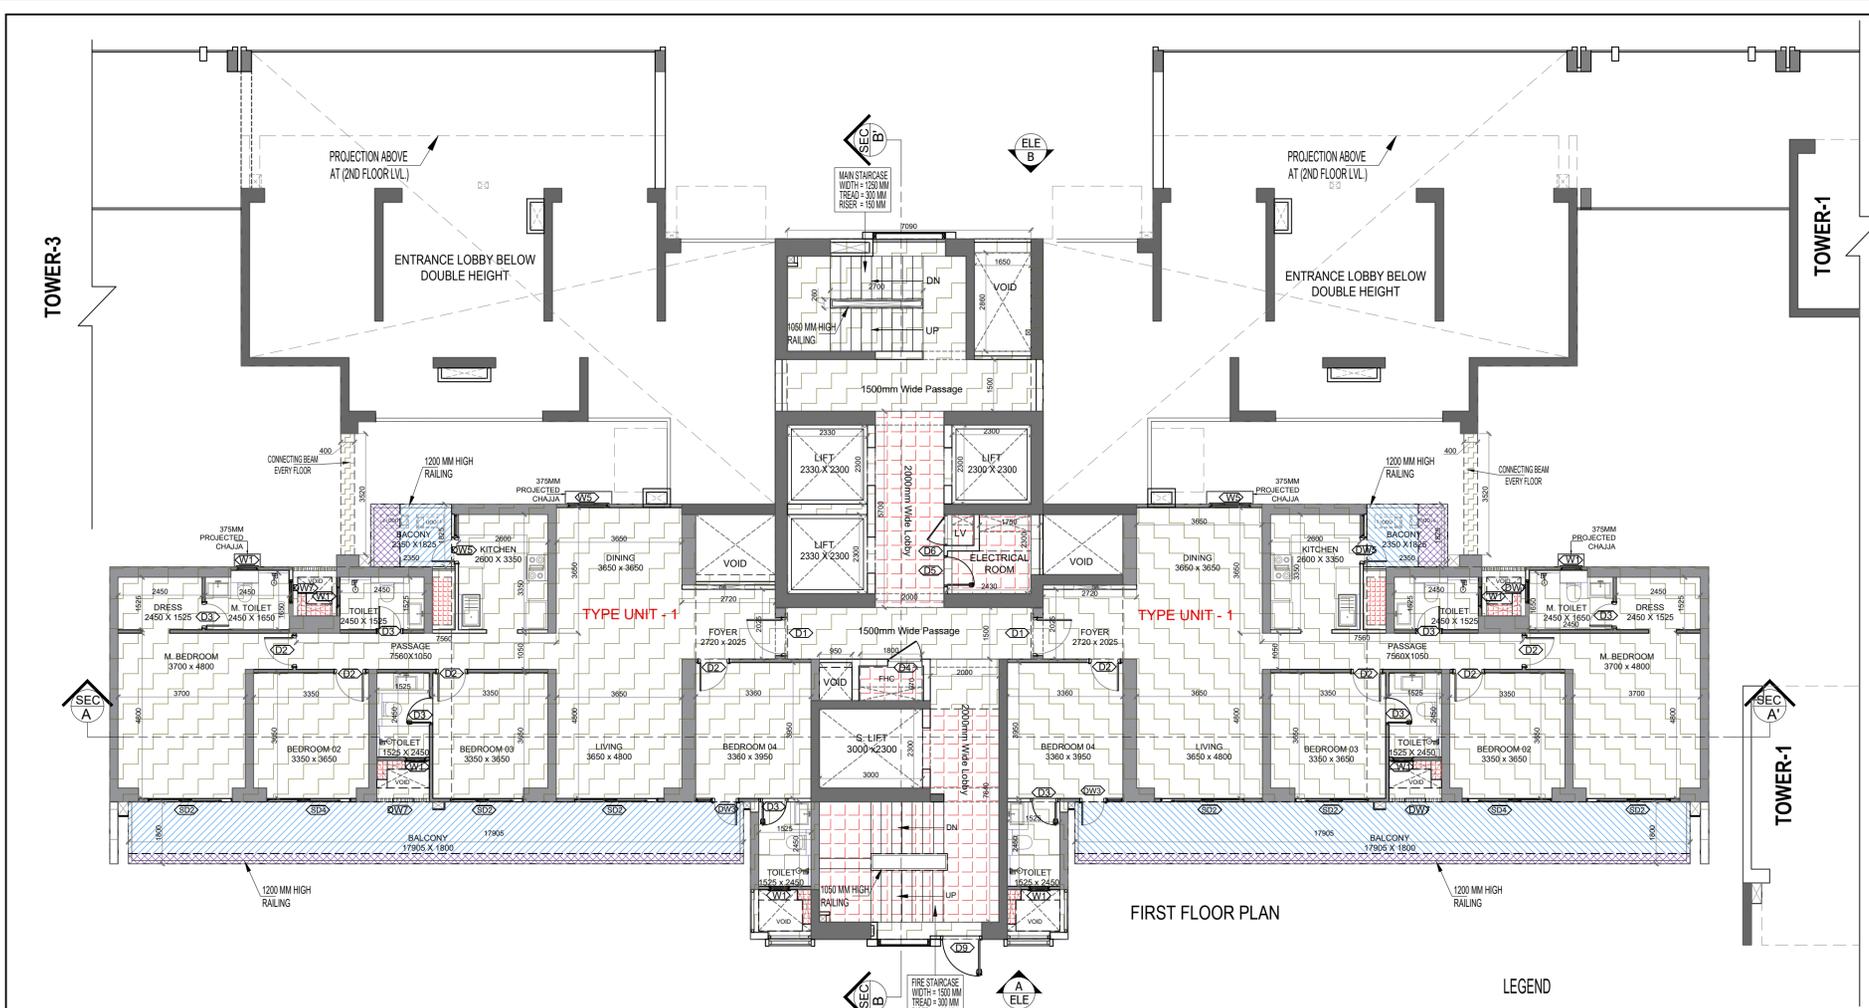

LAL SINGH
 Digitally signed by LAL SINGH
 Date: 2025.01.27 17:31:10 +05'30'

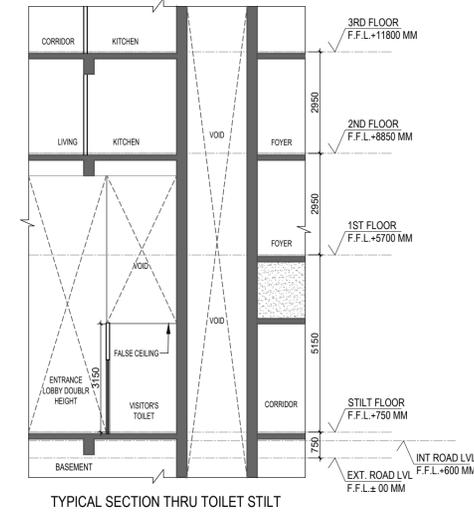

Amit Varma
 Digitally signed by Amit Varma
 Date: 2025.01.25 16:42:56 +05'30'

Sudheer Kumar
 Digitally signed by Sudheer Kumar
 Date: 2025.01.28 14:07:59 +05'30'

OWNER SIGN: **Rajat pathak**
 ARCHITECT SIGN: **AVANISH SRIVASTAV**


TOWN PLANNER SIGN

DOOR SCHEDULE

| NO. | TYPE | LOCATION | DESCRIPTION |
|-----|------|----------|-------------|
| 1 | 1200 | ENTRANCE | 1200 X 1800 |
| 2 | 1200 | KITCHEN | 1200 X 1800 |
| 3 | 1200 | LIVING | 1200 X 1800 |
| 4 | 1200 | TOILET | 1200 X 1800 |
| 5 | 1200 | BEDROOM | 1200 X 1800 |
| 6 | 1200 | BEDROOM | 1200 X 1800 |
| 7 | 1200 | BEDROOM | 1200 X 1800 |
| 8 | 1200 | BEDROOM | 1200 X 1800 |
| 9 | 1200 | BEDROOM | 1200 X 1800 |
| 10 | 1200 | BEDROOM | 1200 X 1800 |
| 11 | 1200 | BEDROOM | 1200 X 1800 |
| 12 | 1200 | BEDROOM | 1200 X 1800 |
| 13 | 1200 | BEDROOM | 1200 X 1800 |
| 14 | 1200 | BEDROOM | 1200 X 1800 |
| 15 | 1200 | BEDROOM | 1200 X 1800 |
| 16 | 1200 | BEDROOM | 1200 X 1800 |
| 17 | 1200 | BEDROOM | 1200 X 1800 |
| 18 | 1200 | BEDROOM | 1200 X 1800 |
| 19 | 1200 | BEDROOM | 1200 X 1800 |
| 20 | 1200 | BEDROOM | 1200 X 1800 |
| 21 | 1200 | BEDROOM | 1200 X 1800 |
| 22 | 1200 | BEDROOM | 1200 X 1800 |
| 23 | 1200 | BEDROOM | 1200 X 1800 |
| 24 | 1200 | BEDROOM | 1200 X 1800 |
| 25 | 1200 | BEDROOM | 1200 X 1800 |
| 26 | 1200 | BEDROOM | 1200 X 1800 |
| 27 | 1200 | BEDROOM | 1200 X 1800 |
| 28 | 1200 | BEDROOM | 1200 X 1800 |
| 29 | 1200 | BEDROOM | 1200 X 1800 |
| 30 | 1200 | BEDROOM | 1200 X 1800 |

WINDOW SCHEDULE

| NO. | TYPE | LOCATION | DESCRIPTION |
|-----|------|----------|-------------|
| 1 | 1200 | ENTRANCE | 1200 X 1800 |
| 2 | 1200 | KITCHEN | 1200 X 1800 |
| 3 | 1200 | LIVING | 1200 X 1800 |
| 4 | 1200 | TOILET | 1200 X 1800 |
| 5 | 1200 | BEDROOM | 1200 X 1800 |
| 6 | 1200 | BEDROOM | 1200 X 1800 |
| 7 | 1200 | BEDROOM | 1200 X 1800 |
| 8 | 1200 | BEDROOM | 1200 X 1800 |
| 9 | 1200 | BEDROOM | 1200 X 1800 |
| 10 | 1200 | BEDROOM | 1200 X 1800 |
| 11 | 1200 | BEDROOM | 1200 X 1800 |
| 12 | 1200 | BEDROOM | 1200 X 1800 |
| 13 | 1200 | BEDROOM | 1200 X 1800 |
| 14 | 1200 | BEDROOM | 1200 X 1800 |
| 15 | 1200 | BEDROOM | 1200 X 1800 |
| 16 | 1200 | BEDROOM | 1200 X 1800 |
| 17 | 1200 | BEDROOM | 1200 X 1800 |
| 18 | 1200 | BEDROOM | 1200 X 1800 |
| 19 | 1200 | BEDROOM | 1200 X 1800 |
| 20 | 1200 | BEDROOM | 1200 X 1800 |
| 21 | 1200 | BEDROOM | 1200 X 1800 |
| 22 | 1200 | BEDROOM | 1200 X 1800 |
| 23 | 1200 | BEDROOM | 1200 X 1800 |
| 24 | 1200 | BEDROOM | 1200 X 1800 |
| 25 | 1200 | BEDROOM | 1200 X 1800 |
| 26 | 1200 | BEDROOM | 1200 X 1800 |
| 27 | 1200 | BEDROOM | 1200 X 1800 |
| 28 | 1200 | BEDROOM | 1200 X 1800 |
| 29 | 1200 | BEDROOM | 1200 X 1800 |
| 30 | 1200 | BEDROOM | 1200 X 1800 |

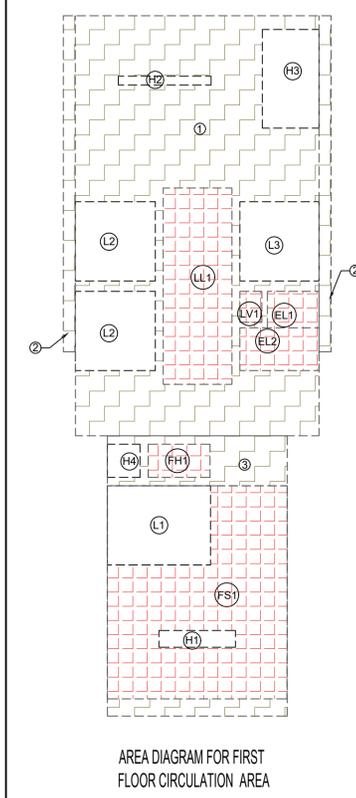

F.A.R. COVERED AREA CALCULATION FOR CIRCULATION AREA

| S.NO. | PARTICULARS | AREA (SQMT) |
|---|-------------------|----------------|
| 1 | 7.000 X 12.205 | 85.533 |
| 2 | 0.350 X 9.760 X 2 | 6.832 |
| 3 | 5.230 X 8.140 | 42.572 |
| TOTAL AREA (A) | | 135.938 |
| AREA SUBTRACTION | | |
| FS1 | 5.230 X 6.190 | 32.374 |
| LL1 | 2.000 X 5.700 | 11.400 |
| EL1 | 1.500 X 1.060 | 1.590 |
| EL2 | 2.300 X 1.240 | 2.852 |
| FH1 | 1.800 X 0.970 | 1.746 |
| LV1 | 0.640 X 0.900 | 0.576 |
| H2 | 2.700 X 0.260 | 0.702 |
| H3 | 1.650 X 2.860 | 4.719 |
| H4 | 0.950 X 0.970 | 0.922 |
| L2 | 2.330 X 2.300 X 2 | 10.718 |
| L3 | 2.300 X 2.300 | 5.290 |
| TOTAL (B) | | 72.888 |
| TOTAL F.A.R. AREA CORRIDOR C = (A - B) | | 63.049 |

TOTAL F.A.R. AREA AT FIRST FLOOR PLAN



| S.NO. | PARTICULARS | AREA (SQMT) |
|--------------------------|--------------------------------|----------------|
| 1 | F.A.R. AREA OF UNIT - 1 | 312.490 |
| 2 | F.A.R. AREA OF CIRCULATION | 63.049 |
| 3 | F.A.R. AREA OF CONNECTING BEAM | 2.816 |
| TOTAL F.A.R. AREA | | 378.355 |

TOTAL NON-F.A.R. AREA AT FIRST FLOOR/ PODIUM

| UNIT - 1 | AREA (SQMT) | |
|---------------------------|-------------|---------------|
| 34.729 X 2 | 69.458 | |
| TOTAL BALCONY AREA | | 69.458 |

F.A.R. AREA AT CONNECTING BEAM (EVERY FLOOR)

| S.NO. | PARTICULARS | AREA (SQMT) |
|--------------------------|-------------------|--------------|
| 1 | 0.400 X 3.520 X 2 | 2.816 |
| TOTAL F.A.R. AREA | | 2.816 |

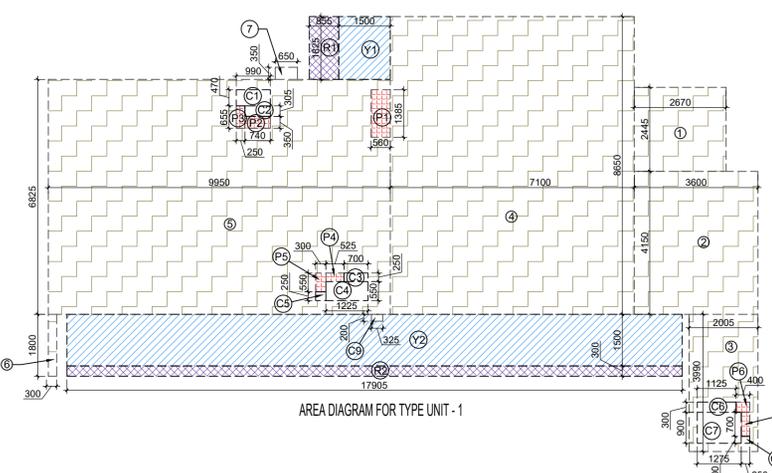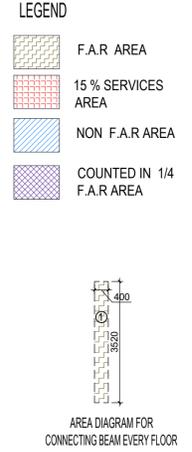

CORRIDOR AREA CALCULATION TOWARDS 15% ADDITIONAL F.A.R.


| S.NO. | PARTICULARS | AREA (SQMT) |
|---|-------------------|---------------|
| FIRE TOWER AREA | | |
| FS1 | 5.230 X 6.190 | 32.374 |
| LIFT LOBBY | | |
| LL1 | 2.000 X 5.700 | 11.400 |
| ELECTRICAL SHAFT & LV SHAFT | | |
| EL1 | 1.500 X 1.060 | 1.590 |
| EL2 | 2.300 X 1.240 | 2.852 |
| F.H.C. SHAFT | | |
| FH1 | 1.800 X 0.970 | 1.746 |
| PLUMBING SHAFT | | |
| LV1 | 0.640 X 0.900 | 0.576 |
| TOTAL CORRIDOR AREA CALCULATION TOWARDS 15% ADDITIONAL F.A.R. (A) | | 50.538 |
| UNIT AREA CALCULATION TOWARDS 15% ADDITIONAL F.A.R. | | |
| PLUMBING SHAFT | | |
| P1 | 0.560 X 1.385 X 2 | 1.551 |
| P2 | 0.740 X 0.350 X 2 | 0.518 |
| P3 | 0.250 X 0.655 X 2 | 0.328 |
| P4 | 0.525 X 0.250 X 2 | 0.263 |
| P5 | 0.300 X 0.550 X 2 | 0.330 |
| P6 | 0.400 X 0.300 X 2 | 0.240 |
| P7 | 0.250 X 0.700 X 2 | 0.350 |
| P8 | 0.400 X 0.300 X 2 | 0.240 |
| P9 | 0.250 X 0.700 X 2 | 0.350 |
| TOTAL UNIT AREA CALCULATION TOWARDS 15% ADDITIONAL F.A.R. (B) | | 3.579 |
| TOTAL 15% ADDITIONAL F.A.R. AREA (CORRIDOR AREA+UNIT AREA) = C = (A+B) | | 54.117 |
| AREA SUBTRACTION | | |
| H1 | 2.230 X 0.490 | 1.093 |
| L1 | 3.000 X 2.300 | 6.900 |
| TOTAL AREA (D) | | 7.993 |
| TOTAL 15% ADDITIONAL F.A.R. AREA E = (C-D) | | 46.124 |

F.A.R. COVERED AREA CALCULATION FOR TYPE UNIT - 1

| S.NO. | PARTICULARS | AREA (SQMT) |
|---|-------------------------------|----------------|
| 1 | 2.670 X 2.445 | 6.528 |
| 2 | 3.600 X 4.150 | 14.940 |
| 3 | 2.005 X 3.990 | 8.000 |
| 4 | 7.100 X 8.650 | 61.415 |
| 5 | 9.950 X 8.825 | 87.809 |
| 6 | 0.240 X 1.800 | 0.432 |
| 7 | 0.650 X 0.350 | 0.228 |
| UNIT FAR AREA = (A) | | 159.451 |
| AREA SUBTRACTION PLUMBING CUTOFF | | |
| P1 | 0.560 X 1.385 | 0.776 |
| P2 | 0.740 X 0.350 | 0.259 |
| P3 | 0.250 X 0.655 | 0.164 |
| P4 | 0.525 X 0.250 | 0.131 |
| P5 | 0.300 X 0.550 | 0.165 |
| P6 | 0.400 X 0.300 | 0.120 |
| P7 | 0.250 X 0.700 | 0.175 |
| C1 | 0.990 X 0.470 | 0.465 |
| C2 | 0.740 X 0.305 | 0.226 |
| C3 | 0.700 X 0.250 | 0.175 |
| C4 | 1.225 X 0.550 | 0.674 |
| C5 | 0.300 X 0.250 | 0.075 |
| C6 | 1.125 X 0.300 | 0.338 |
| C7 | 1.275 X 0.900 | 1.148 |
| C8 | 0.250 X 0.200 | 0.050 |
| TOTAL (B) | | 4.939 |
| TOTAL F.A.R. AREA C = (A - B) | | 154.512 |
| 1/4 F.A.R. AREA OF BALCONY | | |
| R1 | 0.855 X 1.825 | 1.560 |
| R2 | 1.790 X 0.300 | 0.537 |
| TOTAL AREA (D) | | 6.932 |
| 1/4 BALCONY F.A.R. AREA (E) | | 1.733 |
| TOTAL UNIT F.A.R. AREA F = (C+E) | | 156.245 |
| NON F.A.R. AREA OF BALCONY | | |
| Y1 | 1.500 X 1.825 | 2.738 |
| Y2 | 1.790 X 1.500 | 26.850 |
| 3/4 AREA OF BALCONY (D - E) | | 34.794 |
| AREA SUBTRACTION | | |
| C9 | 0.325 X 0.200 | 0.065 |
| TOTAL AREA (H) | | 0.065 |
| TOTAL BALCONY AREA J = (G - H) | | 34.729 |
| 15% SERVICES AREA OF UNIT (PLUMBING SHAFT) | | |
| P1 | 0.560 X 1.385 | 0.776 |
| P2 | 0.740 X 0.350 | 0.259 |
| P3 | 0.250 X 0.655 | 0.164 |
| P4 | 0.525 X 0.250 | 0.131 |
| P5 | 0.300 X 0.550 | 0.165 |
| P6 | 0.400 X 0.300 | 0.120 |
| P7 | 0.250 X 0.700 | 0.175 |
| TOTAL 15% SERVICES AREA OF UNIT (K) | | 1.790 |
| COVERAGE AREA FOR UNIT = (F + J + K) | | |
| 1 | TOTAL UNIT F.A.R. AREA (F) | 156.245 |
| 2 | NON F.A.R. AREA OF UNIT (J) | 34.729 |
| 3 | 15% SERVICES AREA OF UNIT (K) | 1.790 |
| TOTAL UNIT COVERAGE AREA | | 192.763 |

OWNER: **GODREJ PROPERTIES LIMITED**

SUBMISSION DRAWING

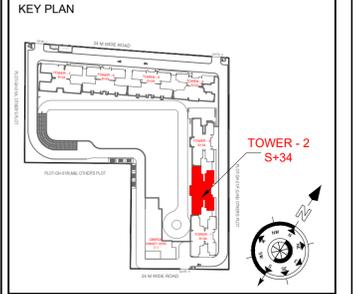

PROJECT: **PROPOSED GROUP HOUSING FOR PLOT NO. - GH-01/B, C, D, E, J & K SECTOR - 12, GREATER NOIDA, G.B. NAGAR, (U.P.)**

| | | |
|------------------|----------------------------|---------------------------|
| DATE: 08-01-2025 | PROJECT INCH. BALRAJ SINGH | CHECKED BY BALRAJ SINGH |
| SCALE: 1:100 | DEALT BY ABDHESH JHA | APPROVED BY VISHAL SHARMA |

DRAWING TITLE: **FIRST FLOOR PLAN**

TOWER-2

ARCHITECTS: **GOLDEN INDIA ARCHITECTS**
 THE TEAM OF ARCHITECTS
 FF-37, KADAMBA SHOPPING COMPLEX
 GAMMA-IGREATER NOIDA
 CON... + 91-94-1555-6777

DESIGN BY: **Confluence**
 NEW DELHI, INDIA

F-1, FIRST FLOOR, MIRA CORPORATE SUITES,
 ISHWAR NAGAR, NEW DELHI 110065

Ph: +91-11-26525684 ccs@confluence.com Member of IGBC
 Ph: +91-11-40564768 www.confluence.com ISO - 9001 : 2000
 architecture urban design hospitality interiors

DRAWING NO. **S-20** REVISION

LAL SINGH
Digitally signed by LAL SINGH
Date: 2025.01.27
17:32:36
+05'30'

Amit Varma
Digitally signed by Amit Varma
Date: 2025.01.25
16:44:00 +05'30'

Sudheer Kumar
Digitally signed by Sudheer Kumar
Date: 2025.01.28
14:08:45 +05'30'

OWNER SIGN: **Rajat pathak**
ARCHITECT SIGN: **AVANISH SRIVASTAV**

TOWN PLANNER SIGN

DOOR SCHEDULE

| S.NO. | TYPE | SIZE | LOCATION | DESCRIPTION |
|-------|------|------|----------|-------------|
| 1 | 1200 | 2400 | TOILET | TOILET |
| 2 | 1200 | 2400 | TOILET | TOILET |
| 3 | 1200 | 2400 | TOILET | TOILET |
| 4 | 1200 | 2400 | TOILET | TOILET |
| 5 | 1200 | 2400 | TOILET | TOILET |
| 6 | 1200 | 2400 | TOILET | TOILET |
| 7 | 1200 | 2400 | TOILET | TOILET |
| 8 | 1200 | 2400 | TOILET | TOILET |
| 9 | 1200 | 2400 | TOILET | TOILET |
| 10 | 1200 | 2400 | TOILET | TOILET |
| 11 | 1200 | 2400 | TOILET | TOILET |
| 12 | 1200 | 2400 | TOILET | TOILET |
| 13 | 1200 | 2400 | TOILET | TOILET |
| 14 | 1200 | 2400 | TOILET | TOILET |
| 15 | 1200 | 2400 | TOILET | TOILET |
| 16 | 1200 | 2400 | TOILET | TOILET |
| 17 | 1200 | 2400 | TOILET | TOILET |
| 18 | 1200 | 2400 | TOILET | TOILET |
| 19 | 1200 | 2400 | TOILET | TOILET |
| 20 | 1200 | 2400 | TOILET | TOILET |
| 21 | 1200 | 2400 | TOILET | TOILET |
| 22 | 1200 | 2400 | TOILET | TOILET |
| 23 | 1200 | 2400 | TOILET | TOILET |
| 24 | 1200 | 2400 | TOILET | TOILET |
| 25 | 1200 | 2400 | TOILET | TOILET |
| 26 | 1200 | 2400 | TOILET | TOILET |
| 27 | 1200 | 2400 | TOILET | TOILET |
| 28 | 1200 | 2400 | TOILET | TOILET |
| 29 | 1200 | 2400 | TOILET | TOILET |
| 30 | 1200 | 2400 | TOILET | TOILET |


WINDOW SCHEDULE

| S.NO. | TYPE | SIZE | LOCATION | DESCRIPTION |
|-------|------|------|----------|-------------|
| 1 | 1200 | 1800 | TOILET | TOILET |
| 2 | 1200 | 1800 | TOILET | TOILET |
| 3 | 1200 | 1800 | TOILET | TOILET |
| 4 | 1200 | 1800 | TOILET | TOILET |
| 5 | 1200 | 1800 | TOILET | TOILET |
| 6 | 1200 | 1800 | TOILET | TOILET |
| 7 | 1200 | 1800 | TOILET | TOILET |
| 8 | 1200 | 1800 | TOILET | TOILET |
| 9 | 1200 | 1800 | TOILET | TOILET |
| 10 | 1200 | 1800 | TOILET | TOILET |
| 11 | 1200 | 1800 | TOILET | TOILET |
| 12 | 1200 | 1800 | TOILET | TOILET |
| 13 | 1200 | 1800 | TOILET | TOILET |
| 14 | 1200 | 1800 | TOILET | TOILET |
| 15 | 1200 | 1800 | TOILET | TOILET |
| 16 | 1200 | 1800 | TOILET | TOILET |
| 17 | 1200 | 1800 | TOILET | TOILET |
| 18 | 1200 | 1800 | TOILET | TOILET |
| 19 | 1200 | 1800 | TOILET | TOILET |
| 20 | 1200 | 1800 | TOILET | TOILET |
| 21 | 1200 | 1800 | TOILET | TOILET |
| 22 | 1200 | 1800 | TOILET | TOILET |
| 23 | 1200 | 1800 | TOILET | TOILET |
| 24 | 1200 | 1800 | TOILET | TOILET |
| 25 | 1200 | 1800 | TOILET | TOILET |
| 26 | 1200 | 1800 | TOILET | TOILET |
| 27 | 1200 | 1800 | TOILET | TOILET |
| 28 | 1200 | 1800 | TOILET | TOILET |
| 29 | 1200 | 1800 | TOILET | TOILET |
| 30 | 1200 | 1800 | TOILET | TOILET |

OWNER: **GODREJ PROPERTIES LIMITED**

SUBMISSION DRAWING

KEY PLAN

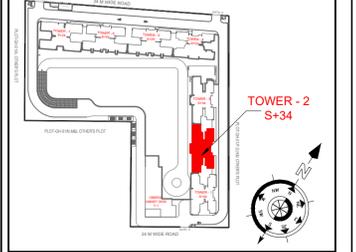

PROJECT: **PROPOSED GROUP HOUSING FOR PLOT NO :- GH-01/B,C,D,E,J & K SECTOR -12, GREATER NOIDA, G.B. NAGAR, (U.P.)**

DATE: 08-01-2025
PROJECT INCH: BALRAJ SINGH
CHECKED BY: BALRAJ SINGH

SCALE: 1:100
DEALT BY: ABDHESH JHA
APPROVED BY: VISHAL SHARMA

DRAWING TITLE: **2ND TO 18TH, 20TH TO 28TH & 30TH TO 34TH FLOOR PLAN(TYPICAL)**

ARCHITECTS: **GOLDEN INDIA ARCHITECTS**





DESIGN BY: **Confluence**

NEW DELHI, INDIA

F-1, FIRST FLOOR, MIRA CORPORATE SUITES, ISHWAR NAGAR, NEW DELHI 110065

Ph: +91-11-26525684 ccs@confluence.com Member of IGBC
Ph: +91-11-4056468 www.confluence.com 150 - 9001 - 2000
architecture urban design hospitality interiors

DRAWING NO. **S-21** REVISION

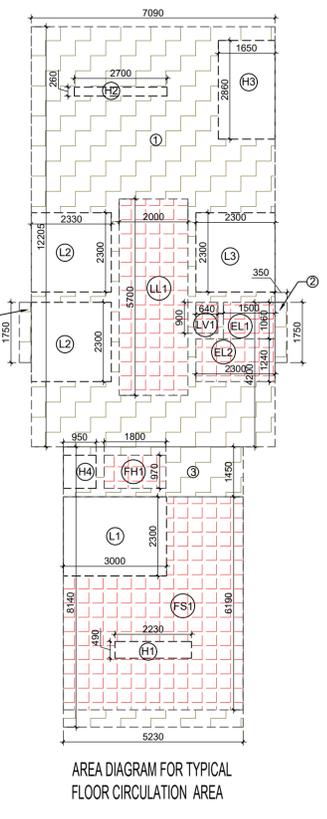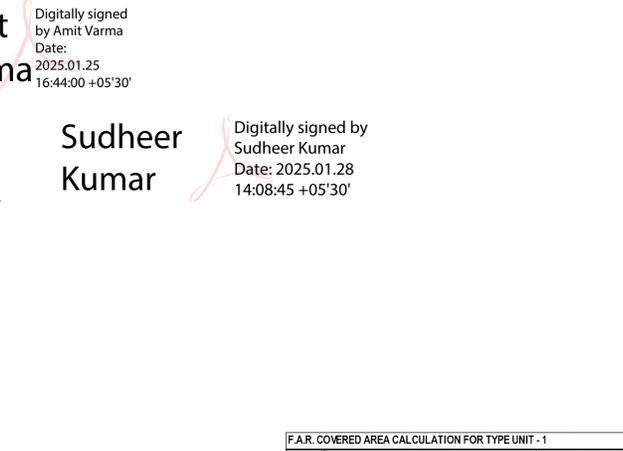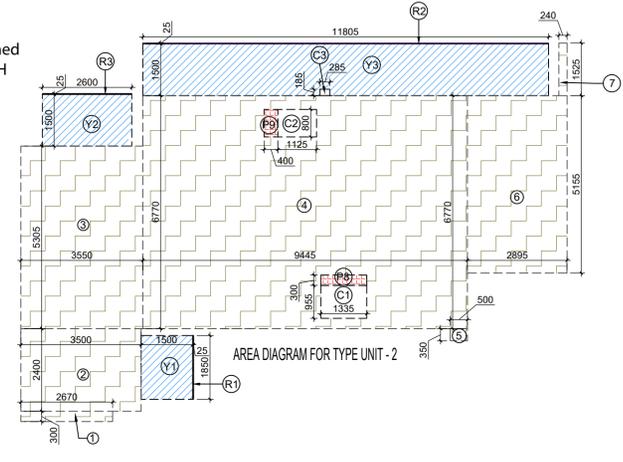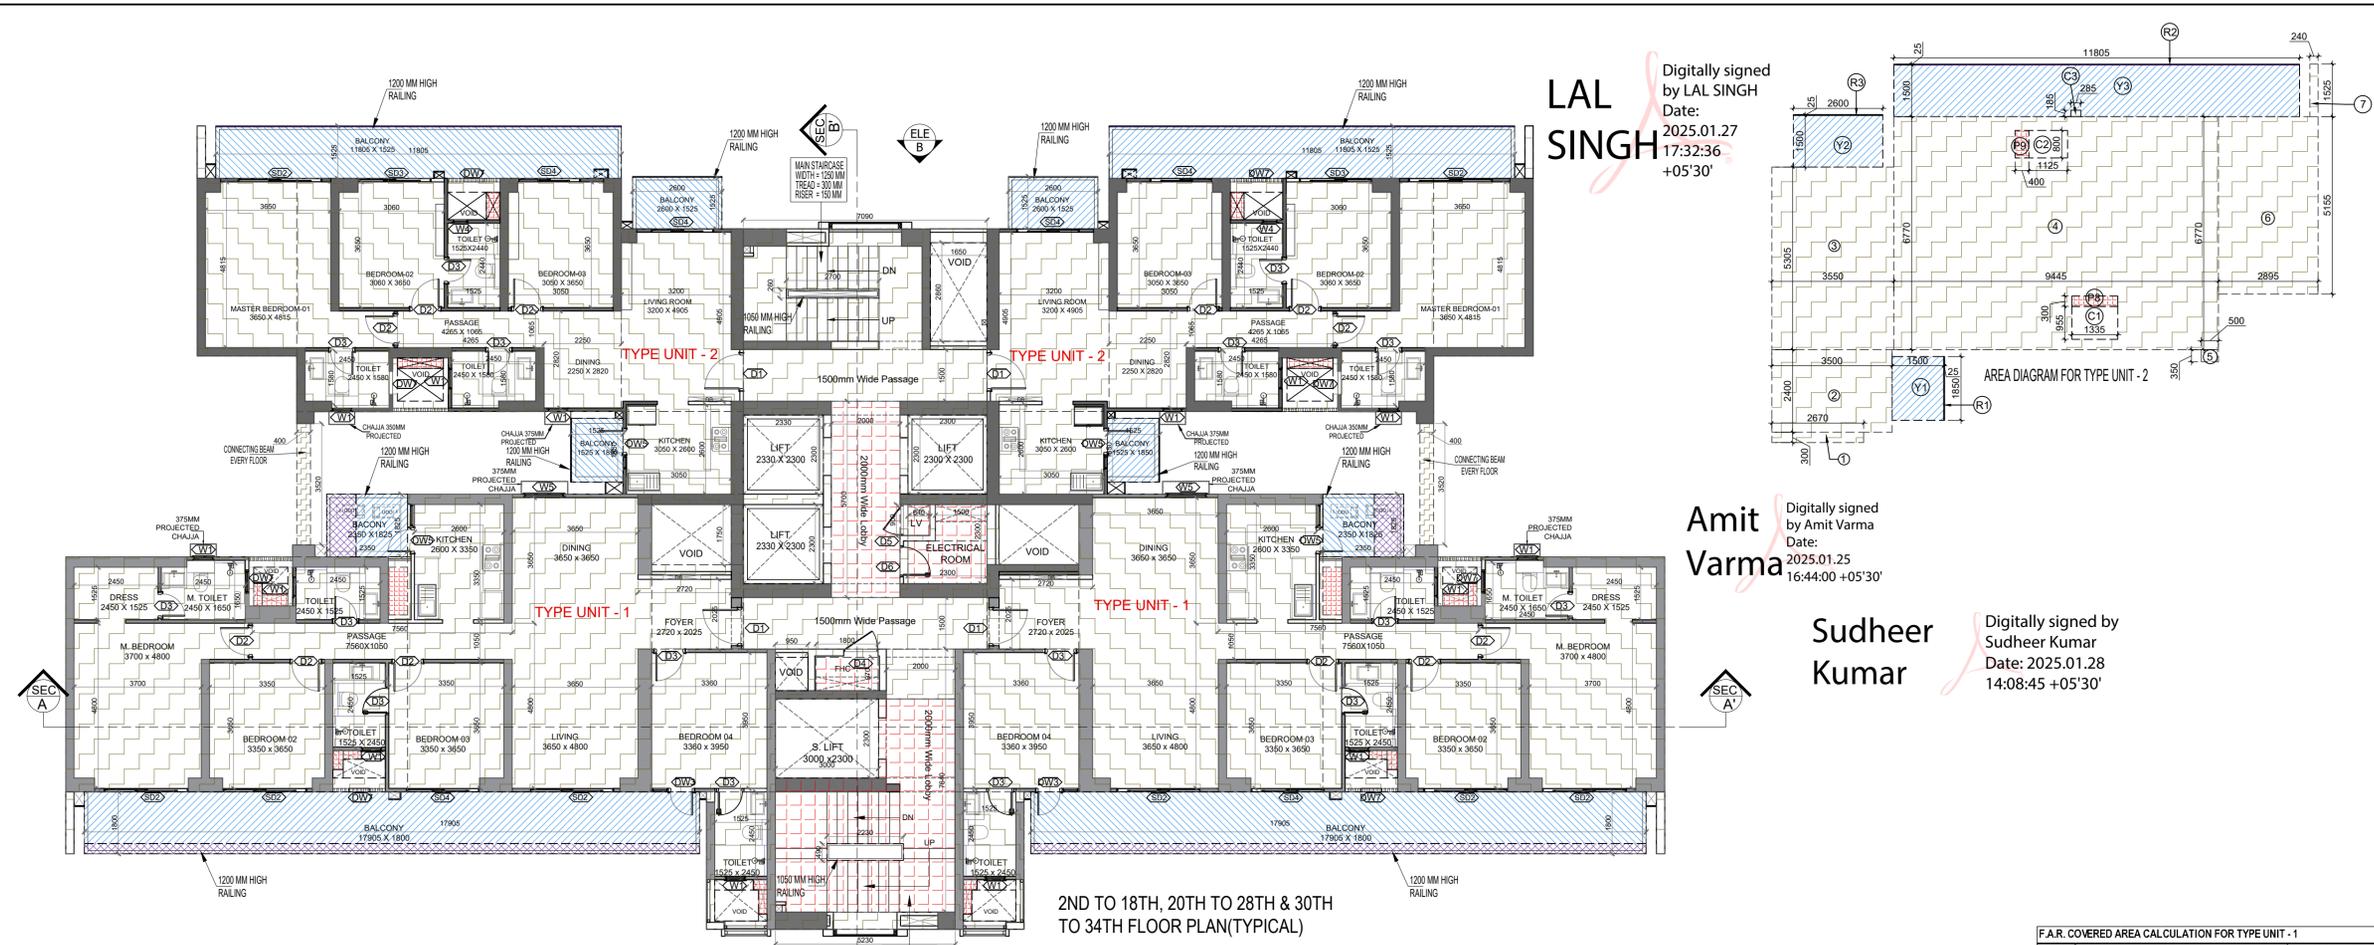

F.A.R. COVERED AREA CALCULATION FOR CIRCULATION AREA

| S.NO. | PARTICULARS | AREA (SQMT) |
|-----------------------|-------------------|------------------|
| 1 | 7.090 X 12.205 | = 86.533 |
| 2 | 0.350 X 1.750 X 2 | = 1.225 |
| 3 | 5.230 X 8.140 | = 42.572 |
| TOTAL AREA (A) | | = 130.331 |

CORRIDOR AREA CALCULATION TOWARDS 15% ADDITIONAL F.A.R

| S.NO. | PARTICULARS | AREA (SQMT) |
|--|-------------------|-----------------|
| FS1 | 5.230 X 6.190 | = 32.374 |
| LL1 | 2.000 X 5.700 | = 11.400 |
| EL1 | 1.500 X 1.060 | = 1.590 |
| EL2 | 2.300 X 1.240 | = 2.852 |
| FH1 | 1.800 X 0.970 | = 1.746 |
| LV1 | 0.640 X 0.900 | = 0.576 |
| H2 | 2.700 X 0.260 | = 0.702 |
| H3 | 1.650 X 2.860 | = 4.719 |
| H4 | 0.950 X 0.970 | = 0.922 |
| L2 | 2.300 X 2.300 X 2 | = 10.718 |
| L3 | 2.300 X 2.300 | = 5.290 |
| TOTAL (B) | | = 72.888 |
| TOTAL F.A.R AREA CORRIDOR C = (A - B) | | = 57.442 |

UNIT AREA CALCULATION TOWARDS 15% ADDITIONAL F.A.R

| S.NO. | PARTICULARS | AREA (SQMT) |
|--|-------------------|-----------------|
| P1 | 0.560 X 1.385 X 2 | = 1.551 |
| P2 | 0.740 X 0.350 X 2 | = 0.518 |
| P3 | 0.250 X 0.655 X 2 | = 0.328 |
| P4 | 0.525 X 0.250 X 2 | = 0.263 |
| P5 | 0.300 X 0.550 X 2 | = 0.330 |
| P6 | 0.400 X 0.300 X 2 | = 0.240 |
| P7 | 0.250 X 0.700 X 2 | = 0.350 |
| P8 | 1.335 X 0.300 X 2 | = 0.801 |
| P9 | 0.400 X 0.800 X 2 | = 0.640 |
| TOTAL UNIT AREA CALCULATION TOWARDS 15% ADDITIONAL F.A.R (B) | | = 5.600 |
| TOTAL 15% ADDITIONAL F.A.R AREA (CORRIDOR AREA+UNIT AREA) = C (A+B) | | = 55.558 |

TOTAL F.A.R. AREA AT 2ND TO 18TH, 20TH TO 28TH & 30TH TO 34TH FLOOR PLAN (TYPICAL)


| S.N.O. | PARTICULARS | AREA (SQMT) |
|-------------------------|-------------------------------|------------------|
| 1 | F.A.R AREA OF UNIT - 1 | 156.245 |
| 2 | F.A.R AREA OF UNIT - 2 | 104.643 |
| 3 | F.A.R AREA OF CIRCULATION | 57.442 |
| 4 | F.A.R AREA OF CONNECTING BEAM | 2.816 |
| TOTAL F.A.R AREA | | = 582.035 |

TOTAL NON F.A.R. AREA AT 2ND TO 18TH, 20TH TO 28TH & 30TH TO 34TH FLOOR PLAN (TYPICAL)

| UNIT | AREA (SQMT) | |
|---------------------------|-------------|------------------|
| UNIT - 1 | 69.458 | |
| UNIT - 2 | 49.269 | |
| TOTAL BALCONY AREA | | = 118.727 |

F.A.R. AREA AT CONNECTING BEAM (EVERY FLOOR)

| S.N.O. | PARTICULARS | AREA (SQMT) |
|-------------------------|-------------------|----------------|
| 1 | 0.400 X 3.520 X 2 | = 2.816 |
| TOTAL F.A.R AREA | | = 2.816 |

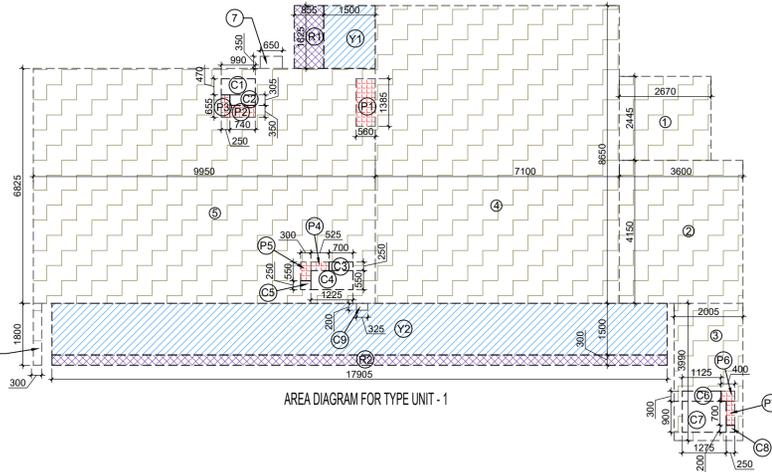

F.A.R. COVERED AREA CALCULATION FOR TYPE UNIT - 2

| S.NO. | PARTICULARS | AREA (SQMT) |
|----------------------------|---------------|------------------|
| 1 | 2.670 X 0.300 | = 0.801 |
| 2 | 3.500 X 2.400 | = 8.400 |
| 3 | 3.550 X 5.305 | = 18.833 |
| 4 | 9.445 X 6.770 | = 63.943 |
| 5 | 0.500 X 0.350 | = 0.175 |
| 6 | 2.895 X 5.155 | = 14.924 |
| 7 | 0.240 X 1.525 | = 0.366 |
| UNIT FAR AREA = (A) | | = 107.441 |

AREA SUBTRACTION PLUMBING CUTOFF

| S.NO. | PARTICULARS | AREA (SQMT) |
|-------------------------------------|---------------|------------------|
| P8 | 1.335 X 0.300 | = 0.401 |
| P9 | 0.400 X 0.810 | = 0.324 |
| C1 | 1.335 X 0.955 | = 1.275 |
| C2 | 1.125 X 0.800 | = 0.900 |
| TOTAL (B) | | = 2.899 |
| TOTAL F.A.R AREA C = (A - B) | | = 104.542 |

1/4 F.A.R. AREA OF BALCONY

| S.NO. | PARTICULARS | AREA (SQMT) |
|--|----------------|------------------|
| R1 | 0.025 X 1.850 | = 0.046 |
| R2 | 11.805 X 0.025 | = 0.295 |
| R3 | 2.600 X 0.025 | = 0.065 |
| TOTAL AREA (D) | | = 0.406 |
| 1/4 BALCONY F.A.R AREA (E) | | = 0.102 |
| TOTAL UNIT F.A.R AREA F = (C + E) | | = 104.643 |

NON F.A.R. AREA OF BALCONY

| Y | AREA (SQMT) | |
|------------------------------------|-------------|-----------------|
| Y1 | 2.775 | |
| Y2 | 3.900 | |
| Y3 | 17.708 | |
| 3/4 AREA OF BALCONY (D - E) | | = 0.325 |
| TOTAL (G) | | = 24.687 |

AREA SUBTRACTION

| S.NO. | PARTICULARS | AREA (SQMT) |
|---------------------------------------|---------------|-----------------|
| C3 | 0.285 X 0.185 | = 0.053 |
| TOTAL AREA (H) | | = 0.053 |
| TOTAL BALCONY AREA J = (G - H) | | = 24.635 |

15% SERVICES AREA OF UNIT (PLUMBING SHAFT)

| S.NO. | PARTICULARS | AREA (SQMT) |
|--|---------------|----------------|
| P8 | 1.335 X 0.300 | = 0.401 |
| P9 | 0.400 X 0.800 | = 0.320 |
| TOTAL 15% SERVICES AREA OF UNIT (K) | | = 0.721 |

COVERAGE AREA FOR UNIT = (F + J + K)

| S.NO. | PARTICULARS | AREA (SQMT) |
|---------------------------------|-------------------------------|------------------|
| 1 | TOTAL UNIT F.A.R AREA (F) | 104.643 |
| 2 | NON F.A.R AREA OF UNIT (J) | 24.635 |
| 3 | 15% SERVICES AREA OF UNIT (K) | 0.721 |
| TOTAL UNIT COVERAGE AREA | | = 129.998 |

F.A.R. COVERED AREA CALCULATION FOR TYPE UNIT - 1

| S. NO. | PARTICULARS | AREA (SQMT) |
|----------------------------|---------------|------------------|
| 1 | 2.670 X 2.445 | = 6.528 |
| 2 | 3.600 X 4.150 | = 14.940 |
| 3 | 2.055 X 3.990 | = 8.200 |
| 4 | 7.100 X 8.650 | = 61.415 |
| 5 | 9.950 X 8.825 | = 87.909 |
| 6 | 0.240 X 1.800 | = 0.432 |
| 7 | 0.650 X 0.350 | = 0.228 |
| UNIT FAR AREA = (A) | | = 159.451 |

AREA SUBTRACTION PLUMBING CUTOFF

| S.NO. | PARTICULARS | AREA (SQMT) |
|-------------------------------------|---------------|------------------|
| P1 | 0.560 X 1.385 | = 0.776 |
| P2 | 0.740 X 0.350 | = 0.259 |
| P3 | 0.250 X 0.655 | = 0.164 |
| P4 | 0.525 X 0.250 | = 0.131 |
| P5 | 0.300 X 0.550 | = 0.165 |
| P6 | 0.400 X 0.300 | = 0.120 |
| P7 | 0.250 X 0.700 | = 0.175 |
| C1 | 0.990 X 0.470 | = 0.465 |
| C2 | 0.740 X 0.305 | = 0.226 |
| C3 | 0.700 X 0.250 | = 0.175 |
| C4 | 1.225 X 0.550 | = 0.674 |
| C5 | 0.300 X 0.250 | = 0.075 |
| C6 | 1.125 X 0.300 | = 0.338 |
| C7 | 1.275 X 0.900 | = 1.148 |
| C8 | 0.250 X 0.200 | = 0.050 |
| TOTAL (B) | | = 4.939 |
| TOTAL F.A.R AREA C = (A - B) | | = 154.512 |

1/4 F.A.R. AREA OF BALCONY

| S.NO. | PARTICULARS | AREA (SQMT) |
|--|----------------|------------------|
| R1 | 0.855 X 1.825 | = 1.560 |
| R2 | 17.905 X 0.300 | = 5.372 |
| TOTAL AREA (D) | | = 6.932 |
| 1/4 BALCONY F.A.R AREA (E) | | = 1.733 |
| TOTAL UNIT F.A.R AREA F = (C + E) | | = 156.245 |

NON F.A.R. AREA OF BALCONY

| Y | AREA (SQMT) | |
|------------------------------------|-------------|-----------------|
| Y1 | 2.738 | |
| Y2 | 26.868 | |
| 3/4 AREA OF BALCONY (D - E) | | = 5.199 |
| TOTAL (G) | | = 34.794 |

AREA SUBTRACTION

| S.NO. | PARTICULARS | AREA (SQMT) |
|---------------------------------------|---------------|-----------------|
| C9 | 0.325 X 0.200 | = 0.065 |
| TOTAL AREA (H) | | = 0.065 |
| TOTAL BALCONY AREA J = (G - H) | | = 34.729 |


15% SERVICES AREA OF UNIT (PLUMBING SHAFT)

| S.NO. | PARTICULARS | AREA (SQMT) |
|--|---------------|----------------|
| P1 | 0.560 X 1.385 | = 0.776 |
| P2 | 0.740 X 0.350 | = 0.259 |
| P3 | 0.250 X 0.655 | = 0.164 |
| P4 | 0.525 X 0.250 | = 0.131 |
| P5 | 0.300 X 0.550 | = 0.165 |
| P6 | 0.400 X 0.300 | = 0.120 |
| P7 | 0.250 X 0.700 | = 0.175 |
| TOTAL 15% SERVICES AREA OF UNIT (K) | | = 1.790 |

COVERAGE AREA FOR UNIT = (F + J + K)


| S.NO. | PARTICULARS | AREA (SQMT) |
|---------------------------------|-------------------------------|------------------|
| 1 | TOTAL UNIT F.A.R AREA (F) | 156.245 |
| 2 | NON F.A.R AREA OF UNIT (J) | 34.729 |
| 3 | 15% SERVICES AREA OF UNIT (K) | 1.790 |
| TOTAL UNIT COVERAGE AREA | | = 192.763 |

LAL SINGH
Digitally signed by LAL SINGH
Date: 2025.01.27
17:32:52
+05'30'

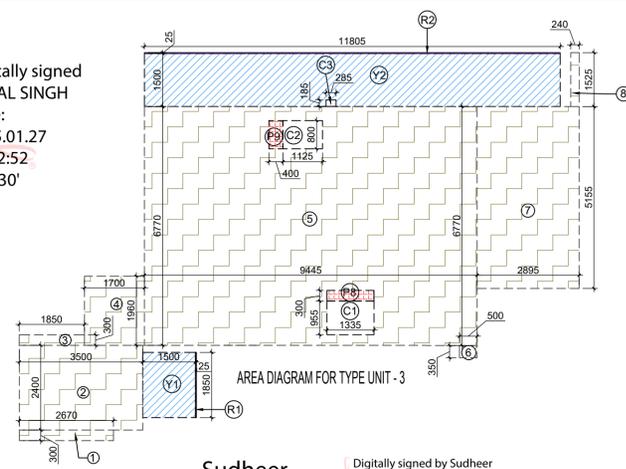

Sudheer Kumar
Digitally signed by Sudheer Kumar
Date: 2025.01.28 14:09:32
+05'30'

Amit Varma
Digitally signed by Amit Varma
Date: 2025.01.25
16:45:09 +05'30'

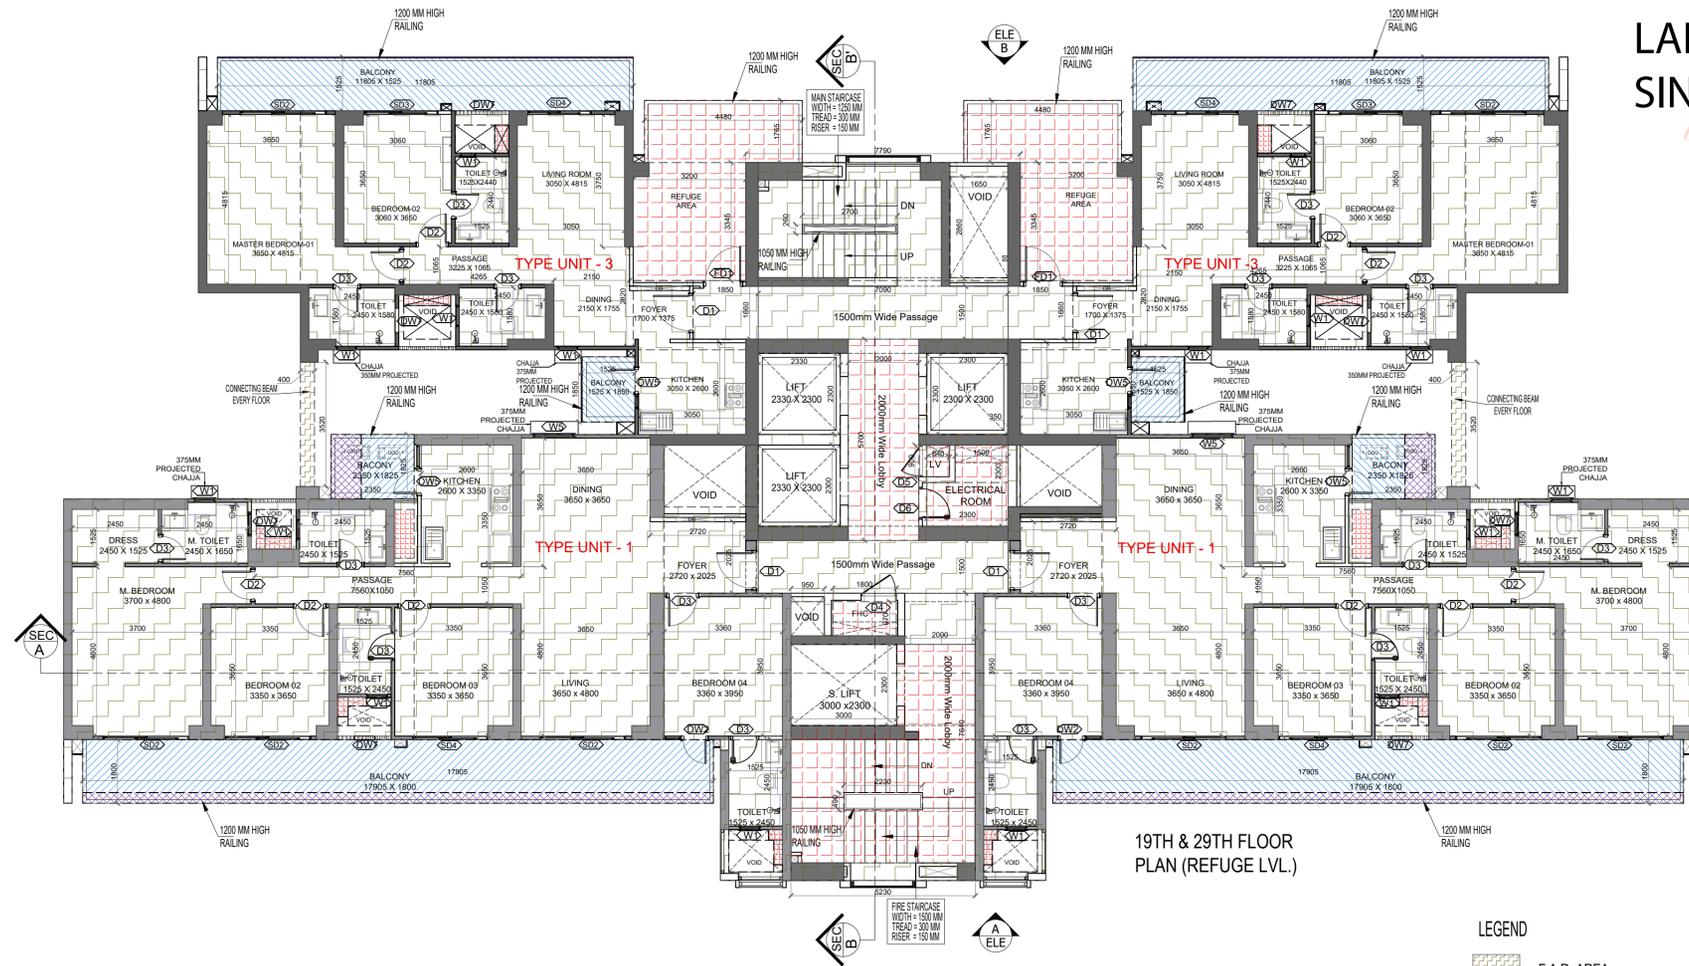

- LEGEND**
- F.A.R AREA
 - 15% SERVICES AREA
 - NON F.A.R AREA
 - COUNTED IN 1/4 F.A.R AREA

REFUGE AREA REQUIRED -
- 748.327 SQMTR (BLDG. PLATE) X 2 FLOORS X 0.3
= 448.996 / 12.5 + 0.9 SQM (for spec. added)
= 36.820 SQM. SAY - 37.00 SQM.
REFUGE AREA PROPOSED = 37.222 SQM

F.A.R. COVERED AREA CALCULATION FOR TYPE UNIT - 3

| S.NO. | PARTICULARS | AREA (SQMT) |
|----------------------------|---------------|-----------------|
| 1 | 2.670 X 0.300 | = 0.801 |
| 2 | 3.500 X 2.400 | = 8.400 |
| 3 | 1.850 X 0.300 | = 0.555 |
| 4 | 1.700 X 1.960 | = 3.332 |
| 5 | 9.445 X 6.770 | = 63.943 |
| 6 | 0.500 X 0.350 | = 0.175 |
| 7 | 2.895 X 5.155 | = 14.924 |
| 8 | 0.240 X 1.525 | = 0.366 |
| UNIT FAR AREA = (A) | | = 92.495 |

AREA SUBTRACTION PLUMBING CUTOUT

| | | |
|-------------------------------------|---------------|-----------------|
| P8 | 1.335 X 0.300 | = 0.401 |
| P9 | 0.400 X 0.810 | = 0.324 |
| C1 | 1.335 X 0.955 | = 1.275 |
| C2 | 1.125 X 0.800 | = 0.900 |
| TOTAL (B) | | = 2.899 |
| TOTAL F.A.R AREA C = (A - B) | | = 89.596 |

1/4 F.A.R AREA OF BALCONY

| | | |
|--|----------------|-----------------|
| R1 | 0.025 X 1.850 | = 0.046 |
| R2 | 11.805 X 0.025 | = 0.295 |
| TOTAL AREA (D) | | = 0.341 |
| 1/4 BALCONY F.A.R AREA (E) | | = 0.085 |
| TOTAL UNIT F.A.R AREA F = (C + E) | | = 89.681 |

NON F.A.R AREA OF BALCONY

| | | |
|------------------------------------|----------------|-----------------|
| Y1 | 1.500 X 1.625 | = 2.438 |
| Y2 | 17.905 X 1.500 | = 26.858 |
| 3/4 AREA OF BALCONY (D - E) | | = 0.256 |
| TOTAL (G) | | = 20.739 |

AREA SUBTRACTION


| | | |
|---------------------------------------|---------------|-----------------|
| C3 | 0.285 X 0.185 | = 0.053 |
| TOTAL AREA (H) | | = 0.053 |
| TOTAL BALCONY AREA J = (G - H) | | = 20.686 |

15% SERVICES AREA OF UNIT (PLUMBING SHAFT)

| | | |
|--|---------------|----------------|
| P8 | 1.335 X 0.300 | = 0.401 |
| P9 | 0.400 X 0.800 | = 0.320 |
| TOTAL 15% SERVICES AREA OF UNIT (K) | | = 0.721 |

TOTAL 15% SERVICES AREA OF UNIT (K)

| | | |
|---|--|-----------------|
| COVERAGE AREA FOR UNIT = (F + J + K) | | = 89.681 |
| 1 TOTAL UNIT F.A.R AREA (F) | | = 89.681 |
| 2 NON FAR AREA OF UNIT (J) | | = 20.686 |
| 3 15% SERVICES AREA OF UNIT (K) | | = 0.721 |
| TOTAL UNIT COVERAGE AREA | | 111.088 |

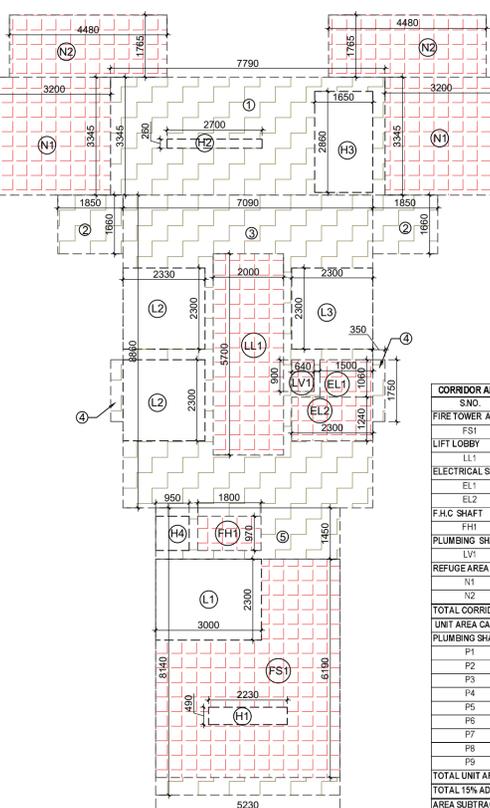

F.A.R. COVERED AREA CALCULATION FOR CIRCULATION AREA

| S.NO. | PARTICULARS | AREA (SQMT) |
|-----------------------|-------------------|------------------|
| 1 | 7.790 X 3.345 | = 26.058 |
| 2 | 1.850 X 1.660 X 2 | = 6.142 |
| 3 | 7.090 X 8.860 | = 62.817 |
| 4 | 0.950 X 1.750 X 2 | = 3.325 |
| 5 | 5.230 X 8.140 | = 42.572 |
| TOTAL AREA (A) | | = 138.814 |

AREA SUBTRACTION

| | | |
|--|-------------------|-----------------|
| FS1 | 5.230 X 6.190 | = 32.374 |
| LL1 | 2.000 X 5.700 | = 11.400 |
| EL1 | 1.500 X 1.060 | = 1.590 |
| EL2 | 2.300 X 1.240 | = 2.852 |
| FH1 | 1.800 X 0.970 | = 1.746 |
| LV1 | 0.640 X 0.900 | = 0.576 |
| H2 | 2.700 X 0.260 | = 0.702 |
| H3 | 1.650 X 2.680 | = 4.419 |
| H4 | 0.950 X 0.970 | = 0.922 |
| L2 | 2.330 X 2.300 X 2 | = 10.718 |
| L3 | 2.300 X 2.300 | = 5.290 |
| TOTAL (B) | | = 72.888 |
| TOTAL F.A.R AREA CORRIDOR C = (A - B) | | = 65.926 |

TOTAL F.A.R. AREA AT 19TH & 29TH FLOORPLAN (REFUGE LVL.)


| S.NO. | PARTICULARS | AREA (SQMT) |
|---------------------------------------|-------------|----------------|
| F.A.R. AREA OF UNIT - 1 | | 312.490 |
| F.A.R. AREA OF UNIT - 3 | | 179.963 |
| F.A.R. AREA OF CIRCULATION | | 65.926 |
| F.A.R. AREA OF CONNECTING BEAM | | 2.816 |
| TOTAL F.A.R AREA | | 560.594 |

TOTAL NON F.A.R. AREA AT 19TH & 29TH FLOOR PLAN (REFUGE LVL.)

| | | |
|---------------------------|--|----------------|
| UNIT - 1 | | 69.458 |
| UNIT - 3 | | 41.372 |
| TOTAL BALCONY AREA | | 110.829 |

E.A.R. AREA AT CONNECTING BEAM (EVERY FLOOR)

| | | | |
|-------------------------|-------------------|--------------------|--------------------|
| S.NO. | | PARTICULARS | AREA (SQMT) |
| 1 | 0.400 X 3.520 X 2 | = 2.816 | |
| TOTAL F.A.R AREA | | = 2.816 | |

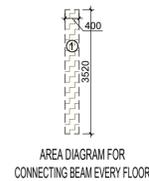

CORRIDOR AREA CALCULATION TOWARDS 15% ADDITIONAL F.A.R


| S.NO. | PARTICULARS | AREA (SQMT) |
|---|-------------------|-----------------|
| FIRE TOWER AREA | | |
| FS1 | 5.230 X 6.190 | = 32.374 |
| LIFT LOBBY | | |
| LL1 | 2.000 X 5.700 | = 11.400 |
| ELECTRICAL SHAFT & LV SHAFT | | |
| EL1 | 1.500 X 1.060 | = 1.590 |
| EL2 | 2.300 X 1.240 | = 2.852 |
| F.A.C. SHAFT | | |
| FH1 | 1.800 X 0.970 | = 1.746 |
| PLUMBING SHAFT | | |
| LV1 | 0.640 X 0.900 | = 0.576 |
| REFUGE AREA | | |
| N1 | 3.200 X 3.345 X 2 | = 21.468 |
| N2 | 4.480 X 1.765 X 2 | = 15.814 |
| TOTAL CORRIDOR AREA CALCULATION TOWARDS 15% ADDITIONAL F.A.R (A) | | = 87.760 |

UNIT AREA CALCULATION TOWARDS 15% ADDITIONAL F.A.R

| | | |
|--|-------------------|-----------------|
| PLUMBING SHAFT | | |
| P1 | 0.560 X 1.385 X 2 | = 1.551 |
| P2 | 0.740 X 0.350 X 2 | = 0.518 |
| P3 | 0.250 X 0.655 X 2 | = 0.328 |
| P4 | 0.525 X 0.250 X 2 | = 0.263 |
| P5 | 0.300 X 0.550 X 2 | = 0.330 |
| P6 | 0.400 X 0.300 X 2 | = 0.240 |
| P7 | 0.250 X 0.700 X 2 | = 0.350 |
| P8 | 1.335 X 0.300 X 2 | = 0.801 |
| P9 | 0.400 X 0.800 X 2 | = 0.640 |
| TOTAL UNIT AREA CALCULATION TOWARDS 15% ADDITIONAL F.A.R (B) | | = 5.029 |
| TOTAL 15% ADDITIONAL F.A.R AREA (CORRIDOR AREA + UNIT AREA) = C (A + B) | | = 92.789 |

AREA SUBTRACTION

| | | |
|--|--|-----------------|
| H1 | | 1.093 |
| L1 | | 6.900 |
| TOTAL AREA (D) | | 7.993 |
| TOTAL 15% ADDITIONAL F.A.R AREA E = (C - D) | | = 84.788 |

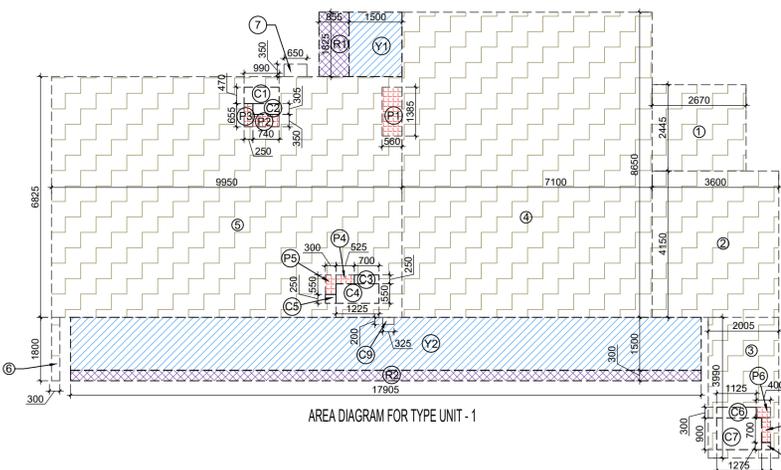

OWNER SIGN: **Rajath pathak** 2025.01.23 12:25:30 +05'30'

ARCHITECT SIGN: **AVANISH SRIVASTAV** 2025.01.23 12:25:39 +05'30'

TOWN PLANNER SIGN:

DOOR SCHEDULE

| S.NO. | DOOR TYPE | HEIGHT | W.D. | FINISH | LOCATION | DESCRIPTION |
|-------|-----------|--------|------|--------|----------|----------------------------|
| 1 | SD1 | 2000 | 900 | SSD | DOOR | UPVC FRAME SLIP CLOSE DOOR |
| 2 | SD2 | 2000 | 900 | SSD | DOOR | UPVC FRAME SLIP CLOSE DOOR |
| 3 | SD3 | 2000 | 900 | SSD | DOOR | UPVC FRAME SLIP CLOSE DOOR |
| 4 | SD4 | 2000 | 900 | SSD | DOOR | UPVC FRAME SLIP CLOSE DOOR |
| 5 | SD5 | 2000 | 900 | SSD | DOOR | UPVC FRAME SLIP CLOSE DOOR |
| 6 | SD6 | 2000 | 900 | SSD | DOOR | UPVC FRAME SLIP CLOSE DOOR |
| 7 | SD7 | 2000 | 900 | SSD | DOOR | UPVC FRAME SLIP CLOSE DOOR |
| 8 | SD8 | 2000 | 900 | SSD | DOOR | UPVC FRAME SLIP CLOSE DOOR |
| 9 | SD9 | 2000 | 900 | SSD | DOOR | UPVC FRAME SLIP CLOSE DOOR |
| 10 | SD10 | 2000 | 900 | SSD | DOOR | UPVC FRAME SLIP CLOSE DOOR |
| 11 | SD11 | 2000 | 900 | SSD | DOOR | UPVC FRAME SLIP CLOSE DOOR |
| 12 | SD12 | 2000 | 900 | SSD | DOOR | UPVC FRAME SLIP CLOSE DOOR |
| 13 | SD13 | 2000 | 900 | SSD | DOOR | UPVC FRAME SLIP CLOSE DOOR |
| 14 | SD14 | 2000 | 900 | SSD | DOOR | UPVC FRAME SLIP CLOSE DOOR |
| 15 | SD15 | 2000 | 900 | SSD | DOOR | UPVC FRAME SLIP CLOSE DOOR |
| 16 | SD16 | 2000 | 900 | SSD | DOOR | UPVC FRAME SLIP CLOSE DOOR |
| 17 | SD17 | 2000 | 900 | SSD | DOOR | UPVC FRAME SLIP CLOSE DOOR |
| 18 | SD18 | 2000 | 900 | SSD | DOOR | UPVC FRAME SLIP CLOSE DOOR |
| 19 | SD19 | 2000 | 900 | SSD | DOOR | UPVC FRAME SLIP CLOSE DOOR |
| 20 | SD20 | 2000 | 900 | SSD | DOOR | UPVC FRAME SLIP CLOSE DOOR |

WINDOW SCHEDULE

| S.NO. | WINDOW TYPE | HEIGHT | W.D. | FINISH | LOCATION | DESCRIPTION |
|-------|-------------|--------|------|--------|----------|---------------------------------|
| 1 | W1 | 1000 | 1000 | SSD | WALL | UPVC FRAME DOUBLE GLAZED WINDOW |
| 2 | W2 | 1000 | 1000 | SSD | WALL | UPVC FRAME DOUBLE GLAZED WINDOW |
| 3 | W3 | 1000 | 1000 | SSD | WALL | UPVC FRAME DOUBLE GLAZED WINDOW |
| 4 | W4 | 1000 | 1000 | SSD | WALL | UPVC FRAME DOUBLE GLAZED WINDOW |
| 5 | W5 | 1000 | 1000 | SSD | WALL | UPVC FRAME DOUBLE GLAZED WINDOW |
| 6 | W6 | 1000 | 1000 | SSD | WALL | UPVC FRAME DOUBLE GLAZED WINDOW |
| 7 | W7 | 1000 | 1000 | SSD | WALL | UPVC FRAME DOUBLE GLAZED WINDOW |
| 8 | W8 | 1000 | 1000 | SSD | WALL | UPVC FRAME DOUBLE GLAZED WINDOW |
| 9 | W9 | 1000 | 1000 | SSD | WALL | UPVC FRAME DOUBLE GLAZED WINDOW |
| 10 | W10 | 1000 | 1000 | SSD | WALL | UPVC FRAME DOUBLE GLAZED WINDOW |
| 11 | W11 | 1000 | 1000 | SSD | WALL | UPVC FRAME DOUBLE GLAZED WINDOW |
| 12 | W12 | 1000 | 1000 | SSD | WALL | UPVC FRAME DOUBLE GLAZED WINDOW |
| 13 | W13 | 1000 | 1000 | SSD | WALL | UPVC FRAME DOUBLE GLAZED WINDOW |
| 14 | W14 | 1000 | 1000 | SSD | WALL | UPVC FRAME DOUBLE GLAZED WINDOW |
| 15 | W15 | 1000 | 1000 | SSD | WALL | UPVC FRAME DOUBLE GLAZED WINDOW |
| 16 | W16 | 1000 | 1000 | SSD | WALL | UPVC FRAME DOUBLE GLAZED WINDOW |
| 17 | W17 | 1000 | 1000 | SSD | WALL | UPVC FRAME DOUBLE GLAZED WINDOW |
| 18 | W18 | 1000 | 1000 | SSD | WALL | UPVC FRAME DOUBLE GLAZED WINDOW |
| 19 | W19 | 1000 | 1000 | SSD | WALL | UPVC FRAME DOUBLE GLAZED WINDOW |
| 20 | W20 | 1000 | 1000 | SSD | WALL | UPVC FRAME DOUBLE GLAZED WINDOW |

OWNER: **GODREJ PROPERTIES LIMITED**

SUBMISSION DRAWING

KEY PLAN

PROPOSED GROUP HOUSING FOR PLOT NO. - GH-01/B,C,D,E,J & K SECTOR-12, GREATER NOIDA, G.B. NAGAR, (U.P.)

TOWER-2 S+34

DATE: 08-01-2025 PROJECT INCH: BALRAJ SINGH CHECKED BY: BALRAJ SINGH

SCALE: 1:100 DEALT BY: ABDHESH JHA APPROVED BY: VISHAL SHARMA

DRAWING TITLE: 19TH & 29TH FLOOR PLAN (REFUGE LVL.)

TOWER-2


ARCHITECTS: **GOLDEN INDIA ARCHITECTS**
THE TEAM OF ARCHITECTS
FF-37, KADAMBA SHOPPING COMPLEX
GAMMA-IGREATER NOIDA
CON. + 91-94-1585-6777

DESIGN BY: **Confluence**
NEW DELHI, INDIA


F-1, FIRST FLOOR, MIRA CORPORATE SUITES,
ISHWAR NAGAR, NEW DELHI 110065

Ph: +91-11-26925684 cs@confluence.com Member of IGBC
Ph: +91-11-40564768 www.confluence.com ISO: 9001:2000
architecture urban design hospitality interiors

DRAWING NO. **S-22** REVISION

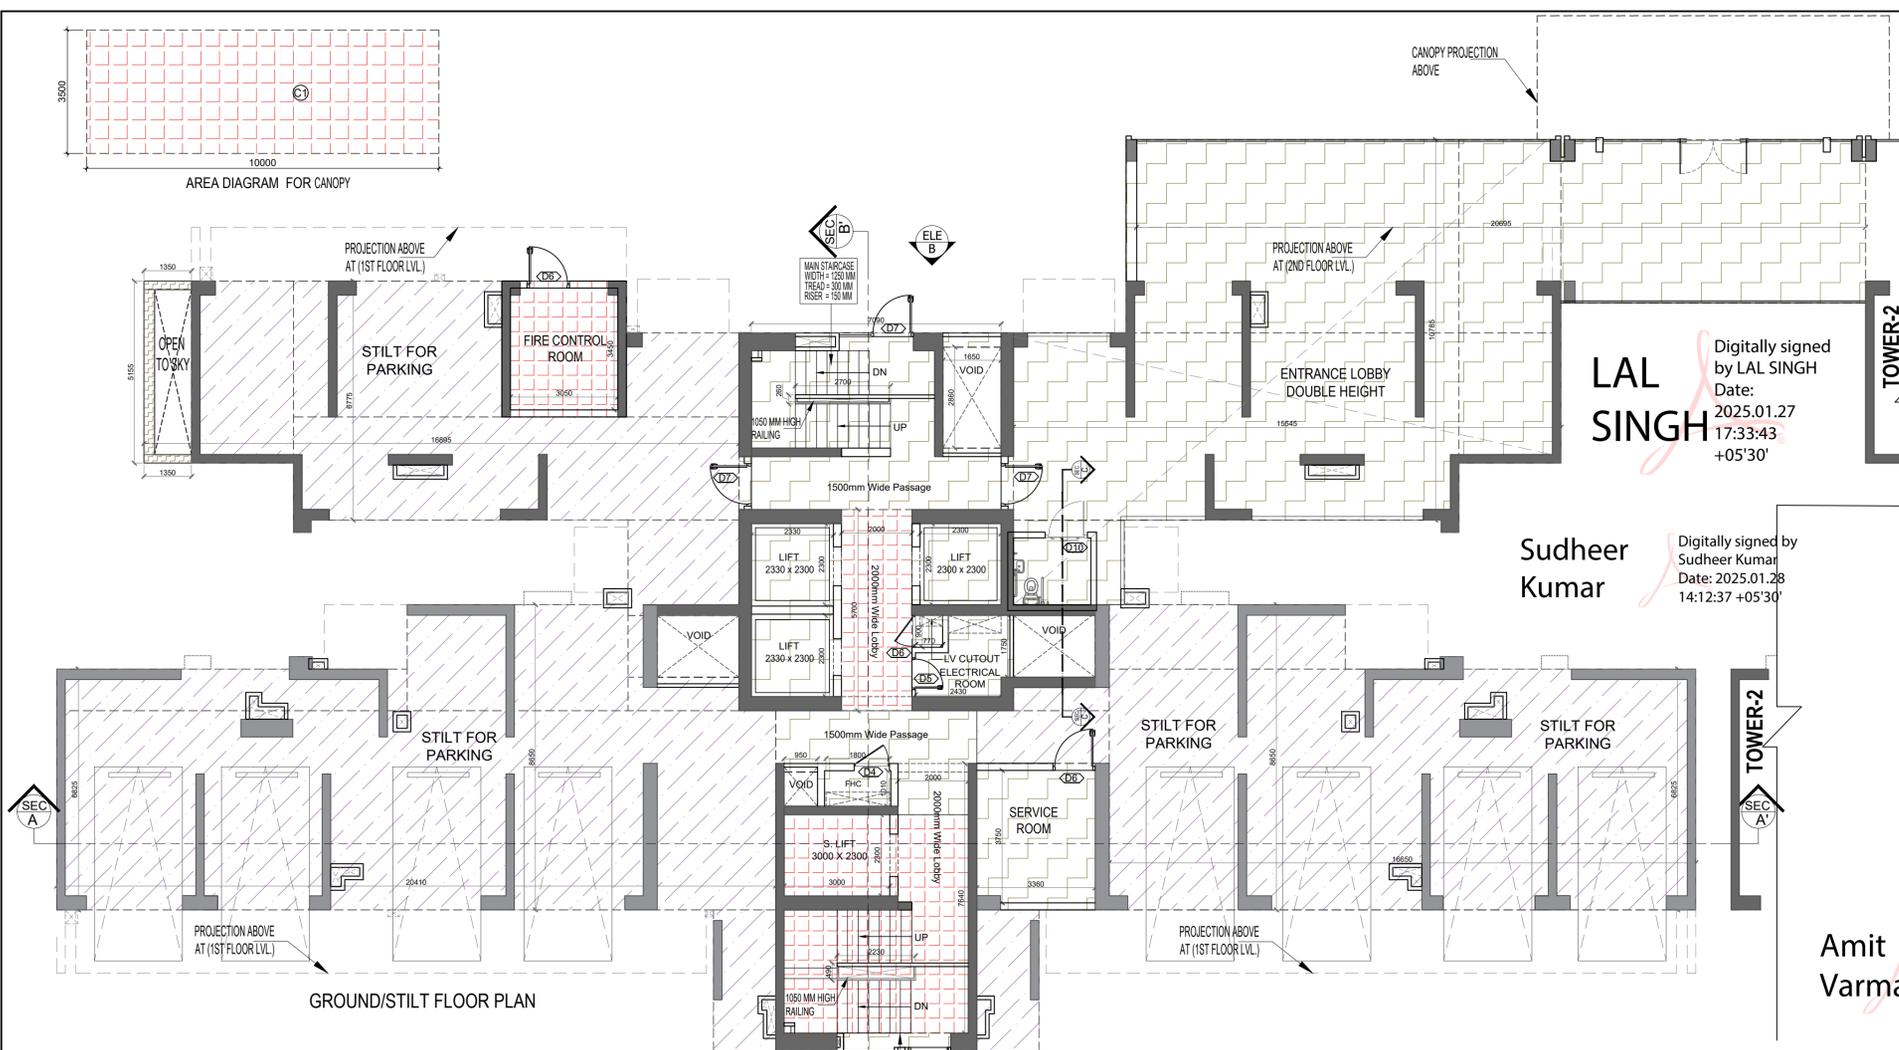

GROUND/STILT FLOOR PLAN

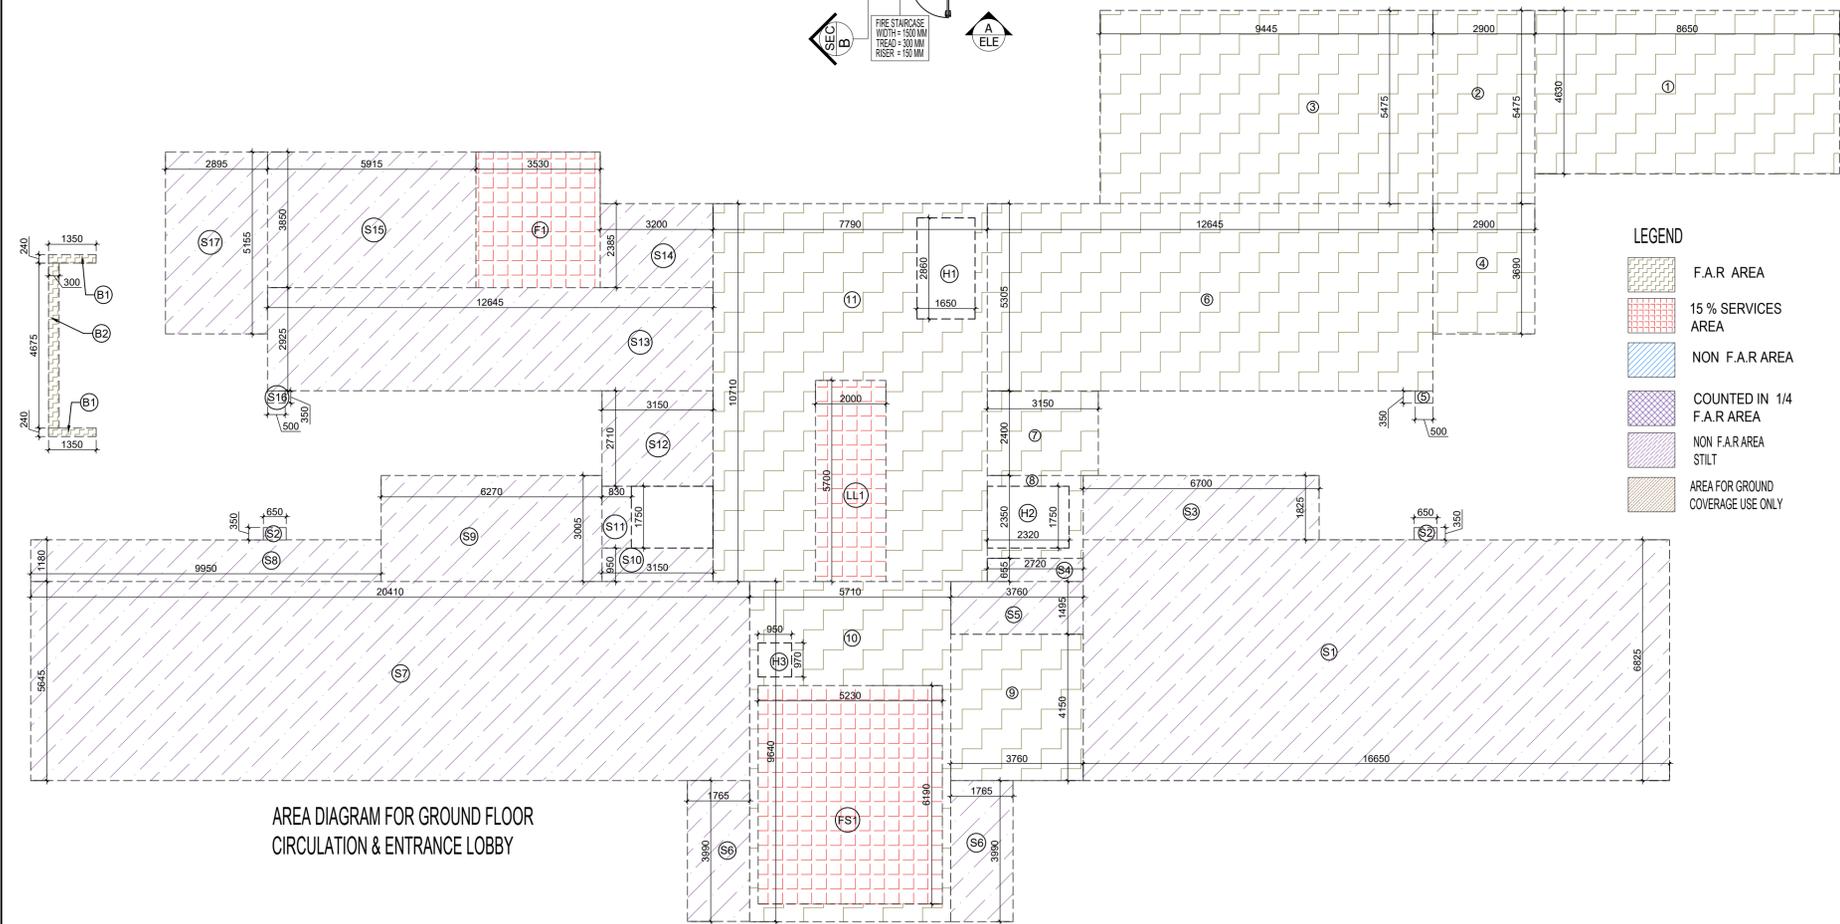

AREA DIAGRAM FOR GROUND FLOOR CIRCULATION & ENTRANCE LOBBY

LEGEND

- F.A.R AREA
- 15% SERVICES AREA
- NON F.A.R AREA
- COUNTED IN 1/4 F.A.R AREA
- NON F.A.R AREA STILT
- AREA FOR GROUND COVERAGE USE ONLY

F.A.R. COVERED AREA CALCULATION FOR CIRCULATION AREA AT GROUND FLOOR / STILT LOBBY

| S.NO. | WIDTH | LENGTH | AREA (SQMT) | | | | |
|-----------------------------|--------|--------|-------------|---|--------|----------|----------------|
| 1 | 8.650 | X | 4.630 | = | 40.350 | | |
| 2 | 2.900 | X | 5.475 | = | 15.878 | | |
| 3 | 9.445 | X | 5.475 | = | 51.711 | | |
| 4 | 2.900 | X | 3.850 | = | 10.701 | | |
| 5 | 0.500 | X | 0.350 | = | 0.175 | | |
| 6 | 12.845 | X | 5.305 | = | 67.982 | | |
| 7 | 3.150 | X | 2.400 | = | 7.560 | | |
| 8 | 2.720 | X | 2.350 | = | 6.392 | | |
| 9 | 3.750 | X | 4.150 | = | 15.604 | | |
| 10 | 5.710 | X | 9.640 | = | 56.044 | | |
| 11 | 7.790 | X | 10.710 | = | 83.431 | | |
| B1 | 1.350 | X | 0.240 | X | 2 | = | 0.648 |
| B2 | 0.300 | X | 4.675 | X | 2 | = | 1.403 |
| TOTAL F.A.R AREA (A) | | | | | | = | 355.678 |

AREA CALCULATION TOWARDS 15% ADDITIONAL F.A.R AT GROUND FLOOR / STILT LOBBY

| S.NO. | PARTICULARS | AREA (SQMT) |
|--|---------------|------------------|
| FS1 | 5.230 X 6.190 | = 32.374 |
| LL1 | 2.000 X 5.700 | = 11.400 |
| H1 | 1.650 X 2.850 | = 4.719 |
| H2 | 2.320 X 1.750 | = 4.060 |
| H3 | 0.950 X 0.970 | = 0.922 |
| TOTAL (B) | | = 53.474 |
| TOTAL F.A.R AREA CORRIDOR C = (A - B) | | = 302.204 |

NON F.A.R. AREA CALCULATION FOR GROUND FLOOR / STILT AREA

| S.NO. | WIDTH | LENGTH | AREA (SQMT) | | | | |
|---|--------|--------|-------------|----------------|---------|---|--------|
| S1 | 16.650 | X | 6.625 | = | 110.638 | | |
| S2 | 0.650 | X | 0.350 | X | 2 | = | 0.455 |
| S3 | 6.700 | X | 1.625 | X | 2 | = | 12.228 |
| S4 | 2.720 | X | 0.655 | = | 1.782 | | |
| S5 | 3.750 | X | 1.485 | = | 5.521 | | |
| S6 | 1.755 | X | 3.950 | X | 2 | = | 14.085 |
| S7 | 20.410 | X | 5.645 | = | 115.214 | | |
| S8 | 9.950 | X | 1.180 | = | 11.741 | | |
| S9 | 6.270 | X | 3.005 | = | 18.841 | | |
| S10 | 3.150 | X | 0.850 | = | 2.669 | | |
| S11 | 0.830 | X | 1.750 | = | 1.453 | | |
| S12 | 3.150 | X | 2.710 | = | 8.537 | | |
| S13 | 12.845 | X | 2.325 | = | 29.969 | | |
| S14 | 3.200 | X | 2.385 | = | 7.632 | | |
| S15 | 5.915 | X | 3.850 | = | 22.773 | | |
| S16 | 0.500 | X | 0.350 | = | 0.175 | | |
| S17 | 2.855 | X | 5.155 | = | 14.924 | | |
| TOTAL NON F.A.R AREA STILT PARKING | | | = | 389.075 | | | |

TOTAL F.A.R. AREA AT GROUND FLOOR/STILT LVL

| S.NO. | PARTICULARS | AREA (SQMT) |
|-------------------------|--|------------------|
| 1 | F.A.R AREA OF CIRCULATION & ENTRANCE LOBBY | = 302.204 |
| TOTAL F.A.R AREA | | = 302.204 |

TOWER - 3

| | GROUND / STILT. FLOOR (F.A.R) | F.A.R. AREA | 15% AREA | STILT NON F.A.R AREA (PARKING) | NON F.A.R AREA (BALCONY) |
|--------------------------------|-------------------------------|------------------|-----------------|--------------------------------|--------------------------|
| GROUND / STILT. FLOOR (F.A.R) | 810.694 | 302.204 | 92.364 | 389.075 | 0.000 |
| 1ST / PODIUM FLOOR AREA | | 483.646 | 44.335 | | 34.729 |
| 2nd FLOOR AREA | | 584.085 | 47.565 | | 118.727 |
| 3rd FLOOR AREA | | 584.085 | 47.565 | | 118.727 |
| 4th FLOOR AREA | | 584.085 | 47.565 | | 118.727 |
| 5th FLOOR AREA | | 584.085 | 47.565 | | 118.727 |
| 6th FLOOR AREA | | 584.085 | 47.565 | | 118.727 |
| 7th FLOOR AREA | | 584.085 | 47.565 | | 118.727 |
| 8th FLOOR AREA | | 584.085 | 47.565 | | 118.727 |
| 9th FLOOR AREA | | 584.085 | 47.565 | | 118.727 |
| 10th FLOOR AREA | | 584.085 | 47.565 | | 118.727 |
| 11th FLOOR AREA | | 584.085 | 47.565 | | 118.727 |
| 12th FLOOR AREA | | 584.085 | 47.565 | | 118.727 |
| 13th FLOOR AREA | | 584.085 | 47.565 | | 118.727 |
| 14th FLOOR AREA | | 584.085 | 47.565 | | 118.727 |
| 15th FLOOR AREA | | 584.085 | 47.565 | | 118.727 |
| 16th FLOOR AREA | | 584.085 | 47.565 | | 118.727 |
| 17th FLOOR AREA | | 584.085 | 47.565 | | 118.727 |
| 18th FLOOR AREA | | 584.085 | 47.565 | | 118.727 |
| 19th FLOOR AREA (REFUGE FLOOR) | | 562.645 | 84.788 | | 110.829 |
| 20th FLOOR AREA | | 584.085 | 47.565 | | 118.727 |
| 21st FLOOR AREA | | 584.085 | 47.565 | | 118.727 |
| 22nd FLOOR AREA | | 584.085 | 47.565 | | 118.727 |
| 23rd FLOOR AREA | | 584.085 | 47.565 | | 118.727 |
| 24th FLOOR AREA | | 584.085 | 47.565 | | 118.727 |
| 25th FLOOR AREA | | 584.085 | 47.565 | | 118.727 |
| 26th FLOOR AREA | | 584.085 | 47.565 | | 118.727 |
| 27th FLOOR AREA | | 584.085 | 47.565 | | 118.727 |
| 28th FLOOR AREA | | 584.085 | 47.565 | | 118.727 |
| 29th FLOOR AREA (REFUGE FLOOR) | | 562.645 | 84.788 | | 110.829 |
| 30th FLOOR AREA | | 584.085 | 47.565 | | 118.727 |
| 31st FLOOR AREA | | 584.085 | 47.565 | | 118.727 |
| 32nd FLOOR AREA | | 584.085 | 47.565 | | 118.727 |
| 33rd FLOOR AREA | | 584.085 | 47.565 | | 118.727 |
| 34th FLOOR AREA | | 584.085 | 47.565 | | 118.727 |
| TERRACE FLOOR | | 27.110 | 108.093 | | 73.459 |
| MACHINE ROOM LVL. | | | | | 48.306 |
| O.H TANK LVL. | | | | | |
| TOTAL | 810.694 | 20044.900 | 2010.653 | 389.075 | 3936.922 |

OWNER SIGN
Rajat pathak
2025.01.27
3 12:26:50
+05'30'

ARCHITECT SIGN
AVANI SH SRIVA STAV
AVANISH SRIVASTA
2025.01.27
3 12:26:41
+05'30'

DOOR SCHEDULE

| NO. | TYPE | WIDTH | LENGTH | UNIT | LOCATION | DESCRIPTION |
|-----|------|-------|--------|------|----------|-------------------------------|
| 1 | DOOR | 2000 | 2000 | DOOR | ENTRANCE | UPVC FRAME SLIDING GLASS DOOR |
| 2 | DOOR | 2000 | 2000 | DOOR | ENTRANCE | UPVC FRAME SLIDING GLASS DOOR |
| 3 | DOOR | 2000 | 2000 | DOOR | ENTRANCE | UPVC FRAME SLIDING GLASS DOOR |
| 4 | DOOR | 2000 | 2000 | DOOR | ENTRANCE | UPVC FRAME SLIDING GLASS DOOR |
| 5 | DOOR | 2000 | 2000 | DOOR | ENTRANCE | UPVC FRAME SLIDING GLASS DOOR |
| 6 | DOOR | 2000 | 2000 | DOOR | ENTRANCE | UPVC FRAME SLIDING GLASS DOOR |
| 7 | DOOR | 2000 | 2000 | DOOR | ENTRANCE | UPVC FRAME SLIDING GLASS DOOR |
| 8 | DOOR | 2000 | 2000 | DOOR | ENTRANCE | UPVC FRAME SLIDING GLASS DOOR |
| 9 | DOOR | 2000 | 2000 | DOOR | ENTRANCE | UPVC FRAME SLIDING GLASS DOOR |
| 10 | DOOR | 2000 | 2000 | DOOR | ENTRANCE | UPVC FRAME SLIDING GLASS DOOR |
| 11 | DOOR | 2000 | 2000 | DOOR | ENTRANCE | UPVC FRAME SLIDING GLASS DOOR |
| 12 | DOOR | 2000 | 2000 | DOOR | ENTRANCE | UPVC FRAME SLIDING GLASS DOOR |
| 13 | DOOR | 2000 | 2000 | DOOR | ENTRANCE | UPVC FRAME SLIDING GLASS DOOR |
| 14 | DOOR | 2000 | 2000 | DOOR | ENTRANCE | UPVC FRAME SLIDING GLASS DOOR |
| 15 | DOOR | 2000 | 2000 | DOOR | ENTRANCE | UPVC FRAME SLIDING GLASS DOOR |
| 16 | DOOR | 2000 | 2000 | DOOR | ENTRANCE | UPVC FRAME SLIDING GLASS DOOR |
| 17 | DOOR | 2000 | 2000 | DOOR | ENTRANCE | UPVC FRAME SLIDING GLASS DOOR |
| 18 | DOOR | 2000 | 2000 | DOOR | ENTRANCE | UPVC FRAME SLIDING GLASS DOOR |
| 19 | DOOR | 2000 | 2000 | DOOR | ENTRANCE | UPVC FRAME SLIDING GLASS DOOR |
| 20 | DOOR | 2000 | 2000 | DOOR | ENTRANCE | UPVC FRAME SLIDING GLASS DOOR |

WINDOW SCHEDULE

| NO. | TYPE | WIDTH | LENGTH | UNIT | LOCATION | DESCRIPTION |
|-----|--------|-------|--------|--------|----------|--|
| 1 | WINDOW | 1500 | 1500 | WINDOW | ENTRANCE | ALUMINUM UPVC FRAME DOUBLE GLAZED WINDOW |
| 2 | WINDOW | 1500 | 1500 | WINDOW | ENTRANCE | ALUMINUM UPVC FRAME DOUBLE GLAZED WINDOW |
| 3 | WINDOW | 1500 | 1500 | WINDOW | ENTRANCE | ALUMINUM UPVC FRAME DOUBLE GLAZED WINDOW |
| 4 | WINDOW | 1500 | 1500 | WINDOW | ENTRANCE | ALUMINUM UPVC FRAME DOUBLE GLAZED WINDOW |
| 5 | WINDOW | 1500 | 1500 | WINDOW | ENTRANCE | ALUMINUM UPVC FRAME DOUBLE GLAZED WINDOW |
| 6 | WINDOW | 1500 | 1500 | WINDOW | ENTRANCE | ALUMINUM UPVC FRAME DOUBLE GLAZED WINDOW |
| 7 | WINDOW | 1500 | 1500 | WINDOW | ENTRANCE | ALUMINUM UPVC FRAME DOUBLE GLAZED WINDOW |
| 8 | WINDOW | 1500 | 1500 | WINDOW | ENTRANCE | ALUMINUM UPVC FRAME DOUBLE GLAZED WINDOW |
| 9 | WINDOW | 1500 | 1500 | WINDOW | ENTRANCE | ALUMINUM UPVC FRAME DOUBLE GLAZED WINDOW |
| 10 | WINDOW | 1500 | 1500 | WINDOW | ENTRANCE | ALUMINUM UPVC FRAME DOUBLE GLAZED WINDOW |
| 11 | WINDOW | 1500 | 1500 | WINDOW | ENTRANCE | ALUMINUM UPVC FRAME DOUBLE GLAZED WINDOW |
| 12 | WINDOW | 1500 | 1500 | WINDOW | ENTRANCE | ALUMINUM UPVC FRAME DOUBLE GLAZED WINDOW |
| 13 | WINDOW | 1500 | 1500 | WINDOW | ENTRANCE | ALUMINUM UPVC FRAME DOUBLE GLAZED WINDOW |
| 14 | WINDOW | 1500 | 1500 | WINDOW | ENTRANCE | ALUMINUM UPVC FRAME DOUBLE GLAZED WINDOW |
| 15 | WINDOW | 1500 | 1500 | WINDOW | ENTRANCE | ALUMINUM UPVC FRAME DOUBLE GLAZED WINDOW |
| 16 | WINDOW | 1500 | 1500 | WINDOW | ENTRANCE | ALUMINUM UPVC FRAME DOUBLE GLAZED WINDOW |
| 17 | WINDOW | 1500 | 1500 | WINDOW | ENTRANCE | ALUMINUM UPVC FRAME DOUBLE GLAZED WINDOW |
| 18 | WINDOW | 1500 | 1500 | WINDOW | ENTRANCE | ALUMINUM UPVC FRAME DOUBLE GLAZED WINDOW |
| 19 | WINDOW | 1500 | 1500 | WINDOW | ENTRANCE | ALUMINUM UPVC FRAME DOUBLE GLAZED WINDOW |
| 20 | WINDOW | 1500 | 1500 | WINDOW | ENTRANCE | ALUMINUM UPVC FRAME DOUBLE GLAZED WINDOW |

OWNER
GODREJ PROPERTIES LIMITED

SUBMISSION DRAWING

KEY PLAN
TOWER - 3
S+34

PROJECT
PROPOSED GROUP HOUSING FOR PLOT NO. - GH-01/B,C,D,E,J & K SECTOR -12, GREATER NOIDA, G.B. NAGAR, (U.P.)

| DATE | PROJECT INCH. | CHECKED BY |
|----------------|---------------|---------------|
| 08 - 01 - 2025 | BALRAJ SINGH | BALRAJ SINGH |
| SCALE | DEALT BY | APPROVED BY |
| 1:100 | ABDRESH JHA | VISHAL SHARMA |

DRAWING TITLE
GROUND/STILT FLOOR PLAN


TOWER-3

ARCHITECTS
GOLDEN INDIA ARCHITECTS
THE TEAM OF ARCHITECTS
FF-37, KADAMBA SHOPPING COMPLEX
GAMMA-1 GREATER NOIDA
CON. +91-94-1585-6777

DESIGN BY:
Confluence
NEW DELHI, INDIA
F-1, FIRST FLOOR, MIRA CORPORATE SUITES,
ISHWAR NAGAR, NEW DELHI 110065

| PHONE | WEBSITE | MEMBER |
|---------------------|----------------------|-----------------|
| Ph: +91-11-26925684 | www.inconfluence.com | Member of IGBC |
| Ph: +91-11-40564768 | www.inconfluence.com | ISO - 9001:2000 |
| architecture | urban design | hospitality |
| interiors | | |

| DRAWING NO. | REVISION |
|-------------|----------|
| S-25 | |

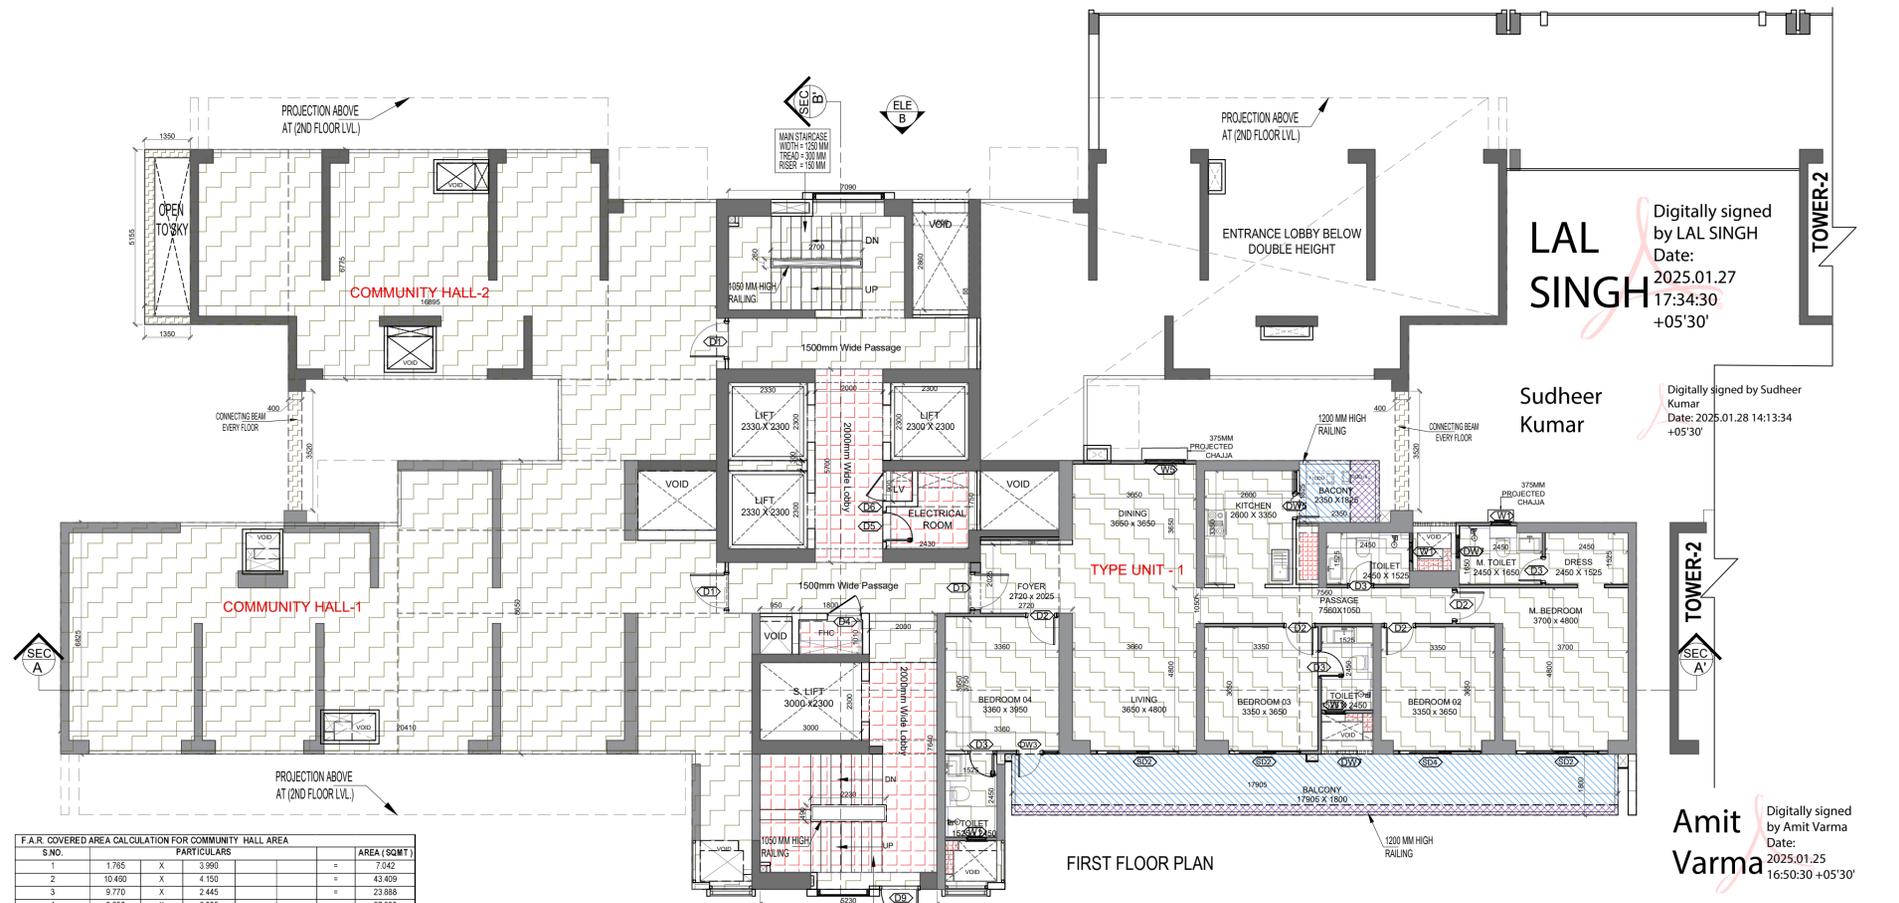

FIRST FLOOR PLAN

| S.NO. | PARTICULARS | | AREA (SQMT) |
|-------------------------------------|-------------|---------|------------------|
| 1 | 1.765 | X 3.990 | = 7.042 |
| 2 | 10.480 | X 4.150 | = 43.409 |
| 3 | 9.770 | X 2.445 | = 23.888 |
| 4 | 9.950 | X 6.825 | = 67.909 |
| 5 | 9.420 | X 2.055 | = 19.358 |
| 6 | 4.675 | X 2.400 | = 11.220 |
| 7 | 3.200 | X 5.305 | = 16.976 |
| 8 | 9.445 | X 6.770 | = 63.943 |
| 9 | 0.500 | X 0.350 | = 0.175 |
| 10 | 2.900 | X 5.155 | = 14.950 |
| TOTAL AREA (A) | | | = 268.869 |
| AREA SUBTRACTION | | | |
| C1 | 0.250 | X 0.195 | = 0.049 |
| C2 | 1.275 | X 0.900 | = 1.148 |
| C3 | 1.125 | X 0.300 | = 0.338 |
| C4 | 0.700 | X 0.800 | = 0.560 |
| C5 | 0.525 | X 0.550 | = 0.289 |
| C6 | 0.300 | X 0.250 | = 0.075 |
| C7 | 0.740 | X 0.305 | = 0.226 |
| C8 | 0.990 | X 0.470 | = 0.465 |
| C9 | 2.300 | X 1.750 | = 4.025 |
| C10 | 1.335 | X 0.965 | = 1.275 |
| C11 | 1.125 | X 0.800 | = 0.900 |
| TOTAL (B) | | | = 9.383 |
| TOTAL F.A.R AREA C = (A - B) | | | = 259.486 |

| S.NO. | PARTICULARS | | AREA (SQMT) |
|-------------------------|-------------|-----|------------------|
| 1 | 156.245 | X 1 | = 156.245 |
| 2 | 65.100 | X 1 | = 65.100 |
| 3 | 259.486 | X 1 | = 259.486 |
| 4 | 2.816 | X 1 | = 2.816 |
| TOTAL F.A.R AREA | | | = 483.646 |

| UNIT -1 | AREA (SQMT) | |
|---------------------------|-------------|-----------------|
| 34.729 | = 34.729 | |
| TOTAL BALCONY AREA | | = 34.729 |



| S.NO. | PARTICULARS | | AREA (SQMT) |
|-------------------------|-------------|---------|----------------|
| 1 | 0.600 | X 3.520 | = 2.112 |
| 2 | 0.600 | X 3.520 | = 2.112 |
| TOTAL F.A.R AREA | | | = 2.816 |

- LEGEND**
- F.A.R AREA
 - 15% SERVICES AREA
 - NON F.A.R AREA
 - COUNTED IN 1/4 F.A.R AREA

AREA DIAGRAM FOR CONNECTING BEAM EVERY FLOOR

TYPICAL SECTION THRU TOILET STILT

AREA DIAGRAM FOR TYPE UNIT - 1

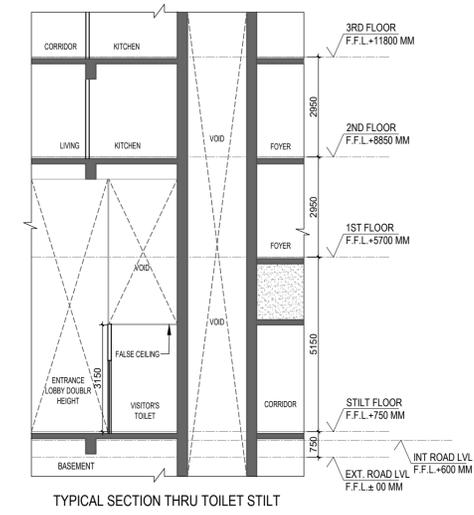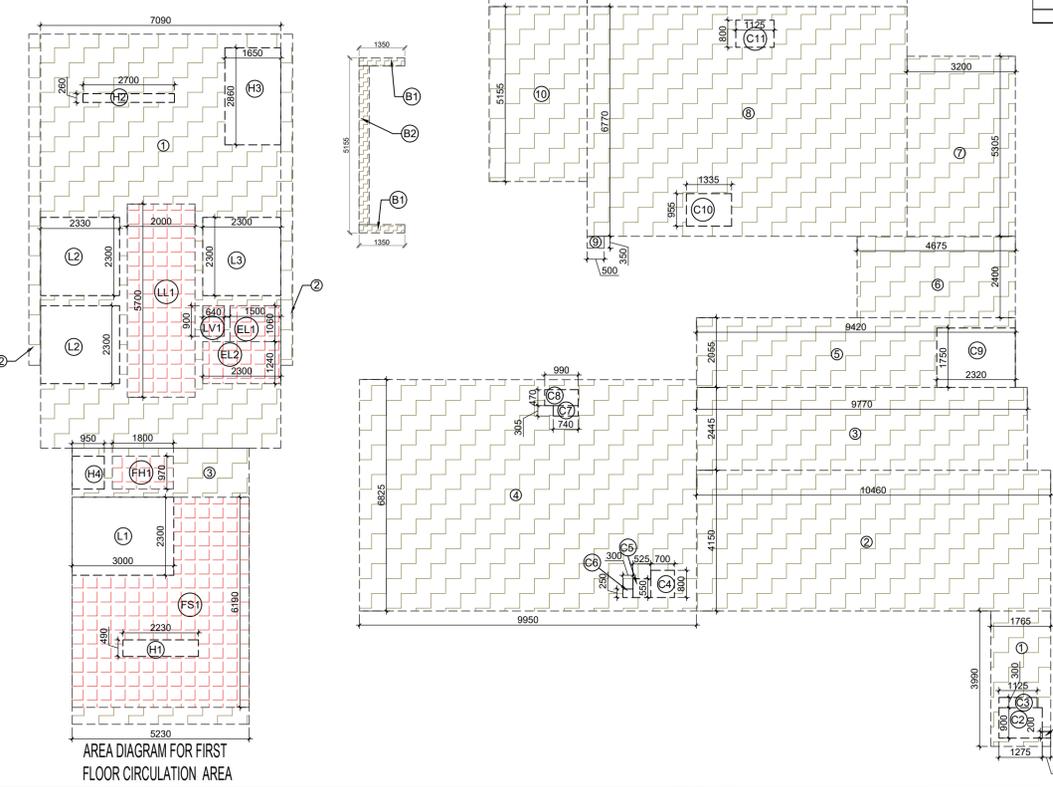

| S.NO. | PARTICULARS | | AREA (SQMT) |
|--|-------------|----------|------------------|
| 1 | 7.090 | X 12.205 | = 86.533 |
| 2 | 0.350 | X 9.760 | = 3.411 |
| 3 | 5.230 | X 8.140 | = 42.572 |
| B1 | 1.350 | X 0.240 | = 0.324 |
| B2 | 0.300 | X 4.675 | = 1.403 |
| TOTAL AREA (A) | | | = 137.988 |
| AREA SUBTRACTION | | | |
| FS1 | 5.230 | X 6.190 | = 32.374 |
| LL1 | 2.000 | X 5.700 | = 11.400 |
| EL1 | 1.500 | X 1.060 | = 1.590 |
| EL2 | 2.300 | X 1.240 | = 2.852 |
| FH1 | 1.800 | X 0.970 | = 1.746 |
| LV1 | 0.640 | X 0.900 | = 0.576 |
| H2 | 2.700 | X 0.260 | = 0.702 |
| H3 | 1.950 | X 2.850 | = 5.558 |
| H4 | 0.950 | X 0.970 | = 0.922 |
| L2 | 2.300 | X 2.300 | = 5.290 |
| L3 | 2.300 | X 2.300 | = 5.290 |
| TOTAL (B) | | | = 72.888 |
| TOTAL F.A.R AREA CORRIDOR C = (A - B) | | | = 65.100 |

| S.NO. | PARTICULARS | | AREA (SQMT) |
|--|-------------|---------|-----------------|
| FS1 | 5.230 | X 6.190 | = 32.374 |
| LL1 | 2.000 | X 5.700 | = 11.400 |
| EL1 | 1.500 | X 1.060 | = 1.590 |
| EL2 | 2.300 | X 1.240 | = 2.852 |
| FH1 | 1.800 | X 0.970 | = 1.746 |
| LV1 | 0.640 | X 0.900 | = 0.576 |
| TOTAL CORRIDOR AREA TOWARDS 15% ADDITIONAL F.A.R | | | = 50.538 |
| UNIT AREA CALCULATION TOWARDS 15% ADDITIONAL F.A.R | | | |
| PLUMBING SHAFT | | | |
| P1 | 0.560 | X 1.385 | = 0.776 |
| P2 | 0.740 | X 0.350 | = 0.259 |
| P3 | 0.250 | X 0.655 | = 0.164 |
| P4 | 0.525 | X 0.250 | = 0.131 |
| P5 | 0.300 | X 0.550 | = 0.165 |
| P6 | 0.400 | X 0.300 | = 0.120 |
| P7 | 0.250 | X 0.700 | = 0.175 |
| TOTAL UNIT AREA CALCULATION TOWARDS 15% ADDITIONAL F.A.R (B) | | | = 1.790 |
| TOTAL 15% ADDITIONAL F.A.R AREA (CORRIDOR AREA + UNIT AREA) = C + (A + B) | | | = 52.327 |
| AREA SUBTRACTION | | | |
| H1 | 2.230 | X 0.490 | = 1.093 |
| L1 | 3.000 | X 2.300 | = 6.900 |
| TOTAL AREA (D) | | | = 7.993 |
| TOTAL 15% ADDITIONAL F.A.R AREA E = (C + D) | | | = 44.335 |

| S.NO. | PARTICULARS | | AREA (SQMT) |
|---|-------------------------------|-----------|------------------|
| 1 | 2.670 | X 2.445 | = 6.528 |
| 2 | 3.600 | X 4.150 | = 14.940 |
| 3 | 2.005 | X 3.960 | = 7.941 |
| 4 | 7.100 | X 8.650 | = 61.415 |
| 5 | 9.950 | X 6.825 | = 67.909 |
| 6 | 0.240 | X 1.800 | = 0.432 |
| 7 | 0.850 | X 0.350 | = 0.298 |
| UNIT F.A.R AREA = (A) | | | = 159.451 |
| AREA SUBTRACTION PLUMBING CUTOUT | | | |
| P1 | 0.560 | X 1.385 | = 0.776 |
| P2 | 0.740 | X 0.350 | = 0.259 |
| P3 | 0.250 | X 0.655 | = 0.164 |
| P4 | 0.525 | X 0.250 | = 0.131 |
| P5 | 0.300 | X 0.550 | = 0.165 |
| P6 | 0.400 | X 0.300 | = 0.120 |
| P7 | 0.250 | X 0.700 | = 0.175 |
| C1 | 0.990 | X 0.470 | = 0.465 |
| C2 | 0.740 | X 0.305 | = 0.226 |
| C3 | 0.700 | X 0.250 | = 0.175 |
| C4 | 1.225 | X 0.550 | = 0.674 |
| C5 | 0.300 | X 0.250 | = 0.075 |
| C6 | 1.125 | X 0.300 | = 0.338 |
| C7 | 1.275 | X 0.960 | = 1.224 |
| C8 | 0.250 | X 0.200 | = 0.050 |
| TOTAL (B) | | | = 4.939 |
| TOTAL F.A.R AREA C = (A - B) | | | = 154.512 |
| 1/4 F.A.R AREA OF BALCONY | | | |
| R1 | 0.855 | X 1.825 | = 1.560 |
| R2 | 17.905 | X 0.300 | = 5.372 |
| TOTAL AREA (D) | | | = 6.932 |
| 1/4 BALCONY F.A.R AREA (E) | | | = 1.733 |
| TOTAL UNIT F.A.R AREA F = (C + E) | | | = 156.245 |
| NON F.A.R AREA OF BALCONY | | | |
| Y1 | 1.500 | X 1.825 | = 2.738 |
| Y2 | 17.905 | X 1.500 | = 26.858 |
| 3/4 AREA OF BALCONY (D - E) | | | = 5.199 |
| TOTAL (G) | | | = 34.794 |
| AREA SUBTRACTION | | | |
| C9 | 0.325 | X 0.200 | = 0.065 |
| TOTAL AREA (H) | | | = 0.065 |
| TOTAL BALCONY AREA J = (G - H) | | | = 34.729 |
| 15% SERVICES AREA OF UNIT (PLUMBING SHAFT) | | | |
| P1 | 0.560 | X 1.385 | = 0.776 |
| P2 | 0.740 | X 0.350 | = 0.259 |
| P3 | 0.250 | X 0.655 | = 0.164 |
| P4 | 0.525 | X 0.250 | = 0.131 |
| P5 | 0.300 | X 0.550 | = 0.165 |
| P6 | 0.400 | X 0.300 | = 0.120 |
| P7 | 0.250 | X 0.700 | = 0.175 |
| TOTAL 15% SERVICES AREA OF UNIT (K) | | | = 1.790 |
| COVERAGE AREA FOR UNIT = (F + J + K) | | | |
| 1 | TOTAL UNIT F.A.R AREA (F) | = 156.245 | |
| 2 | NON F.A.R AREA OF UNIT (J) | = 34.729 | |
| 3 | 15% SERVICES AREA OF UNIT (K) | = 1.790 | |
| TOTAL UNIT COVERAGE AREA | | | = 192.763 |

OWNER SIGN: Rajat pathak 2025.01.23 12:27:09 +05'30'

ARCHITECT SIGN: AVANISH SRIVASTAV 2025.01.23 12:27:09 +05'30'

TOWN PLANNER SIGN: GODREJ PROPERTIES LIMITED

SUBMISSION DRAWING

KEY PLAN: TOWER - 3 S+34

PROJECT: PROPOSED GROUP HOUSING FOR PLOT NO. - GH-01/B,C,D,E,J & K SECTOR - 12, GREATER NOIDA, G.B. NAGAR, (U.P.)

DATE: 08-01-2025 PROJECT INCH: BALRAJ SINGH CHECKED BY: BALRAJ SINGH

SCALE: 1:100 DEALT BY: ABDHESH JHA APPROVED BY: VISHAL SHARMA

DRAWING TITLE: FIRST FLOOR PLAN

TOWER-3

ARCHITECTS: GOLDEN INDIA ARCHITECTS

DESIGN BY: Confluence NEW DELHI, INDIA

F-1, FIRST FLOOR, MIRA CORPORATE SUITES, ISHWAR NAGAR, NEW DELHI 110065

Ph: +91-11-26925684 cc@inconfuence.com Member of IGBC Ph: +91-11-40564768 www.inconfuence.com ISO: 9001:2000 architecture urban design hospitality interiors

DRAWING NO. S-26 REVISION

DOOR SCHEDULE


| S.NO. | DOOR | LEVEL | LOC. | DESCRIPTION |
|-------|------|-------|--------|-------------|
| 1 | D01 | 2ND | TOILET | TOILET |
| 2 | D02 | 2ND | TOILET | TOILET |
| 3 | D03 | 2ND | TOILET | TOILET |
| 4 | D04 | 2ND | TOILET | TOILET |
| 5 | D05 | 2ND | TOILET | TOILET |
| 6 | D06 | 2ND | TOILET | TOILET |
| 7 | D07 | 2ND | TOILET | TOILET |
| 8 | D08 | 2ND | TOILET | TOILET |
| 9 | D09 | 2ND | TOILET | TOILET |
| 10 | D10 | 2ND | TOILET | TOILET |
| 11 | D11 | 2ND | TOILET | TOILET |
| 12 | D12 | 2ND | TOILET | TOILET |
| 13 | D13 | 2ND | TOILET | TOILET |
| 14 | D14 | 2ND | TOILET | TOILET |
| 15 | D15 | 2ND | TOILET | TOILET |
| 16 | D16 | 2ND | TOILET | TOILET |
| 17 | D17 | 2ND | TOILET | TOILET |
| 18 | D18 | 2ND | TOILET | TOILET |
| 19 | D19 | 2ND | TOILET | TOILET |
| 20 | D20 | 2ND | TOILET | TOILET |
| 21 | D21 | 2ND | TOILET | TOILET |
| 22 | D22 | 2ND | TOILET | TOILET |
| 23 | D23 | 2ND | TOILET | TOILET |
| 24 | D24 | 2ND | TOILET | TOILET |
| 25 | D25 | 2ND | TOILET | TOILET |
| 26 | D26 | 2ND | TOILET | TOILET |
| 27 | D27 | 2ND | TOILET | TOILET |
| 28 | D28 | 2ND | TOILET | TOILET |
| 29 | D29 | 2ND | TOILET | TOILET |
| 30 | D30 | 2ND | TOILET | TOILET |

WINDOW SCHEDULE

| S.NO. | WINDOW | LEVEL | LOC. | DESCRIPTION |
|-------|--------|-------|--------|-------------|
| 1 | W01 | 2ND | TOILET | TOILET |
| 2 | W02 | 2ND | TOILET | TOILET |
| 3 | W03 | 2ND | TOILET | TOILET |
| 4 | W04 | 2ND | TOILET | TOILET |
| 5 | W05 | 2ND | TOILET | TOILET |
| 6 | W06 | 2ND | TOILET | TOILET |
| 7 | W07 | 2ND | TOILET | TOILET |
| 8 | W08 | 2ND | TOILET | TOILET |
| 9 | W09 | 2ND | TOILET | TOILET |
| 10 | W10 | 2ND | TOILET | TOILET |
| 11 | W11 | 2ND | TOILET | TOILET |
| 12 | W12 | 2ND | TOILET | TOILET |
| 13 | W13 | 2ND | TOILET | TOILET |
| 14 | W14 | 2ND | TOILET | TOILET |
| 15 | W15 | 2ND | TOILET | TOILET |
| 16 | W16 | 2ND | TOILET | TOILET |
| 17 | W17 | 2ND | TOILET | TOILET |
| 18 | W18 | 2ND | TOILET | TOILET |
| 19 | W19 | 2ND | TOILET | TOILET |
| 20 | W20 | 2ND | TOILET | TOILET |
| 21 | W21 | 2ND | TOILET | TOILET |
| 22 | W22 | 2ND | TOILET | TOILET |
| 23 | W23 | 2ND | TOILET | TOILET |
| 24 | W24 | 2ND | TOILET | TOILET |
| 25 | W25 | 2ND | TOILET | TOILET |
| 26 | W26 | 2ND | TOILET | TOILET |
| 27 | W27 | 2ND | TOILET | TOILET |
| 28 | W28 | 2ND | TOILET | TOILET |
| 29 | W29 | 2ND | TOILET | TOILET |
| 30 | W30 | 2ND | TOILET | TOILET |

OWNER GODREJ PROPERTIES LIMITED

SUBMISSION DRAWING

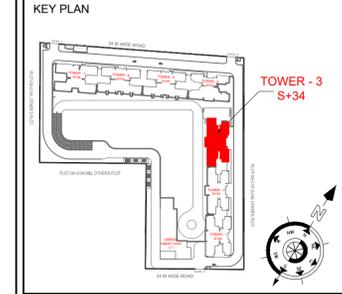

PROJECT PROPOSED GROUP HOUSING FOR PLOT NO :- GH-01/B,C,D,E,J & K SECTOR -12, GREATER NOIDA, G.B. NAGAR, (U.P.)

| | | |
|-----------------|----------------------------|---------------------------|
| DATE 08-01-2025 | PROJECT INCH. BALRAJ SINGH | CHECKED BY BALRAJ SINGH |
| SCALE 1:100 | DEALT BY ABDHESH JHA | APPROVED BY VISHAL SHARMA |

DRAWING TITLE 2ND TO 18TH, 20TH TO 28TH & 30TH TO 34TH FLOOR PLAN(TYPICAL)

ARCHITECTS GOLDEN INDIA ARCHITECTS


THE TEAM OF ARCHITECTS FF-37, KADAMBA SHOPPING COMPLEX GAMMA-I GREATER NOIDA CON...+91-94-1555-6777

DESIGN BY: Confluence NEW DELHI, INDIA

F-1, FIRST FLOOR, MIRA CORPORATE SUITES, ISHWAR NAGAR, NEW DELHI 110065

Ph: +91-11-26525684 ccs@confluence.com Member of IGBC Ph: +91-11-40564768 www.confluence.com 150 - 9001 - 2000 architecture urban design hospitality interiors

DRAWING NO. S-27 REVISION

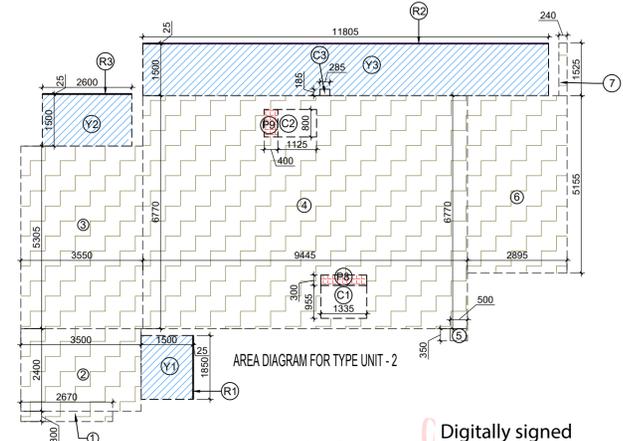

LAL SINGH Digitally signed by LAL SINGH Date: 2025.01.27 17:34:51 +05'30'

Sudheer Kumar Digitally signed by Sudheer Kumar Date: 2025.01.28 14:14:30 +05'30'

Amit Varma Digitally signed by Amit Varma Date: 2025.01.25 16:51:53 +05'30'



LEGEND

- F.A.R AREA
- 15% SERVICES AREA
- NON F.A.R AREA
- COUNTED IN 1/4 F.A.R AREA

TOTAL F.A.R. AREA AT 2ND TO 18TH, 20TH TO 28TH & 30TH TO 34TH FLOOR PLAN (TYPICAL)



| S.NO. | PARTICULARS | AREA (SQM) |
|------------------|-------------------------------|------------|
| 1 | F.A.R AREA OF UNIT - 1 | 156.245 |
| 2 | F.A.R AREA OF UNIT - 2 | 104.643 |
| 3 | F.A.R AREA OF CIRCULATION | 59.493 |
| 4 | F.A.R AREA OF CONNECTING BEAM | 2.816 |
| TOTAL F.A.R AREA | | 584.085 |

TOTAL NON. F.A.R. AREA AT 2ND TO 18TH, 20TH TO 28TH & 30TH TO 34TH FLOOR PLAN (TYPICAL)

| UNIT | AREA (SQM) | |
|--------------------|------------|---------|
| UNIT - 1 | 69.458 | |
| UNIT - 2 | 49.269 | |
| TOTAL BALCONY AREA | | 118.727 |

E.A.R. AREA AT CONNECTING BEAM (EVERY FLOOR)

| S.NO. | PARTICULARS | AREA (SQM) |
|------------------|-------------------|------------|
| 1 | 0.400 X 3.520 X 2 | 2.816 |
| TOTAL F.A.R AREA | | 2.816 |

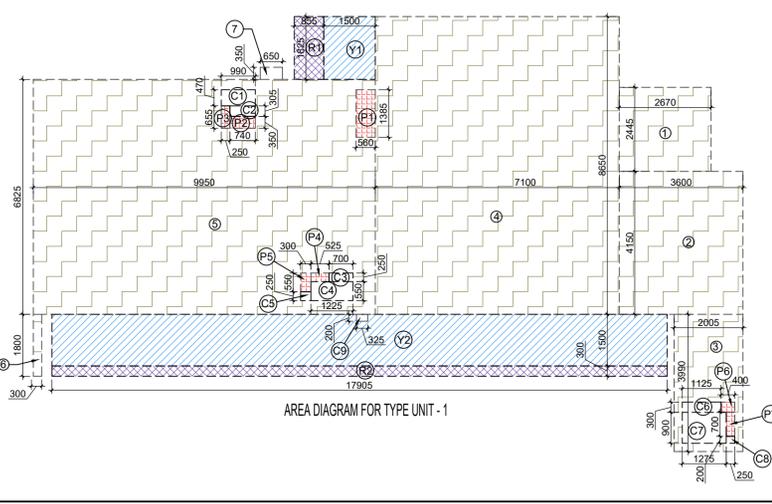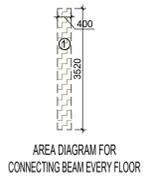

F.A.R. COVERED AREA CALCULATION FOR TYPE UNIT - 2

| S.NO. | PARTICULARS | AREA (SQM) | |
|--|----------------|------------|---------|
| 1 | 2.670 X 0.300 | 0.801 | |
| 2 | 3.500 X 2.400 | 8.400 | |
| 3 | 3.550 X 5.305 | 18.833 | |
| 4 | 9.445 X 6.770 | 63.943 | |
| 5 | 0.500 X 0.550 | 0.175 | |
| 6 | 2.855 X 5.155 | 14.524 | |
| 7 | 0.240 X 1.525 | 0.366 | |
| UNIT FAR AREA = (A) | | 107.441 | |
| AREA SUBTRACTION PLUMBING CUTOUT | | | |
| P8 | 1.335 X 0.300 | 0.401 | |
| P9 | 0.400 X 0.810 | 0.324 | |
| C1 | 1.335 X 0.955 | 1.275 | |
| C2 | 1.125 X 0.800 | 0.900 | |
| TOTAL (B) | | 2.899 | |
| TOTAL F.A.R AREA C = (A - B) | | 104.542 | |
| 1/4 F.A.R AREA OF BALCONY | | | |
| R1 | 0.025 X 1.850 | 0.046 | |
| R2 | 11.805 X 0.025 | 0.295 | |
| R3 | 2.600 X 0.025 | 0.065 | |
| TOTAL AREA (D) | | 0.406 | |
| 1/4 BALCONY F.A.R AREA (E) | | 0.102 | |
| TOTAL UNIT F.A.R AREA F = (C + E) | | 104.643 | |
| NON F.A.R AREA OF BALCONY | | | |
| Y1 | 1.500 X 1.850 | 2.775 | |
| Y2 | 2.600 X 1.500 | 3.900 | |
| Y3 | 11.805 X 1.500 | 17.708 | |
| 3/4 AREA OF BALCONY (D - E) | | 0.305 | |
| TOTAL (G) | | 24.687 | |
| AREA SUBTRACTION | | | |
| C3 | 0.285 X 1.185 | 0.063 | |
| TOTAL AREA (H) | | 0.053 | |
| TOTAL BALCONY AREA J = (G - H) | | 24.635 | |
| 15% SERVICES AREA OF UNIT (PLUMBING SHAFT) | | | |
| P8 | 1.335 X 0.300 | 0.401 | |
| P9 | 0.400 X 0.800 | 0.320 | |
| TOTAL 15% SERVICES AREA OF UNIT (K) | | 0.721 | |
| COVERAGE AREA FOR UNIT = (F + J + K) | | | 104.643 |
| TOTAL UNIT F.A.R AREA (F) | | | 104.643 |
| NON F.A.R AREA OF UNIT (J) | | | 24.635 |
| 15% SERVICES AREA OF UNIT (K) | | | 0.721 |
| TOTAL UNIT COVERAGE AREA | | | 129.998 |

F.A.R. COVERED AREA CALCULATION FOR TYPE UNIT - 1


| S.NO. | PARTICULARS | AREA (SQM) | |
|--|----------------|------------|---------|
| 1 | 2.670 X 2.445 | 6.528 | |
| 2 | 3.600 X 4.150 | 14.940 | |
| 3 | 2.005 X 3.990 | 8.000 | |
| 4 | 7.100 X 8.650 | 61.415 | |
| 5 | 9.950 X 6.825 | 67.909 | |
| 6 | 0.240 X 1.800 | 0.432 | |
| 7 | 0.650 X 0.350 | 0.228 | |
| UNIT FAR AREA = (A) | | 159.451 | |
| AREA SUBTRACTION PLUMBING CUTOUT | | | |
| P1 | 0.560 X 1.385 | 0.776 | |
| P2 | 0.740 X 0.350 | 0.259 | |
| P3 | 0.250 X 0.655 | 0.164 | |
| P4 | 0.525 X 0.250 | 0.131 | |
| P5 | 0.300 X 0.550 | 0.165 | |
| P6 | 0.400 X 0.300 | 0.120 | |
| P7 | 0.250 X 0.700 | 0.175 | |
| C1 | 0.990 X 0.470 | 0.465 | |
| C2 | 0.740 X 0.305 | 0.228 | |
| C3 | 0.700 X 0.250 | 0.175 | |
| C4 | 1.225 X 0.550 | 0.674 | |
| C5 | 0.300 X 0.250 | 0.075 | |
| C6 | 1.125 X 0.300 | 0.338 | |
| C7 | 1.275 X 0.900 | 1.148 | |
| C8 | 0.250 X 0.200 | 0.050 | |
| TOTAL (B) | | 4.939 | |
| TOTAL F.A.R AREA C = (A - B) | | 154.512 | |
| 1/4 F.A.R AREA OF BALCONY | | | |
| R1 | 0.855 X 1.825 | 1.560 | |
| R2 | 17.905 X 0.300 | 5.372 | |
| TOTAL AREA (D) | | 6.932 | |
| 1/4 BALCONY F.A.R AREA (E) | | 1.733 | |
| TOTAL UNIT F.A.R AREA F = (C + E) | | 156.245 | |
| NON F.A.R AREA OF BALCONY | | | |
| Y1 | 1.500 X 1.825 | 2.738 | |
| Y2 | 17.905 X 1.500 | 26.858 | |
| 3/4 AREA OF BALCONY (D - E) | | 5.199 | |
| TOTAL (G) | | 34.794 | |
| AREA SUBTRACTION | | | |
| C9 | 0.325 X 0.200 | 0.065 | |
| TOTAL AREA (H) | | 0.065 | |
| TOTAL BALCONY AREA J = (G - H) | | 34.729 | |
| 15% SERVICES AREA OF UNIT (PLUMBING SHAFT) | | | |
| P1 | 0.560 X 1.385 | 0.776 | |
| P2 | 0.740 X 0.350 | 0.259 | |
| P3 | 0.250 X 0.655 | 0.164 | |
| P4 | 0.525 X 0.250 | 0.131 | |
| P5 | 0.300 X 0.550 | 0.165 | |
| P6 | 0.400 X 0.300 | 0.120 | |
| P7 | 0.250 X 0.700 | 0.175 | |
| TOTAL 15% SERVICES AREA OF UNIT (K) | | 1.790 | |
| COVERAGE AREA FOR UNIT = (F + J + K) | | | 156.245 |
| TOTAL UNIT F.A.R AREA (F) | | | 156.245 |
| NON F.A.R AREA OF UNIT (J) | | | 34.729 |
| 15% SERVICES AREA OF UNIT (K) | | | 1.790 |
| TOTAL UNIT COVERAGE AREA | | | 192.763 |

F.A.R. COVERED AREA CALCULATION FOR CIRCULATION AREA

| S.NO. | PARTICULARS | AREA (SQM) |
|---------------------------------------|-------------------|------------|
| 1 | 7.090 X 1.205 | 8.533 |
| 2 | 0.350 X 1.750 | 1.225 |
| 3 | 5.230 X 8.140 | 42.572 |
| B1 | 1.350 X 0.240 X 2 | 0.648 |
| B2 | 0.300 X 4.675 | 1.403 |
| TOTAL AREA (A) | | 132.381 |
| AREA SUBTRACTION | | |
| FS1 | 5.230 X 6.190 | 32.374 |
| EL1 | 1.500 X 1.050 | 1.500 |
| EL2 | 2.300 X 1.240 | 2.852 |
| FH1 | 1.800 X 0.970 | 1.746 |
| LV1 | 0.640 X 0.900 | 0.576 |
| H2 | 2.700 X 0.260 | 0.702 |
| H3 | 1.650 X 2.850 | 4.719 |
| H4 | 0.650 X 0.970 | 0.622 |
| L2 | 2.330 X 2.300 X 2 | 10.718 |
| L3 | 2.300 X 2.300 | 5.290 |
| TOTAL (B) | | 72.888 |
| TOTAL F.A.R AREA CORRIDOR C = (A - B) | | 59.493 |

CORRIDOR AREA CALCULATION TOWARDS 15% ADDITIONAL F.A.R

| S.NO. | PARTICULARS | AREA (SQM) |
|---|-------------------|------------|
| FIRE TOWER AREA | | |
| FS1 | 5.230 X 6.190 | 32.374 |
| LIFT LOBBY | | |
| LL1 | 2.000 X 5.700 | 11.400 |
| ELECTRICAL SHAFT & LV SHAFT | | |
| EL1 | 1.500 X 1.050 | 1.500 |
| EL2 | 2.300 X 1.240 | 2.852 |
| F.H.C SHAFT | | |
| FH1 | 1.800 X 0.970 | 1.746 |
| PLUMBING SHAFT | | |
| LV1 | 0.640 X 0.900 | 0.576 |
| TOTAL CORRIDOR AREA CALCULATION TOWARDS 15% ADDITIONAL F.A.R (A) | | 50.538 |
| UNIT AREA CALCULATION TOWARDS 15% ADDITIONAL F.A.R | | |
| PLUMBING SHAFT | | |
| P1 | 0.560 X 1.385 X 2 | 1.551 |
| P2 | 0.740 X 0.350 X 2 | 0.518 |
| P3 | 0.250 X 0.655 X 2 | 0.328 |
| P4 | 0.525 X 0.250 X 2 | 0.263 |
| P5 | 0.300 X 0.550 X 2 | 0.330 |
| P6 | 0.400 X 0.300 X 2 | 0.240 |
| P7 | 0.250 X 0.700 X 2 | 0.350 |
| P8 | 1.335 X 0.300 X 2 | 0.801 |
| P9 | 0.400 X 0.800 X 2 | 0.640 |
| TOTAL UNIT AREA CALCULATION TOWARDS 15% ADDITIONAL F.A.R (B) | | 5.020 |
| TOTAL 15% ADDITIONAL F.A.R AREA (CORRIDOR AREA + UNIT AREA) = C (A+B) | | 55.558 |
| AREA SUBTRACTION | | |
| H1 | 2.230 X 0.450 | 1.035 |
| L1 | 3.000 X 2.300 | 6.900 |
| TOTAL AREA (D) | | 7.935 |
| TOTAL 15% ADDITIONAL F.A.R AREA E = (C - D) | | 47.555 |

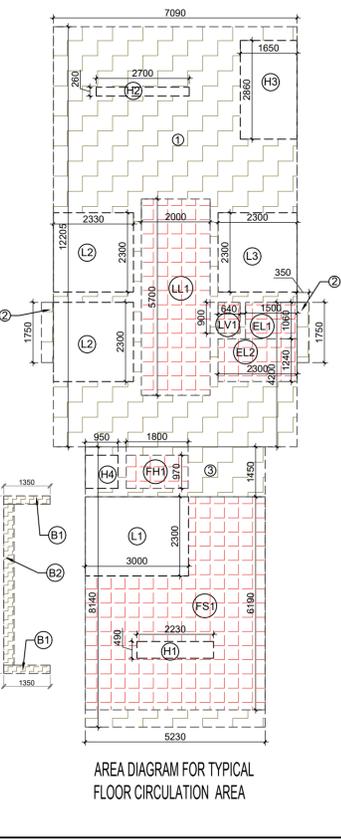

TOWN PLANNER SIGN

| NO. | DESCRIPTION |
|-----|-------------|
| 1 | ... |
| 2 | ... |
| 3 | ... |
| 4 | ... |
| 5 | ... |
| 6 | ... |
| 7 | ... |
| 8 | ... |
| 9 | ... |
| 10 | ... |
| 11 | ... |
| 12 | ... |
| 13 | ... |
| 14 | ... |
| 15 | ... |
| 16 | ... |
| 17 | ... |
| 18 | ... |
| 19 | ... |
| 20 | ... |
| 21 | ... |
| 22 | ... |
| 23 | ... |
| 24 | ... |
| 25 | ... |
| 26 | ... |
| 27 | ... |
| 28 | ... |
| 29 | ... |
| 30 | ... |
| 31 | ... |
| 32 | ... |
| 33 | ... |
| 34 | ... |
| 35 | ... |
| 36 | ... |
| 37 | ... |
| 38 | ... |
| 39 | ... |
| 40 | ... |
| 41 | ... |
| 42 | ... |
| 43 | ... |
| 44 | ... |
| 45 | ... |
| 46 | ... |
| 47 | ... |
| 48 | ... |
| 49 | ... |
| 50 | ... |

DOOR SCHEDULE

| S.NO. | NO. | DESCRIPTION | LOCATION |
|-------|-----|-------------|----------|
| 1 | ... | ... | ... |
| 2 | ... | ... | ... |
| 3 | ... | ... | ... |
| 4 | ... | ... | ... |
| 5 | ... | ... | ... |
| 6 | ... | ... | ... |
| 7 | ... | ... | ... |
| 8 | ... | ... | ... |
| 9 | ... | ... | ... |
| 10 | ... | ... | ... |
| 11 | ... | ... | ... |
| 12 | ... | ... | ... |
| 13 | ... | ... | ... |
| 14 | ... | ... | ... |
| 15 | ... | ... | ... |
| 16 | ... | ... | ... |
| 17 | ... | ... | ... |
| 18 | ... | ... | ... |
| 19 | ... | ... | ... |
| 20 | ... | ... | ... |
| 21 | ... | ... | ... |
| 22 | ... | ... | ... |
| 23 | ... | ... | ... |
| 24 | ... | ... | ... |
| 25 | ... | ... | ... |
| 26 | ... | ... | ... |
| 27 | ... | ... | ... |
| 28 | ... | ... | ... |
| 29 | ... | ... | ... |
| 30 | ... | ... | ... |
| 31 | ... | ... | ... |
| 32 | ... | ... | ... |
| 33 | ... | ... | ... |
| 34 | ... | ... | ... |
| 35 | ... | ... | ... |
| 36 | ... | ... | ... |
| 37 | ... | ... | ... |
| 38 | ... | ... | ... |
| 39 | ... | ... | ... |
| 40 | ... | ... | ... |
| 41 | ... | ... | ... |
| 42 | ... | ... | ... |
| 43 | ... | ... | ... |
| 44 | ... | ... | ... |
| 45 | ... | ... | ... |
| 46 | ... | ... | ... |
| 47 | ... | ... | ... |
| 48 | ... | ... | ... |
| 49 | ... | ... | ... |
| 50 | ... | ... | ... |


WINDOW SCHEDULE

| S.NO. | NO. | DESCRIPTION | LOCATION |
|-------|-----|-------------|----------|
| 1 | ... | ... | ... |
| 2 | ... | ... | ... |
| 3 | ... | ... | ... |
| 4 | ... | ... | ... |
| 5 | ... | ... | ... |
| 6 | ... | ... | ... |
| 7 | ... | ... | ... |
| 8 | ... | ... | ... |
| 9 | ... | ... | ... |
| 10 | ... | ... | ... |
| 11 | ... | ... | ... |
| 12 | ... | ... | ... |
| 13 | ... | ... | ... |
| 14 | ... | ... | ... |
| 15 | ... | ... | ... |
| 16 | ... | ... | ... |
| 17 | ... | ... | ... |
| 18 | ... | ... | ... |
| 19 | ... | ... | ... |
| 20 | ... | ... | ... |
| 21 | ... | ... | ... |
| 22 | ... | ... | ... |
| 23 | ... | ... | ... |
| 24 | ... | ... | ... |
| 25 | ... | ... | ... |
| 26 | ... | ... | ... |
| 27 | ... | ... | ... |
| 28 | ... | ... | ... |
| 29 | ... | ... | ... |
| 30 | ... | ... | ... |
| 31 | ... | ... | ... |
| 32 | ... | ... | ... |
| 33 | ... | ... | ... |
| 34 | ... | ... | ... |
| 35 | ... | ... | ... |
| 36 | ... | ... | ... |
| 37 | ... | ... | ... |
| 38 | ... | ... | ... |
| 39 | ... | ... | ... |
| 40 | ... | ... | ... |
| 41 | ... | ... | ... |
| 42 | ... | ... | ... |
| 43 | ... | ... | ... |
| 44 | ... | ... | ... |
| 45 | ... | ... | ... |
| 46 | ... | ... | ... |
| 47 | ... | ... | ... |
| 48 | ... | ... | ... |
| 49 | ... | ... | ... |
| 50 | ... | ... | ... |

OWNER GODREJ PROPERTIES LIMITED

SUBMISSION DRAWING

KEY PLAN

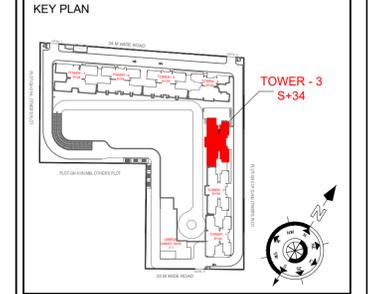

PROJECT PROPOSED GROUP HOUSING FOR PLOT NO :- GH-01/B,C,D,E,J & K SECTOR -12, GREATER NOIDA, G.B. NAGAR, (U.P.)

| | | |
|---------------------|----------------------------|---------------------------|
| DATE 08 - 01 - 2025 | PROJECT INCH. BALRAJ SINGH | CHECKED BY BALRAJ SINGH |
| SCALE 1:100 | DEALT BY ABDHESH JHA | APPROVED BY VISHAL SHARMA |

DRAWING TITLE 19TH & 29TH FLOOR PLAN (REFUGE LVL.)

TOWER-3


ARCHITECTS GOLDEN INDIA ARCHITECTS
 THE TEAM OF ARCHITECTS
 FF-37, KADAMBA SHOPPING COMPLEX
 GAMMA-IGREATER NOIDA
 CON...+91-94-1585-6777

DESIGN BY: Confluence
 NEW DELHI, INDIA

F-1, FIRST FLOOR, MIRA CORPORATE SUITES, ISHWAR NAGAR, NEW DELHI 110085

Ph: +91-11-26525684 ccc@confluence.com Member of IGBC
 Pn: +91-11-40564768 www.confluence.com 150 - 9001 - 2000
 architecture urban design hospitality interiors

DRAWING NO. S-28 REVISION

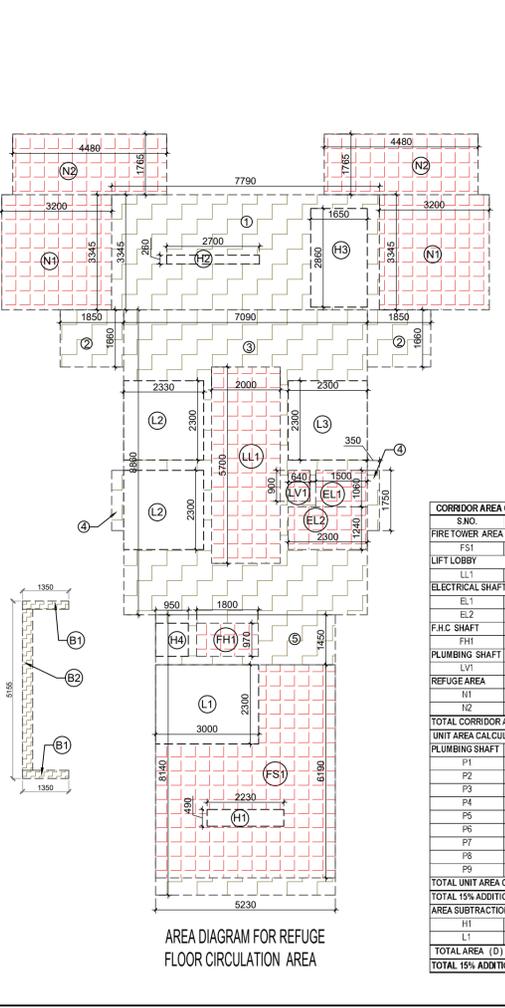

F.A.R. COVERED AREA CALCULATION FOR CIRCULATION AREA




| S.NO. | NO. | DESCRIPTION | AREA (SQMT) | | | | |
|--|-------|-------------|-------------|---|---------|---|--------|
| 1 | 7.790 | X | 3.345 | = | 26.058 | | |
| 2 | 1.850 | X | 1.660 | X | 2 | = | 6.142 |
| 3 | 7.080 | X | 8.860 | X | 2 | = | 62.817 |
| 4 | 0.950 | X | 1.750 | X | 2 | = | 3.325 |
| 5 | 5.250 | X | 6.140 | X | 2 | = | 42.572 |
| B1 | 1.350 | X | 0.340 | X | 2 | = | 0.918 |
| B2 | 0.300 | X | 4.675 | X | 2 | = | 1.403 |
| TOTAL AREA (A) | | | | = | 140.865 | | |
| AREA SUBTRACTION | | | | = | | | |
| FS1 | 5.230 | X | 6.190 | = | 32.374 | | |
| LL1 | 2.000 | X | 5.700 | = | 11.400 | | |
| EL1 | 1.500 | X | 1.090 | = | 1.590 | | |
| EL2 | 2.300 | X | 1.240 | = | 2.852 | | |
| F1H | 1.800 | X | 0.970 | = | 1.746 | | |
| L1 | 0.640 | X | 0.900 | = | 0.576 | | |
| H2 | 2.700 | X | 0.290 | = | 0.774 | | |
| H3 | 1.650 | X | 2.660 | = | 4.371 | | |
| H4 | 0.950 | X | 0.970 | = | 0.922 | | |
| L2 | 2.300 | X | 2.300 | X | 2 | = | 10.718 |
| L3 | 2.300 | X | 2.300 | = | 5.290 | | |
| TOTAL (B) | | | | = | 72.888 | | |
| TOTAL F.A.R. AREA CORRIDOR C = (A - B) | | | | = | 67.976 | | |

CORRIDOR AREA CALCULATION TOWARDS 15% ADDITIONAL F.A.R

| S.NO. | NO. | DESCRIPTION | AREA (SQMT) | | | | |
|---|-------|-------------|-------------|---|--------|---|--------|
| FS1 | 5.230 | X | 6.190 | = | 32.374 | | |
| LL1 | 2.000 | X | 5.700 | = | 11.400 | | |
| EL1 | 1.500 | X | 1.090 | = | 1.590 | | |
| EL2 | 2.300 | X | 1.240 | = | 2.852 | | |
| F1C | 1.800 | X | 0.970 | = | 1.746 | | |
| PL1 | 0.640 | X | 0.900 | = | 0.576 | | |
| N1 | 3.200 | X | 3.345 | X | 2 | = | 21.408 |
| N2 | 4.480 | X | 1.755 | X | 2 | = | 15.814 |
| TOTAL CORRIDOR AREA CALCULATION TOWARDS 15% ADDITIONAL F.A.R (A) | | | | = | 87.760 | | |
| UNIT AREA CALCULATION TOWARDS 15% ADDITIONAL F.A.R | | | | = | | | |
| P1 | 0.560 | X | 1.385 | X | 2 | = | 1.551 |
| P2 | 0.740 | X | 0.350 | X | 2 | = | 0.518 |
| P3 | 0.250 | X | 0.655 | X | 2 | = | 0.328 |
| P4 | 0.525 | X | 0.250 | X | 2 | = | 0.263 |
| P5 | 0.300 | X | 0.550 | X | 2 | = | 0.330 |
| P6 | 0.400 | X | 0.300 | X | 2 | = | 0.240 |
| P7 | 0.250 | X | 0.700 | X | 2 | = | 0.350 |
| P8 | 1.335 | X | 0.300 | X | 2 | = | 0.801 |
| P9 | 0.400 | X | 0.800 | X | 2 | = | 0.640 |
| TOTAL UNIT AREA CALCULATION TOWARDS 15% ADDITIONAL F.A.R (B) | | | | = | 5.020 | | |
| TOTAL 15% ADDITIONAL F.A.R AREA (CORRIDOR AREA+UNIT AREA) = (A+B) | | | | = | 92.780 | | |
| AREA SUBTRACTION | | | | = | | | |
| H1 | 2.230 | X | 0.490 | = | 1.093 | | |
| L1 | 3.000 | X | 2.300 | = | 6.900 | | |
| TOTAL AREA (D) | | | | = | 7.993 | | |
| TOTAL 15% ADDITIONAL F.A.R AREA E = (C - D) | | | | = | 84.788 | | |

TOTAL F.A.R. AREA AT 19TH & 29TH FLOOR PLAN (REFUGE LVL.)

| S.NO. | NO. | DESCRIPTION | AREA (SQMT) | | | | |
|---|--------|-------------|-------------|---|---------|---|-------|
| F.A.R. AREA OF UNIT - 1 | 2 | X | 156.245 | = | 312.490 | | |
| F.A.R. AREA OF UNIT - 3 | 2 | X | 89.681 | = | 179.363 | | |
| F.A.R. AREA OF CIRCULATION | 1 | X | 67.976 | = | 67.976 | | |
| F.A.R. AREA OF CONNECTING BEAM | | | 2.816 | = | 2.816 | | |
| TOTAL F.A.R. AREA | | | | = | 562.645 | | |
| TOTAL NON F.A.R. AREA AT 19TH & 29TH FLOOR PLAN (REFUGE LVL.) | | | | = | | | |
| UNIT - 1 | 34.729 | X | 2 | = | 69.458 | | |
| UNIT - 3 | 20.686 | X | 2 | = | 41.372 | | |
| TOTAL BALCONY AREA | | | | = | 110.829 | | |
| F.A.R. AREA AT CONNECTING BEAM (EVERY FLOOR) | | | | = | | | |
| S.NO. | NO. | DESCRIPTION | AREA (SQMT) | | | | |
| 1 | 0.400 | X | 3.520 | X | 2 | = | 2.816 |
| TOTAL F.A.R. AREA | | | | = | 2.816 | | |

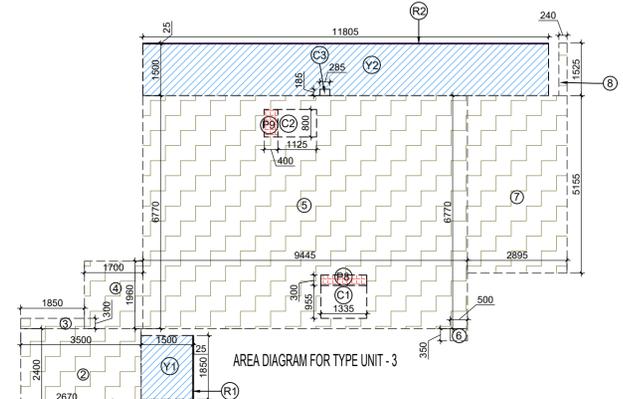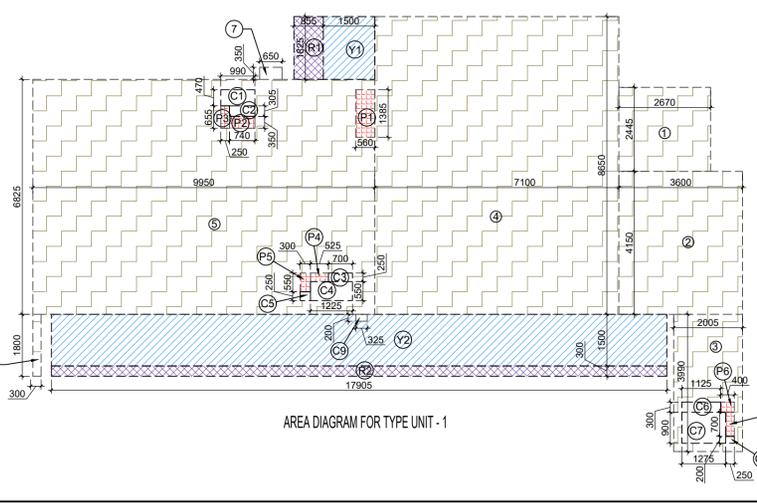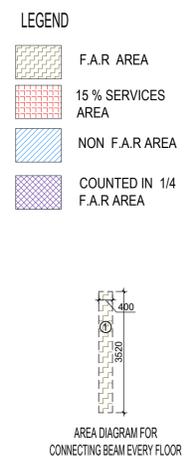

Digitally signed by LAL SINGH
 Date: 2025.01.27 17:35:11 +05'30'

Digitally signed by Sudheer Kumar
 Date: 2025.01.28 14:17:05 +05'30'

Digitally signed by Amit Varma
 Date: 2025.01.25 16:53:28 +05'30'

REFUGE AREA REQUIRED -
 -750.378 SQMTR (BLDG. PLATE) X 2 FLOORS X 0.3
 = 450.227 (12.5 - 0.3 SQM (for spec. abled))
 = 36.918 SQM. SAY - 37.00 SQMTR.
 REFUGE AREA PROPOSED = 37.222 SQMTR

F.A.R. COVERED AREA CALCULATION FOR TYPE UNIT - 3


| S.NO. | NO. | DESCRIPTION | AREA (SQMT) | | |
|------------------------------------|--------|-------------|-------------|---|--------|
| 1 | 2.670 | X | 0.300 | = | 0.801 |
| 2 | 3.500 | X | 2.400 | = | 8.400 |
| 3 | 1.850 | X | 0.300 | = | 0.555 |
| 4 | 1.700 | X | 1.900 | = | 3.230 |
| 5 | 9.445 | X | 6.770 | = | 63.943 |
| 6 | 0.500 | X | 0.350 | = | 0.175 |
| 7 | 2.855 | X | 1.525 | = | 4.354 |
| 8 | 0.240 | X | 1.525 | = | 0.366 |
| UNIT F.A.R. AREA = (A) | | | | = | 82.495 |
| AREA SUBTRACTION PLUMBING CUTOUT | | | | = | |
| P1 | 0.560 | X | 0.300 | = | 0.168 |
| P2 | 0.740 | X | 0.350 | = | 0.259 |
| P3 | 0.250 | X | 0.655 | = | 0.164 |
| P4 | 0.525 | X | 0.250 | = | 0.131 |
| P5 | 0.300 | X | 0.550 | = | 0.165 |
| P6 | 0.400 | X | 0.300 | = | 0.120 |
| P7 | 0.250 | X | 0.700 | = | 0.175 |
| C1 | 0.560 | X | 0.470 | = | 0.263 |
| C2 | 0.740 | X | 0.305 | = | 0.226 |
| C3 | 0.700 | X | 0.250 | = | 0.175 |
| C4 | 1.225 | X | 0.550 | = | 0.674 |
| C5 | 0.300 | X | 0.250 | = | 0.075 |
| C6 | 1.125 | X | 0.300 | = | 0.338 |
| C7 | 1.275 | X | 0.900 | = | 1.148 |
| C8 | 0.250 | X | 0.200 | = | 0.050 |
| TOTAL (B) | | | | = | 2.899 |
| TOTAL F.A.R. AREA C = (A - B) | | | | = | 89.596 |
| 1/4 F.A.R. AREA OF BALCONY | | | | = | |
| R1 | 0.025 | X | 1.850 | = | 0.046 |
| R2 | 11.805 | X | 0.025 | = | 0.295 |
| TOTAL AREA (D) | | | | = | 0.341 |
| 1/4 BALCONY F.A.R. AREA (E) | | | | = | 0.685 |
| TOTAL UNIT F.A.R. AREA F = (C + E) | | | | = | 90.281 |

NON F.A.R. AREA OF BALCONY

| S.NO. | NO. | DESCRIPTION | AREA (SQMT) | | |
|--|--------|-------------|-------------|---|---------|
| Y1 | 1.500 | X | 1.850 | = | 2.775 |
| Y2 | 11.805 | X | 1.500 | = | 17.708 |
| 3/4 AREA OF BALCONY (D - E) | | | | = | 0.256 |
| TOTAL (G) | | | | = | 20.739 |
| AREA SUBTRACTION | | | | = | |
| C3 | 0.285 | X | 0.185 | = | 0.053 |
| TOTAL AREA (H) | | | | = | 0.653 |
| TOTAL BALCONY AREA J = (G - H) | | | | = | 20.086 |
| 15% SERVICES AREA OF UNIT (PLUMBING SHAFT) | | | | = | |
| P8 | 1.335 | X | 0.300 | = | 0.401 |
| P9 | 0.400 | X | 0.800 | = | 0.320 |
| TOTAL 15% SERVICES AREA OF UNIT (K) | | | | = | 0.721 |
| COVERED AREA FOR UNIT = (F+J+K) | | | | = | 89.681 |
| TOTAL UNIT F.A.R. AREA (F) | | | | = | 89.681 |
| TOTAL NON F.A.R. AREA OF UNIT (J) | | | | = | 20.086 |
| TOTAL 15% SERVICES AREA OF UNIT (K) | | | | = | 0.721 |
| TOTAL UNIT COVERAGE AREA | | | | = | 110.488 |

F.A.R. COVERED AREA CALCULATION FOR TYPE UNIT - 1

| S.NO. | NO. | DESCRIPTION | AREA (SQMT) | | |
|-------|-------|-------------|-------------|---|--------|
| 1 | 2.670 | X | 2.445 | = | 6.528 |
| 2 | 3.600 | X | 4.150 | = | 14.940 |
| 3 | 2.005 | X | 3.990 | = | 8.000 |
| 4 | 7.100 | X | 8.650 | = | 61.415 |
| 5 | 9.950 | X | 8.825 | = | 67.909 |
| 6 | 0.240 | X | 1.800 | = | 0.432 |

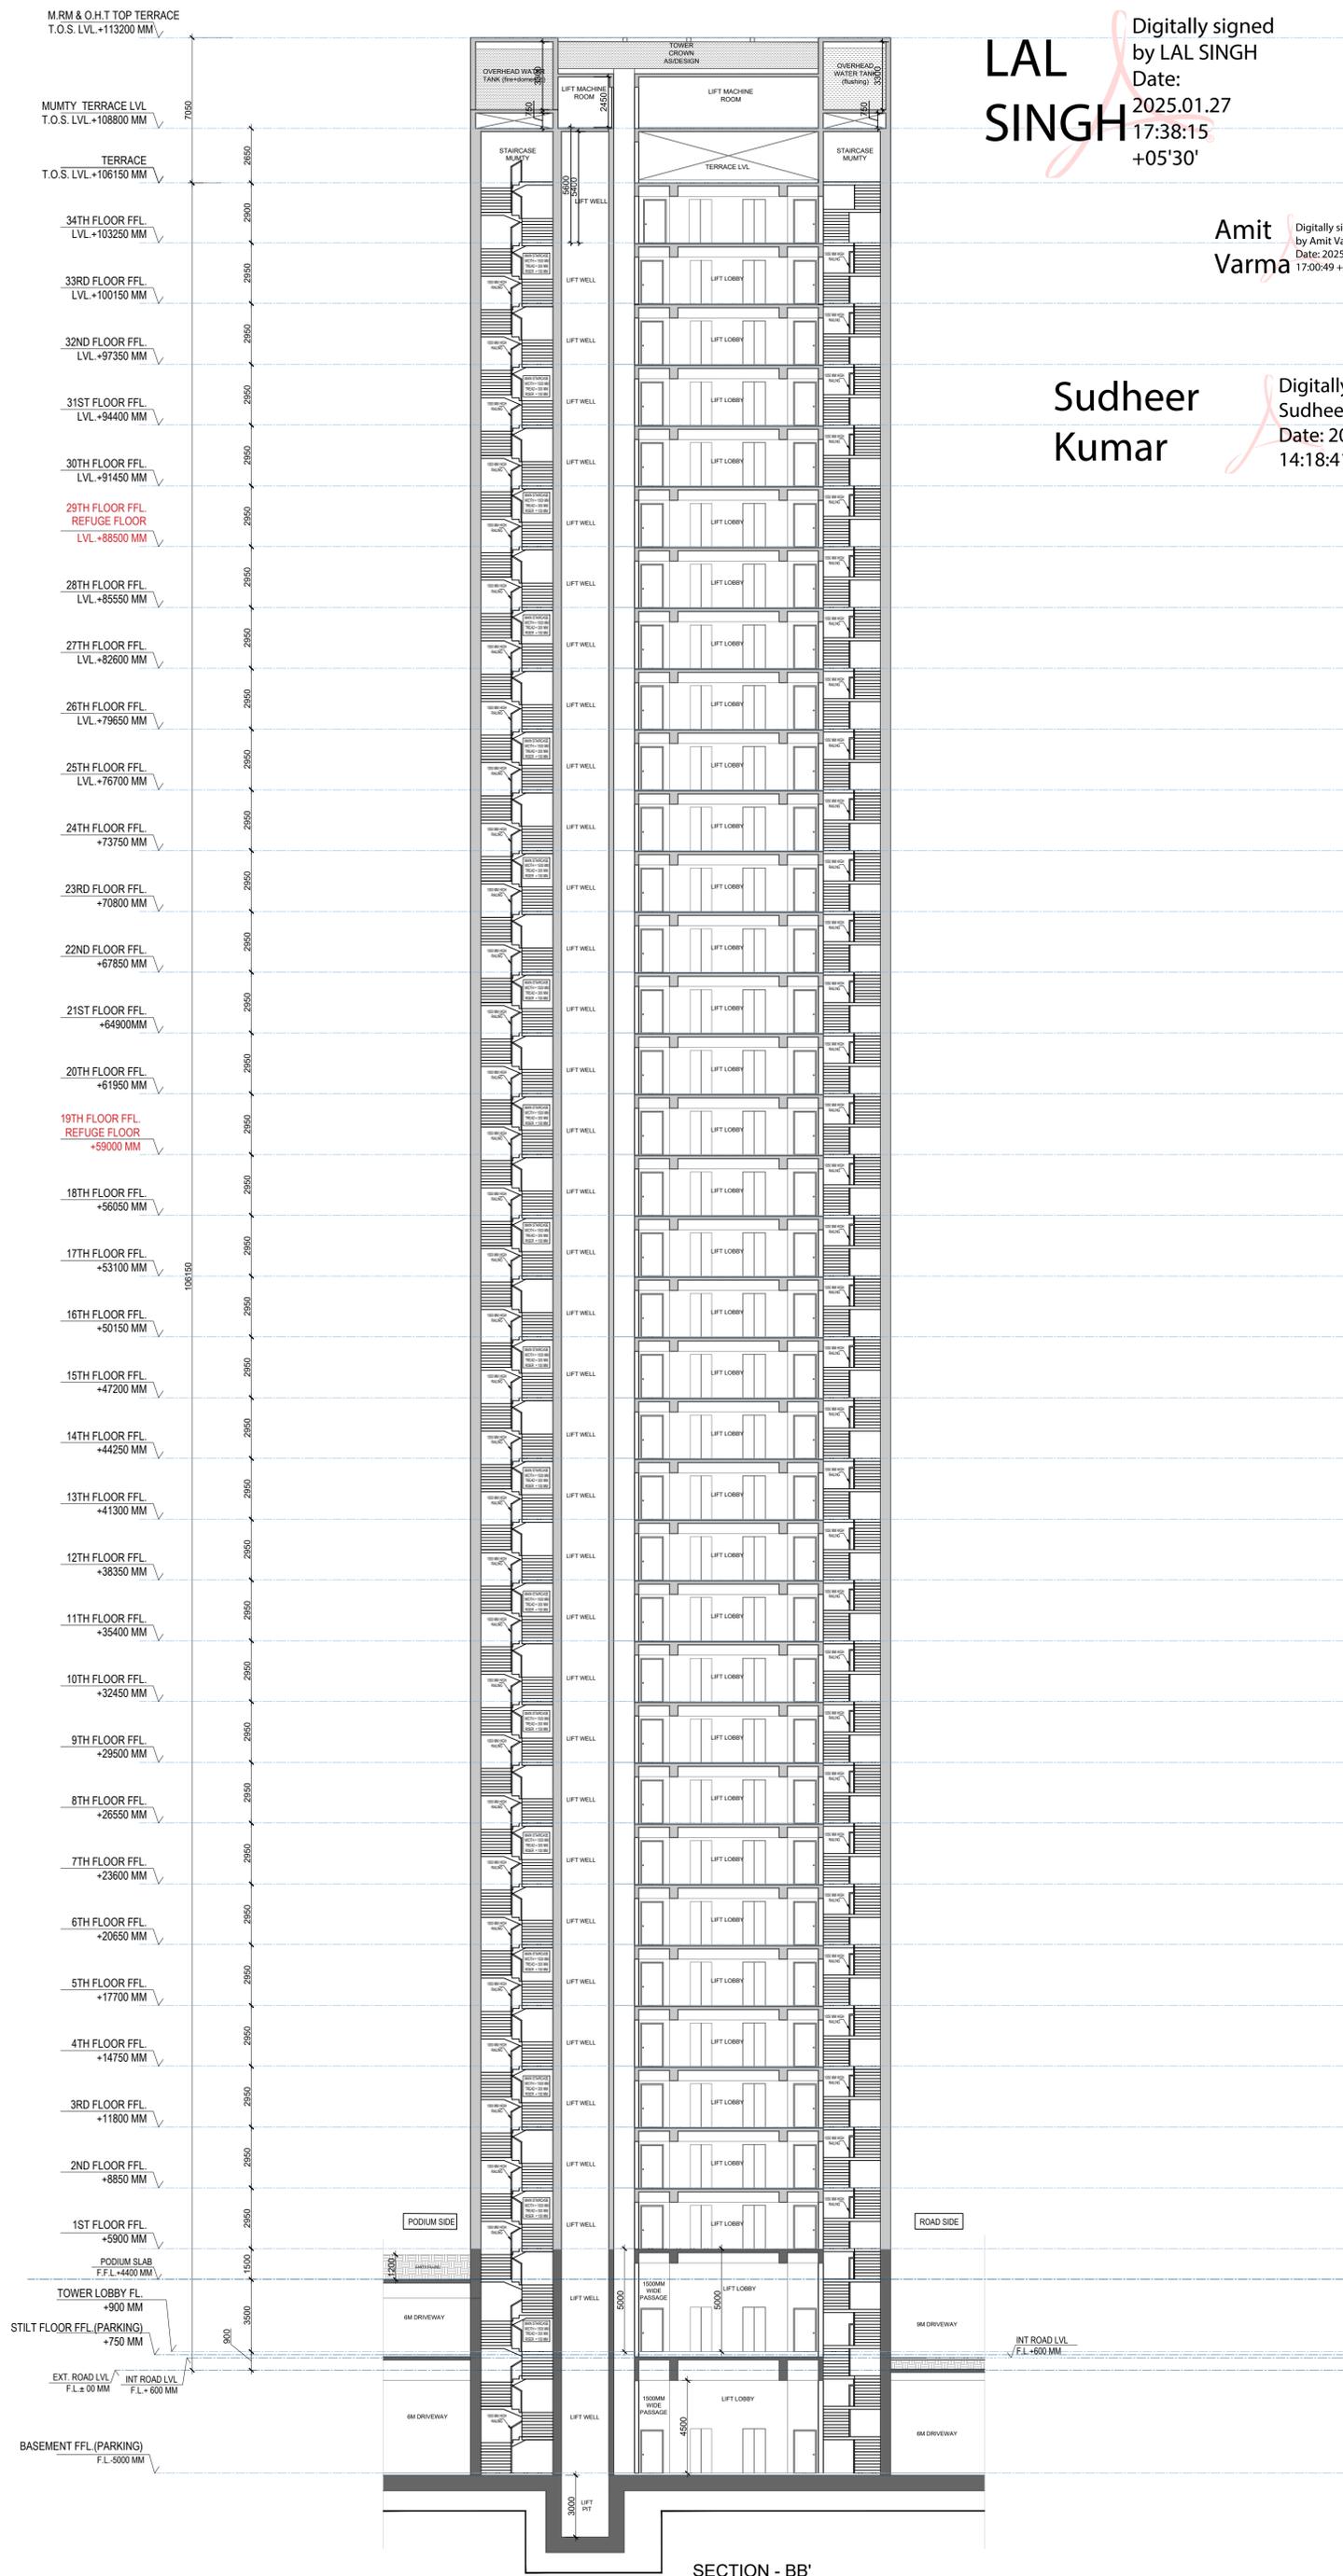

LAL SINGH Digitally signed by LAL SINGH
 Date: 2025.01.27 17:38:15 +05'30'

Amit Varma Digitally signed by Amit Varma
 Date: 2025.01.25 17:00:49 +05'30'

Sudheer Kumar Digitally signed by Sudheer Kumar
 Date: 2025.01.28 14:18:41 +05'30'


OWNER SIGN: **Rajat pathak** (2025.01.23 12:30:04 +05'30')

ARCHITECT SIGN: **AVANISH SRIVASTAV** (2025.01.23 12:29:54 +05'30')

TOWN PLANNER SIGN

OWNER: **GODREJ PROPERTIES LIMITED**

SUBMISSION DRAWING

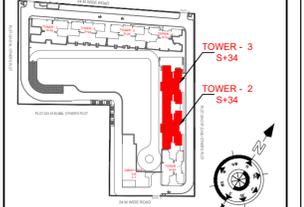

PROJECT: **PROPOSED GROUP HOUSING FOR PLOT NO. :- GH-01/B,C,D,E,J & K SECTOR -12, GREATER NOIDA, G.B. NAGAR, (U.P.)**

| | | |
|----------------------|----------------------------|---------------------------|
| DATE: 08 - 01 - 2025 | PROJECT INCH. BALRAJ SINGH | CHECKED BY BALRAJ SINGH |
| SCALE: 1:100 | DEALT BY ABDHESH JHA | APPROVED BY VISHAL SHARMA |


DRAWING TITLE: **SECTION - B-B'**

TOWER - 2 & 3


ARCHITECTS: **GOLDEN INDIA ARCHITECTS**
 THE TEAM OF ARCHITECTS
 FF-37, KADAMBA SHOPPING COMPLEX
 GAMMA-IGREATER NOIDA
 CON... + 91-94-1585-6777

DESIGN BY: **Confluence**
 NEW DELHI, INDIA
 F-1, FIRST FLOOR, MIRA CORPORATE SUITES,
 ISHWAR NAGAR, NEW DELHI 110055

DRAWING NO. S-33 REVISION

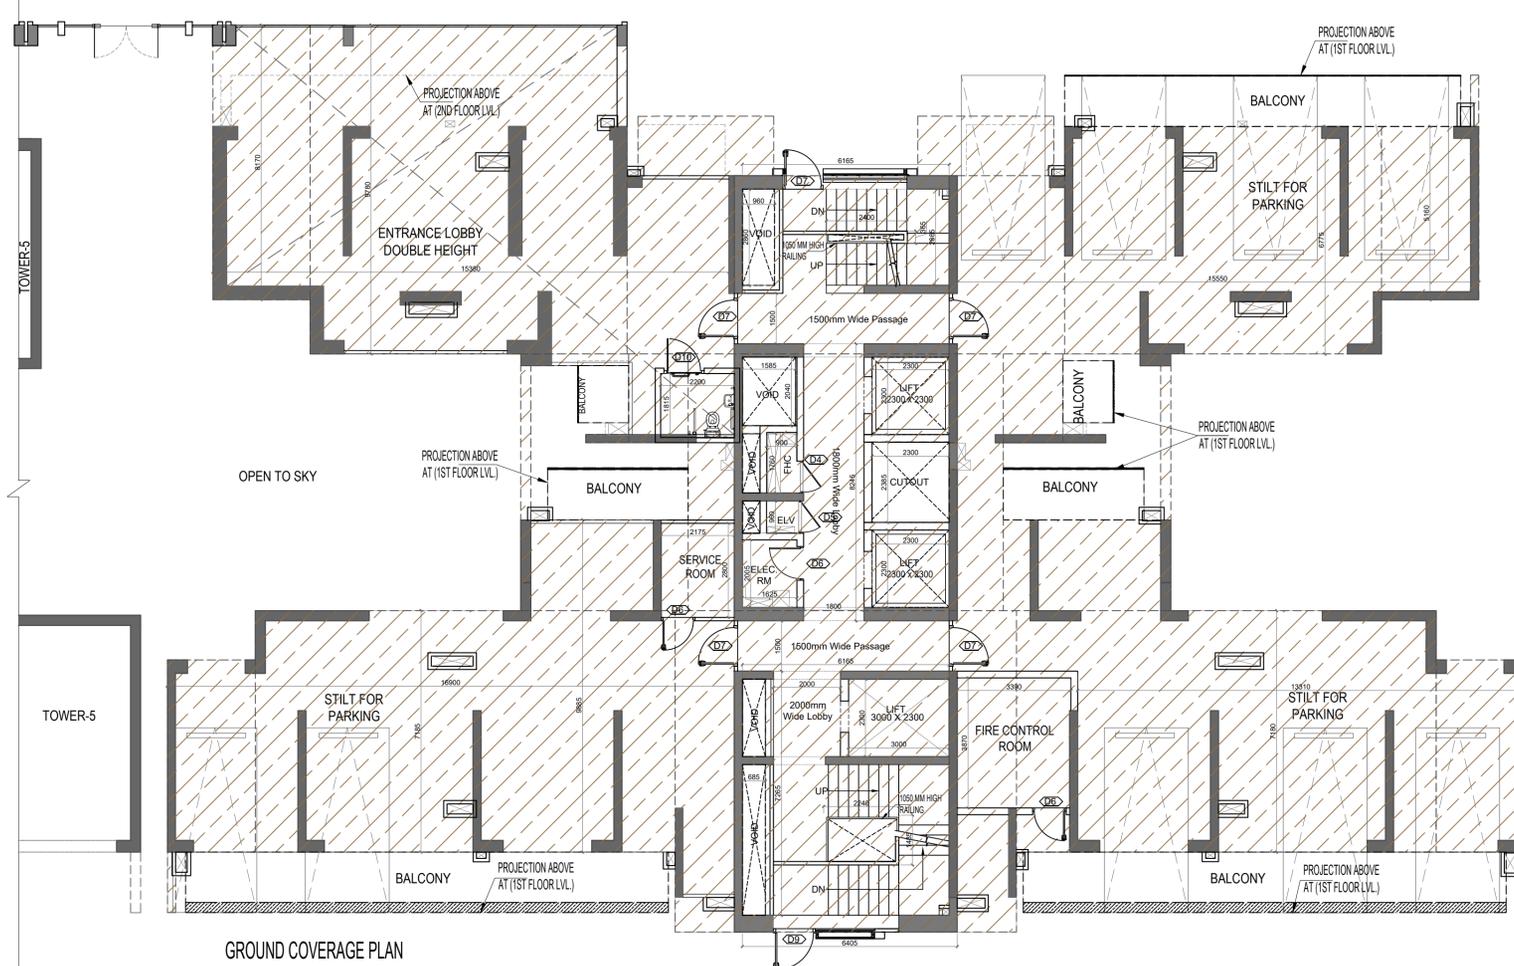

GROUND COVERAGE PLAN

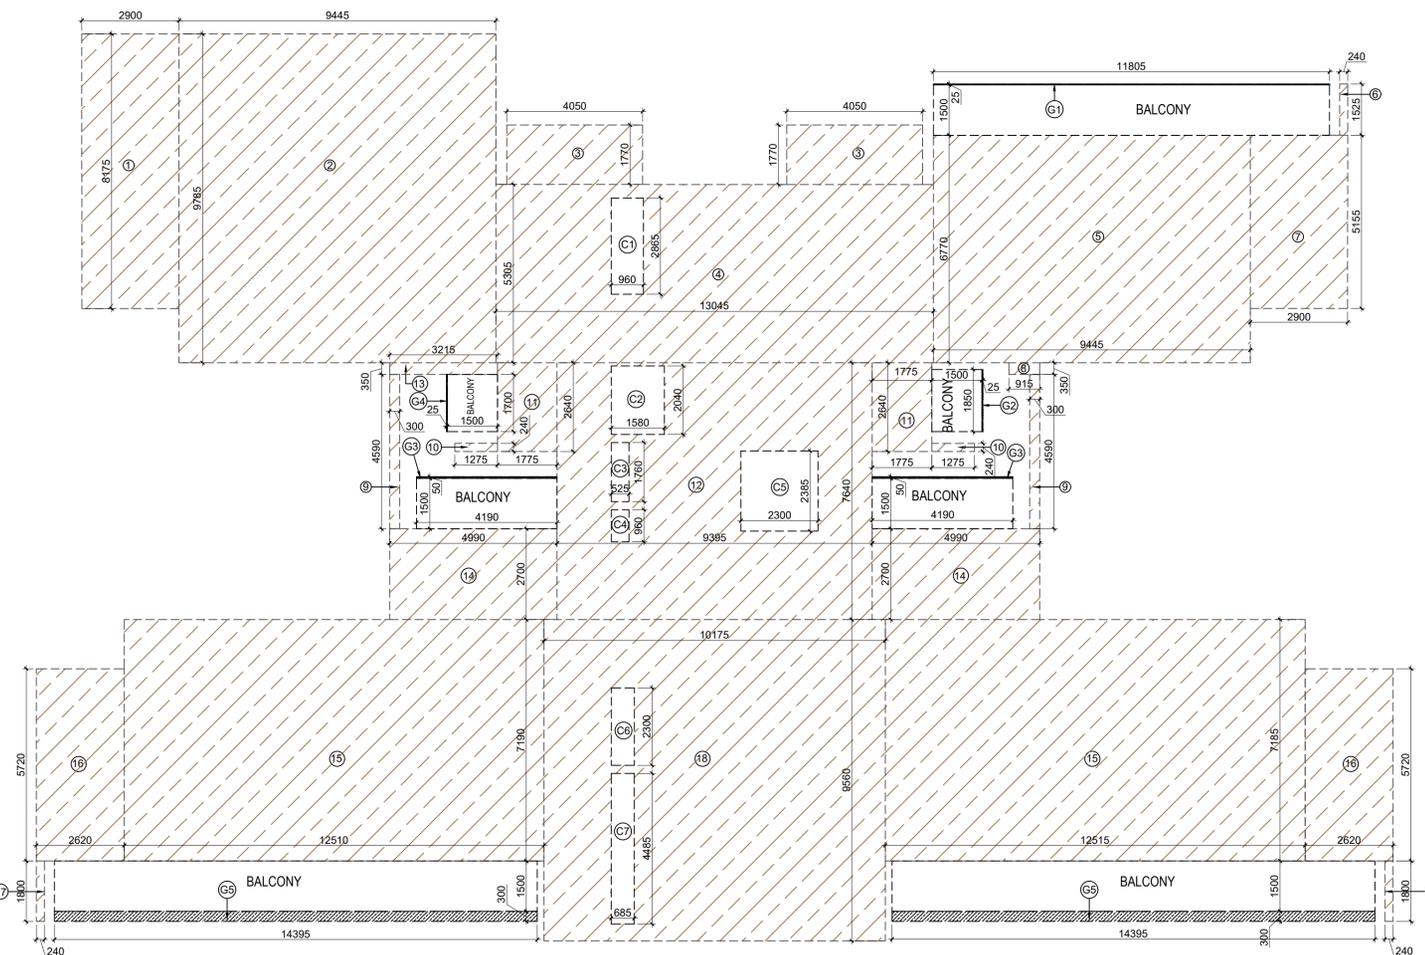

AREA DIAGRAM FOR GROUND COVERAGE

Amit Varma
Digitally signed by Amit Varma
Date: 2025.01.25
17:01:01 +05'30'

LAL SINGH
Digitally signed by LAL SINGH
Date: 2025.01.27
17:38:32
+05'30'

Sudheer Kumar
Digitally signed by Sudheer Kumar
Date: 2025.01.28
14:19:14 +05'30'

AREA CALCULATION FOR GROUND COVERAGE

| S.NO. | PARTICULARS | | | | | AREA (SQMT) |
|-----------------------|-------------|---|-------|---|---|------------------|
| 1 | 2.900 | X | 8.175 | | | = 23.708 |
| 2 | 9.445 | X | 9.785 | | | = 92.419 |
| 3 | 4.050 | X | 1.770 | X | 2 | = 14.337 |
| 4 | 13.045 | X | 5.305 | | | = 69.204 |
| 5 | 9.445 | X | 6.770 | | | = 63.943 |
| 6 | 0.240 | X | 1.525 | | | = 0.366 |
| 7 | 2.900 | X | 5.155 | | | = 14.950 |
| 8 | 0.915 | X | 0.350 | | | = 0.320 |
| 9 | 0.300 | X | 4.590 | X | 2 | = 2.754 |
| 10 | 1.275 | X | 0.240 | X | 2 | = 0.612 |
| 11 | 1.775 | X | 2.640 | X | 2 | = 9.372 |
| 12 | 9.395 | X | 7.640 | | | = 71.778 |
| 13 | 3.215 | X | 0.350 | | | = 1.125 |
| 14 | 4.990 | X | 2.700 | X | 2 | = 26.946 |
| 15 | 12.510 | X | 7.190 | X | 2 | = 179.894 |
| 16 | 2.620 | X | 5.720 | X | 2 | = 29.973 |
| 17 | 0.240 | X | 1.800 | X | 2 | = 0.864 |
| 18 | 10.175 | X | 9.560 | | | = 97.273 |
| TOTAL AREA (A) | | | | | | = 699.837 |

| AREA SUBTRACTION | | | | | | |
|-----------------------------|-------|---|-------|--|--|------------------|
| C1 | 0.960 | X | 2.865 | | | = 2.750 |
| C2 | 1.585 | X | 2.040 | | | = 3.233 |
| C3 | 0.525 | X | 1.760 | | | = 0.924 |
| C4 | 0.525 | X | 0.960 | | | = 0.504 |
| C5 | 2.300 | X | 2.385 | | | = 5.486 |
| C6 | 0.685 | X | 2.300 | | | = 1.576 |
| C7 | 0.685 | X | 4.485 | | | = 3.072 |
| TOTAL AREA (B) | | | | | | = 17.545 |
| TOTAL AREA = C (A-B) | | | | | | = 682.292 |

| 1/4 F.A.R AREA OF BALCONY FOR GROUND COVERAGE | | | | | | |
|---|--------|---|-------|---|---|------------------|
| G1 | 18.805 | X | 0.025 | | | = 0.470 |
| G2 | 0.025 | X | 1.850 | | | = 0.046 |
| G3 | 4.190 | X | 0.050 | X | 2 | = 0.419 |
| G4 | 0.025 | X | 1.700 | | | = 0.043 |
| G5 | 14.395 | X | 0.300 | X | 2 | = 8.637 |
| TOTAL AREA (D) | | | | | | = 9.615 |
| 1/4 BALCONY F.A.R AREA (E) | | | | | | = 2.404 |
| TOTAL GROUND COVERAGE AREA F = (C+E) | | | | | | = 684.695 |

LEGEND
 AREA FOR GROUND COVERAGE USE ONLY

OWNER SIGN: Rajat pathak, 2025.01.2, 3:12:30:19, +05'30'

ARCHITECT SIGN: AVANISH SRIVASTAV, 2025.01.23, 12:30:32, +05'30'

TOWN PLANNER SIGN: Sudheer Kumar, 2025.01.28, 14:19:14 +05'30'

OWNER: GODREJ PROPERTIES LIMITED

SUBMISSION DRAWING

KEY PLAN: TOWER - 4 S+23

PROJECT: PROPOSED GROUP HOUSING FOR PLOT NO :- GH-01/B,C,D,E,J & K SECTOR -12, GREATER NOIDA, G.B. NAGAR, (U.P.)

| | | |
|------------------|----------------------------|----------------------------|
| DATE: 08-01-2025 | PROJECT INCH: BALRAJ SINGH | CHECKED BY: BALRAJ SINGH |
| SCALE: 1:100 | DEALT BY: ABDHESH JHA | APPROVED BY: VISHAL SHARMA |

DRAWING TITLE: GROUND COVERAGE PLAN


TOWER-4

ARCHITECTS: GOLDEN INDIA ARCHITECTS
 THE TEAM OF ARCHITECTS
 FF-37, KADAMBA SHOPPING COMPLEX
 GAMMA-IGREATER NOIDA
 CON. +91-94-1585-6777

DESIGN BY: Confluence
 NEW DELHI, INDIA
 F-1, FIRST FLOOR, MIRA CORPORATE SUITES,
 ISHWAR NAGAR, NEW DELHI 110065

Ph: +91-11-28925684 ccs@inconflience.com Member of IGBC
 Ph: +91-11-40564768 www.inconflience.com ISO - 9001:2000
 architecture urban design hospitality interiors

DRAWING NO. S-34 REVISION

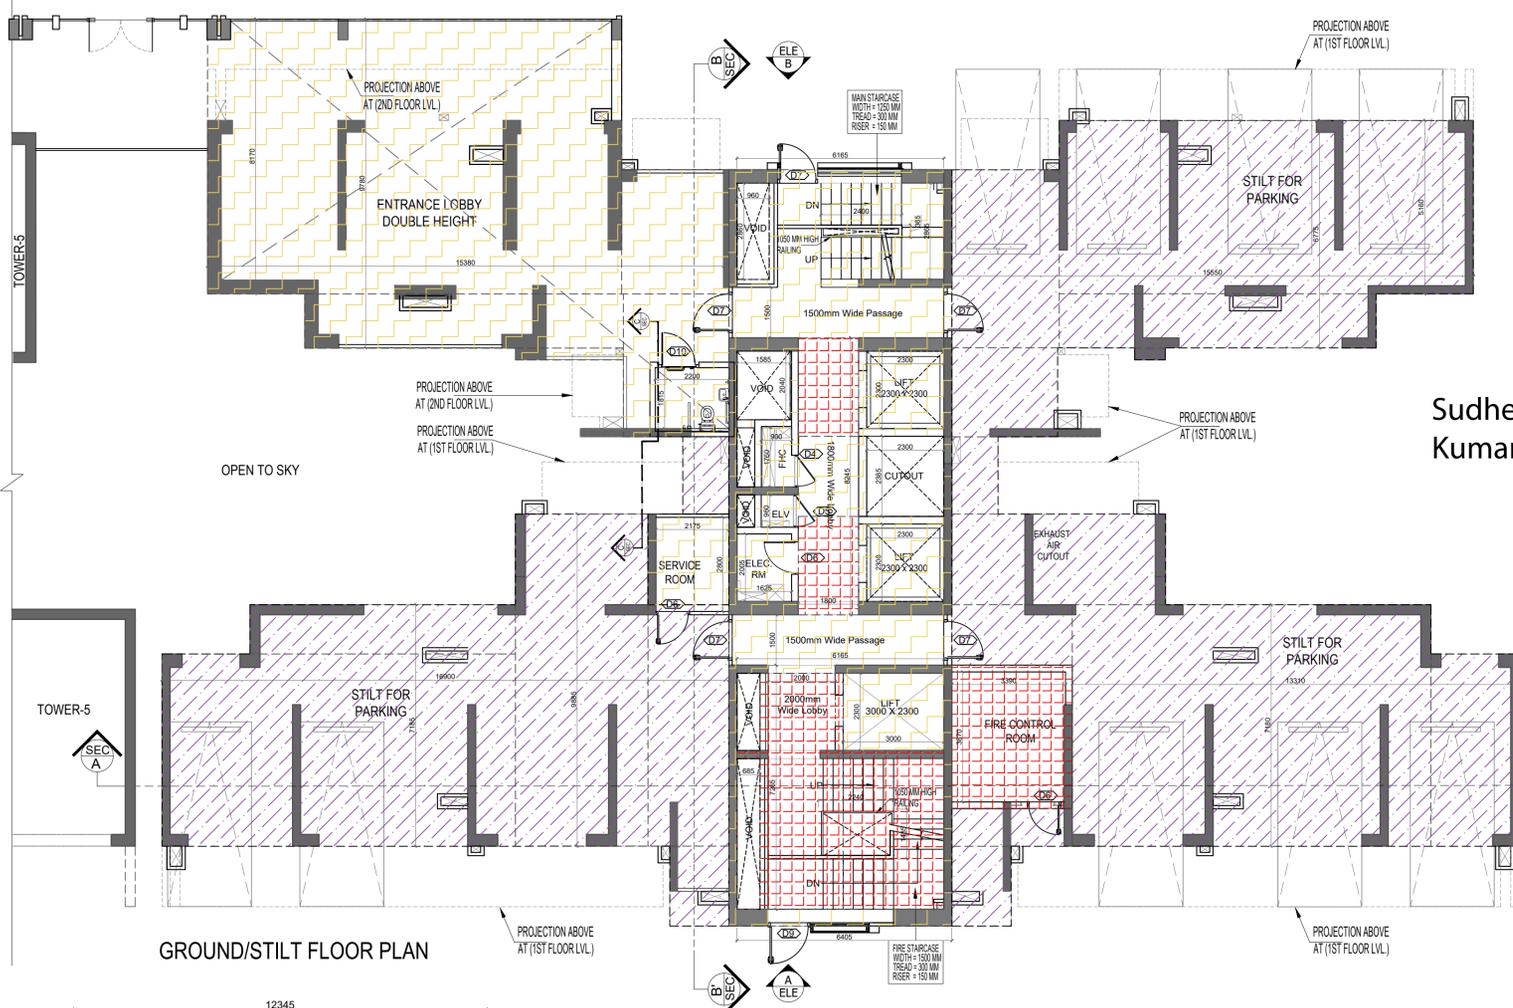


Amit Varma
Digitally signed by Amit Varma
Date: 2025.01.25
17:01:19 +05'30'

LAL SINGH
Digitally signed by LAL SINGH
Date: 2025.01.27
17:38:49 +05'30'

Sudheer Kumar
Digitally signed by Sudheer Kumar
Date: 2025.01.28
14:19:36 +05'30'

GROUND/STILT FLOOR PLAN

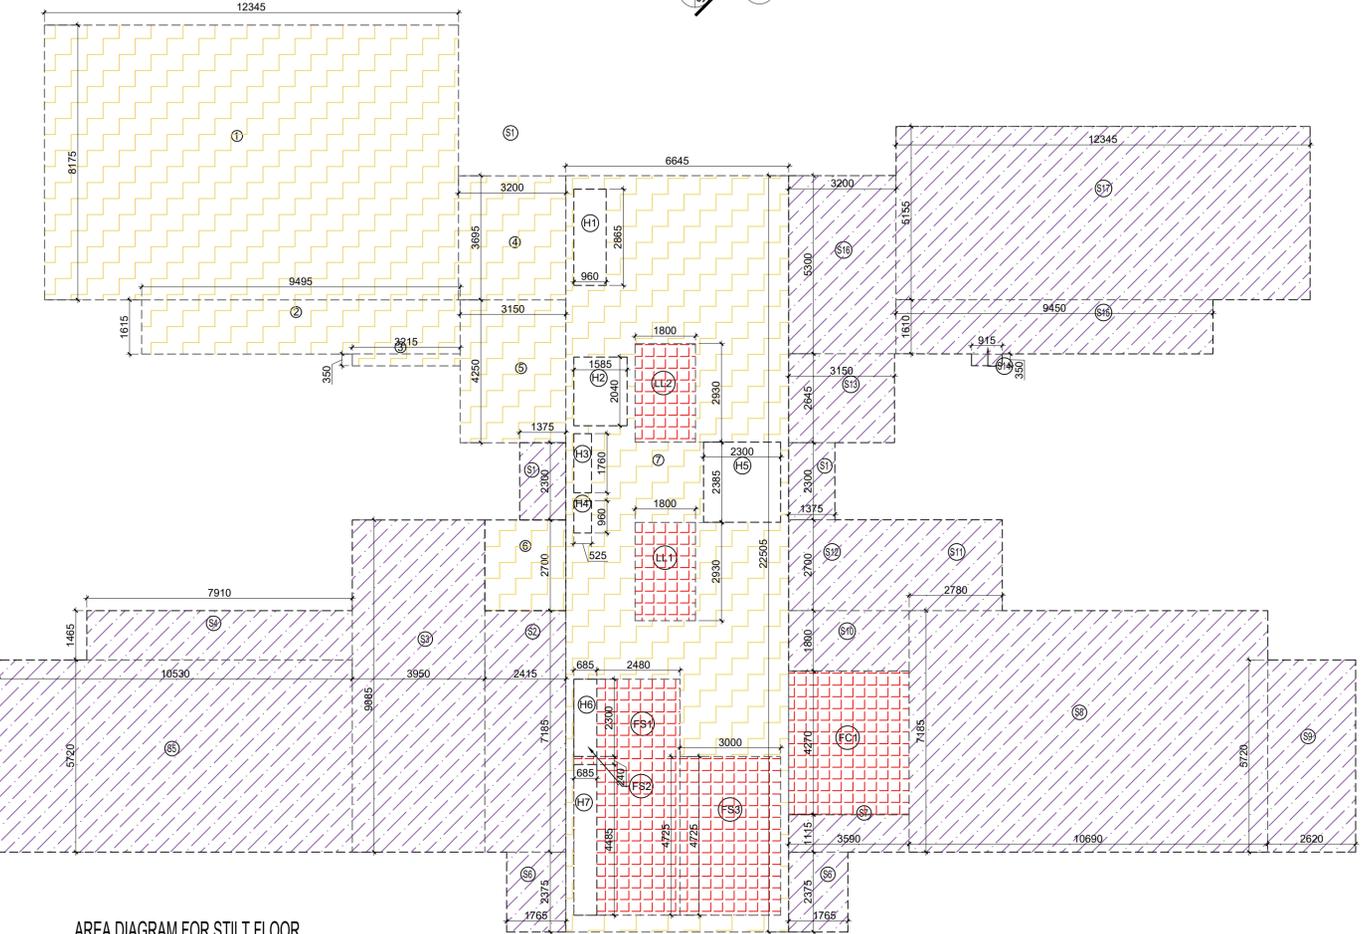

AREA DIAGRAM FOR STILT FLOOR CIRCULATION & ENTRANCE LOBBY

| S.NO. | AREA (SQMT) | | | | | AREA (SQMT) |
|-----------------------------|-------------|---|--------|--|---|----------------|
| 1 | 12.345 | X | 8.175 | | = | 100.920 |
| 2 | 9.495 | X | 1.615 | | = | 15.334 |
| 3 | 3.215 | X | 0.350 | | = | 1.125 |
| 4 | 3.200 | X | 3.695 | | = | 11.824 |
| 5 | 3.150 | X | 4.250 | | = | 13.388 |
| 6 | 2.415 | X | 2.700 | | = | 6.521 |
| 7 | 6.645 | X | 22.505 | | = | 149.546 |
| TOTAL F.A.R AREA (A) | | | | | | 298.658 |

| S.NO. | AREA (SQMT) | | | | | AREA (SQMT) |
|--|-------------|---|-------|--|---|----------------|
| FS1 | 3.165 | X | 7.025 | | = | 22.234 |
| FS2 | 3.000 | X | 4.725 | | = | 14.175 |
| LL1 | 1.800 | X | 2.930 | | = | 5.274 |
| LL2 | 1.800 | X | 2.930 | | = | 5.274 |
| H1 | 0.960 | X | 2.885 | | = | 2.750 |
| H2 | 1.585 | X | 2.040 | | = | 3.233 |
| H3 | 0.525 | X | 1.760 | | = | 0.924 |
| H4 | 0.525 | X | 0.960 | | = | 0.504 |
| H5 | 2.300 | X | 2.385 | | = | 5.486 |
| TOTAL (B) | | | | | | 59.854 |
| TOTAL F.A.R AREA CORRIDOR C = (A - B) | | | | | | 238.803 |

| S.NO. | AREA (SQMT) | | | | | AREA (SQMT) |
|---|-------------|---|-------|--|---|---------------|
| FS1 | 2.480 | X | 7.025 | | = | 17.422 |
| FS2 | 0.685 | X | 0.240 | | = | 0.164 |
| FS3 | 3.000 | X | 4.725 | | = | 14.175 |
| FC1 | 3.590 | X | 4.270 | | = | 15.329 |
| LIFT LOBBY | | | | | | |
| LL1 | 1.800 | X | 2.930 | | = | 5.274 |
| LL2 | 1.800 | X | 2.930 | | = | 5.274 |
| TOTAL CORRIDOR AREA CALCULATION TOWARDS 15% ADDITIONAL F.A.R | | | | | | 57.639 |

| S.NO. | AREA (SQMT) | | | | | AREA (SQMT) | |
|---|-------------|---|-------|---|---|----------------|--------|
| S1 | 1.375 | X | 2.300 | X | 2 | = | 6.325 |
| S2 | 2.415 | X | 7.185 | | | = | 17.352 |
| S3 | 3.950 | X | 9.885 | | | = | 39.046 |
| S4 | 7.910 | X | 1.465 | | | = | 11.588 |
| S5 | 10.530 | X | 5.720 | | | = | 60.232 |
| S6 | 1.765 | X | 2.375 | X | 2 | = | 8.384 |
| S7 | 3.590 | X | 1.115 | | | = | 4.003 |
| S8 | 10.690 | X | 7.185 | | | = | 76.808 |
| S9 | 2.620 | X | 5.720 | | | = | 14.986 |
| S10 | 3.590 | X | 1.800 | | | = | 6.462 |
| S11 | 6.365 | X | 2.700 | | | = | 17.186 |
| S12 | 3.150 | X | 2.645 | | | = | 8.332 |
| S13 | 0.915 | X | 0.350 | | | = | 0.320 |
| S14 | 9.450 | X | 1.610 | | | = | 15.215 |
| S15 | 3.200 | X | 5.300 | | | = | 16.960 |
| S16 | 12.345 | X | 5.155 | | | = | 63.638 |
| TOTAL GROUND FLOOR / STILT NON F.A.R. AREA (A) | | | | | | 366.835 | |

| S.NO. | PARTICULARS | AREA (SQMT) |
|--|-------------|----------------|
| F.A.R AREA OF CIRCULATION & ENTRANCE LOBBY | 1 | 238.803 |
| TOTAL F.A.R AREA | X | 238.803 |

| | GROUND COVERAGE | F.A.R. AREA | 15% AREA | STILT NON F.A.R. AREA (PARKING) | NON F.A.R. AREA (BALCONY) |
|--------------------------------|-----------------|------------------|-----------------|---------------------------------|---------------------------|
| GROUND / STILT. FLOOR (F.A.R.) | 684.695 | 238.803 | 57.639 | 366.835 | |
| 1ST / PODIUM FLOOR AREA | | 443.458 | 47.196 | | 55.961 |
| 2nd FLOOR AREA | | 549.228 | 49.375 | | 111.922 |
| 3rd FLOOR AREA | | 549.228 | 49.375 | | 111.922 |
| 4th FLOOR AREA | | 549.228 | 49.375 | | 111.922 |
| 5th FLOOR AREA | | 549.228 | 49.375 | | 111.922 |
| 6th FLOOR AREA | | 549.228 | 49.375 | | 111.922 |
| 7th FLOOR AREA | | 549.228 | 49.375 | | 111.922 |
| 8th FLOOR AREA | | 549.228 | 49.375 | | 111.922 |
| 9th FLOOR AREA | | 549.228 | 49.375 | | 111.922 |
| 10th FLOOR AREA | | 549.228 | 49.375 | | 111.922 |
| 11th FLOOR AREA | | 549.228 | 49.375 | | 111.922 |
| 12th FLOOR AREA | | 549.228 | 49.375 | | 111.922 |
| 12th (A) FLOOR AREA | | 549.228 | 49.375 | | 111.922 |
| 14th FLOOR AREA | | 549.228 | 49.375 | | 111.922 |
| 15th FLOOR AREA | | 549.228 | 49.375 | | 111.922 |
| 16th FLOOR AREA | | 549.228 | 49.375 | | 111.922 |
| 17th FLOOR AREA | | 549.228 | 49.375 | | 111.922 |
| 18th FLOOR AREA | | 549.228 | 49.375 | | 111.922 |
| 19th FLOOR AREA (REFUGE FLOOR) | | 527.435 | 85.440 | | 104.030 |
| 20th FLOOR AREA | | 549.228 | 49.375 | | 111.922 |
| 21st FLOOR AREA | | 549.228 | 49.375 | | 111.922 |
| 22nd FLOOR AREA | | 549.228 | 49.375 | | 111.922 |
| 23rd FLOOR AREA | | 549.228 | 49.375 | | 111.922 |
| TERRACE FLOOR | | 19.374 | 110.318 | | |
| MACHINE ROOM TOS LVL. | | | 70.631 | | |
| OHT | | | 52.122 | | |
| TOTAL | 684.695 | 12762.850 | 1460.217 | 366.835 | 2510.343 |

OWNER SIGN: **Rajat pathak**
2025.01.2
3 12:30:57
+05'30'


ARCHITECT SIGN: **AVANISH SRIVASTAV**
2025.01.23
12:30:47
+05'30'

| S.NO. | TYPE | OPENING | HEIGHT | WELL | LEVEL | LOCATION | DESCRIPTION |
|-------|------|---------|--------|------|-------|----------|-----------------------|
| 1 | DOOR | 2100 | 2100 | 2100 | 2100 | LIVING | UPVC FRAME GLASS DOOR |
| 2 | DOOR | 2100 | 2100 | 2100 | 2100 | LIVING | UPVC FRAME GLASS DOOR |
| 3 | DOOR | 2100 | 2100 | 2100 | 2100 | LIVING | UPVC FRAME GLASS DOOR |
| 4 | DOOR | 2100 | 2100 | 2100 | 2100 | LIVING | UPVC FRAME GLASS DOOR |
| 5 | DOOR | 2100 | 2100 | 2100 | 2100 | LIVING | UPVC FRAME GLASS DOOR |
| 6 | DOOR | 2100 | 2100 | 2100 | 2100 | LIVING | UPVC FRAME GLASS DOOR |
| 7 | DOOR | 2100 | 2100 | 2100 | 2100 | LIVING | UPVC FRAME GLASS DOOR |
| 8 | DOOR | 2100 | 2100 | 2100 | 2100 | LIVING | UPVC FRAME GLASS DOOR |
| 9 | DOOR | 2100 | 2100 | 2100 | 2100 | LIVING | UPVC FRAME GLASS DOOR |
| 10 | DOOR | 2100 | 2100 | 2100 | 2100 | LIVING | UPVC FRAME GLASS DOOR |
| 11 | DOOR | 2100 | 2100 | 2100 | 2100 | LIVING | UPVC FRAME GLASS DOOR |
| 12 | DOOR | 2100 | 2100 | 2100 | 2100 | LIVING | UPVC FRAME GLASS DOOR |
| 13 | DOOR | 2100 | 2100 | 2100 | 2100 | LIVING | UPVC FRAME GLASS DOOR |
| 14 | DOOR | 2100 | 2100 | 2100 | 2100 | LIVING | UPVC FRAME GLASS DOOR |
| 15 | DOOR | 2100 | 2100 | 2100 | 2100 | LIVING | UPVC FRAME GLASS DOOR |
| 16 | DOOR | 2100 | 2100 | 2100 | 2100 | LIVING | UPVC FRAME GLASS DOOR |
| 17 | DOOR | 2100 | 2100 | 2100 | 2100 | LIVING | UPVC FRAME GLASS DOOR |
| 18 | DOOR | 2100 | 2100 | 2100 | 2100 | LIVING | UPVC FRAME GLASS DOOR |
| 19 | DOOR | 2100 | 2100 | 2100 | 2100 | LIVING | UPVC FRAME GLASS DOOR |
| 20 | DOOR | 2100 | 2100 | 2100 | 2100 | LIVING | UPVC FRAME GLASS DOOR |

| S.NO. | TYPE | OPENING | HEIGHT | WELL | LEVEL | LOCATION | DESCRIPTION |
|-------|------|---------|--------|------|-------|----------|-------------------------------------|
| 1 | WT | 400 | 2100 | 100 | 2100 | TOILET | SPECIAL ALUMINUM FRAME GLASS WINDOW |
| 2 | WT | 400 | 1100 | 1000 | 2100 | DINING | SPECIAL ALUMINUM FRAME GLASS WINDOW |
| 3 | WT | 400 | 1100 | 1000 | 2100 | DINING | SPECIAL ALUMINUM FRAME GLASS WINDOW |
| 4 | WT | 400 | 1100 | 1000 | 2100 | DINING | SPECIAL ALUMINUM FRAME GLASS WINDOW |
| 5 | WT | 1000 | 1100 | 1000 | 2100 | LIVING | SPECIAL ALUMINUM FRAME GLASS WINDOW |
| 6 | WT | 1000 | 1100 | 1000 | 2100 | LIVING | SPECIAL ALUMINUM FRAME GLASS WINDOW |
| 7 | WT | 1000 | 1100 | 1000 | 2100 | LIVING | SPECIAL ALUMINUM FRAME GLASS WINDOW |
| 8 | WT | 1000 | 1100 | 1000 | 2100 | LIVING | SPECIAL ALUMINUM FRAME GLASS WINDOW |
| 9 | WT | 1000 | 1100 | 1000 | 2100 | LIVING | SPECIAL ALUMINUM FRAME GLASS WINDOW |
| 10 | WT | 1000 | 1100 | 1000 | 2100 | LIVING | SPECIAL ALUMINUM FRAME GLASS WINDOW |
| 11 | WT | 1000 | 1100 | 1000 | 2100 | LIVING | SPECIAL ALUMINUM FRAME GLASS WINDOW |
| 12 | WT | 1000 | 1100 | 1000 | 2100 | LIVING | SPECIAL ALUMINUM FRAME GLASS WINDOW |
| 13 | WT | 1000 | 1100 | 1000 | 2100 | LIVING | SPECIAL ALUMINUM FRAME GLASS WINDOW |
| 14 | WT | 1000 | 1100 | 1000 | 2100 | LIVING | SPECIAL ALUMINUM FRAME GLASS WINDOW |
| 15 | WT | 1000 | 1100 | 1000 | 2100 | LIVING | SPECIAL ALUMINUM FRAME GLASS WINDOW |
| 16 | WT | 1000 | 1100 | 1000 | 2100 | LIVING | SPECIAL ALUMINUM FRAME GLASS WINDOW |
| 17 | WT | 1000 | 1100 | 1000 | 2100 | LIVING | SPECIAL ALUMINUM FRAME GLASS WINDOW |
| 18 | WT | 1000 | 1100 | 1000 | 2100 | LIVING | SPECIAL ALUMINUM FRAME GLASS WINDOW |
| 19 | WT | 1000 | 1100 | 1000 | 2100 | LIVING | SPECIAL ALUMINUM FRAME GLASS WINDOW |
| 20 | WT | 1000 | 1100 | 1000 | 2100 | LIVING | SPECIAL ALUMINUM FRAME GLASS WINDOW |

OWNER: **GODREJ PROPERTIES LIMITED**

SUBMISSION DRAWING

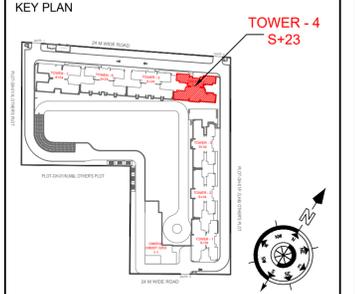

PROJECT: **PROPOSED GROUP HOUSING FOR PLOT NO :- GH-01/B,C,D,E,J & K SECTOR -12, GREATER NOIDA, G.B. NAGAR, (U.P.)**

| DATE | PROJECT INCH. | CHECKED BY |
|----------------|---------------|---------------|
| 08 - 01 - 2025 | BALRAJ SINGH | BALRAJ SINGH |
| SCALE | DEALT BY | APPROVED BY |
| 1:100 | ABDHESH JHA | VISHAL SHARMA |

DRAWING TITLE: **GROUND/STILT FLOOR PLAN**

ARCHITECTS: **TOWER-4**


GOLDEN INDIA ARCHITECTS
THE TEAM OF ARCHITECTS
FF-37, KADAMBA SHOPPING COMPLEX
GAMMA-1 GREATER NOIDA
CON. +91-94-1585-6777

DESIGN BY: **Confluence**
NEW DELHI, INDIA

F-1, FIRST FLOOR, MIRA CORPORATE SUITES,
ISHWAR NAGAR, NEW DELHI 110065

Ph: +91-11-26925684 Member of IGBC
Ph: +91-11-40564768 www.inconfluence.com ISO: 9001:2000
architecture urban design hospitality interiors

DRAWING NO. **S-35** REVISION

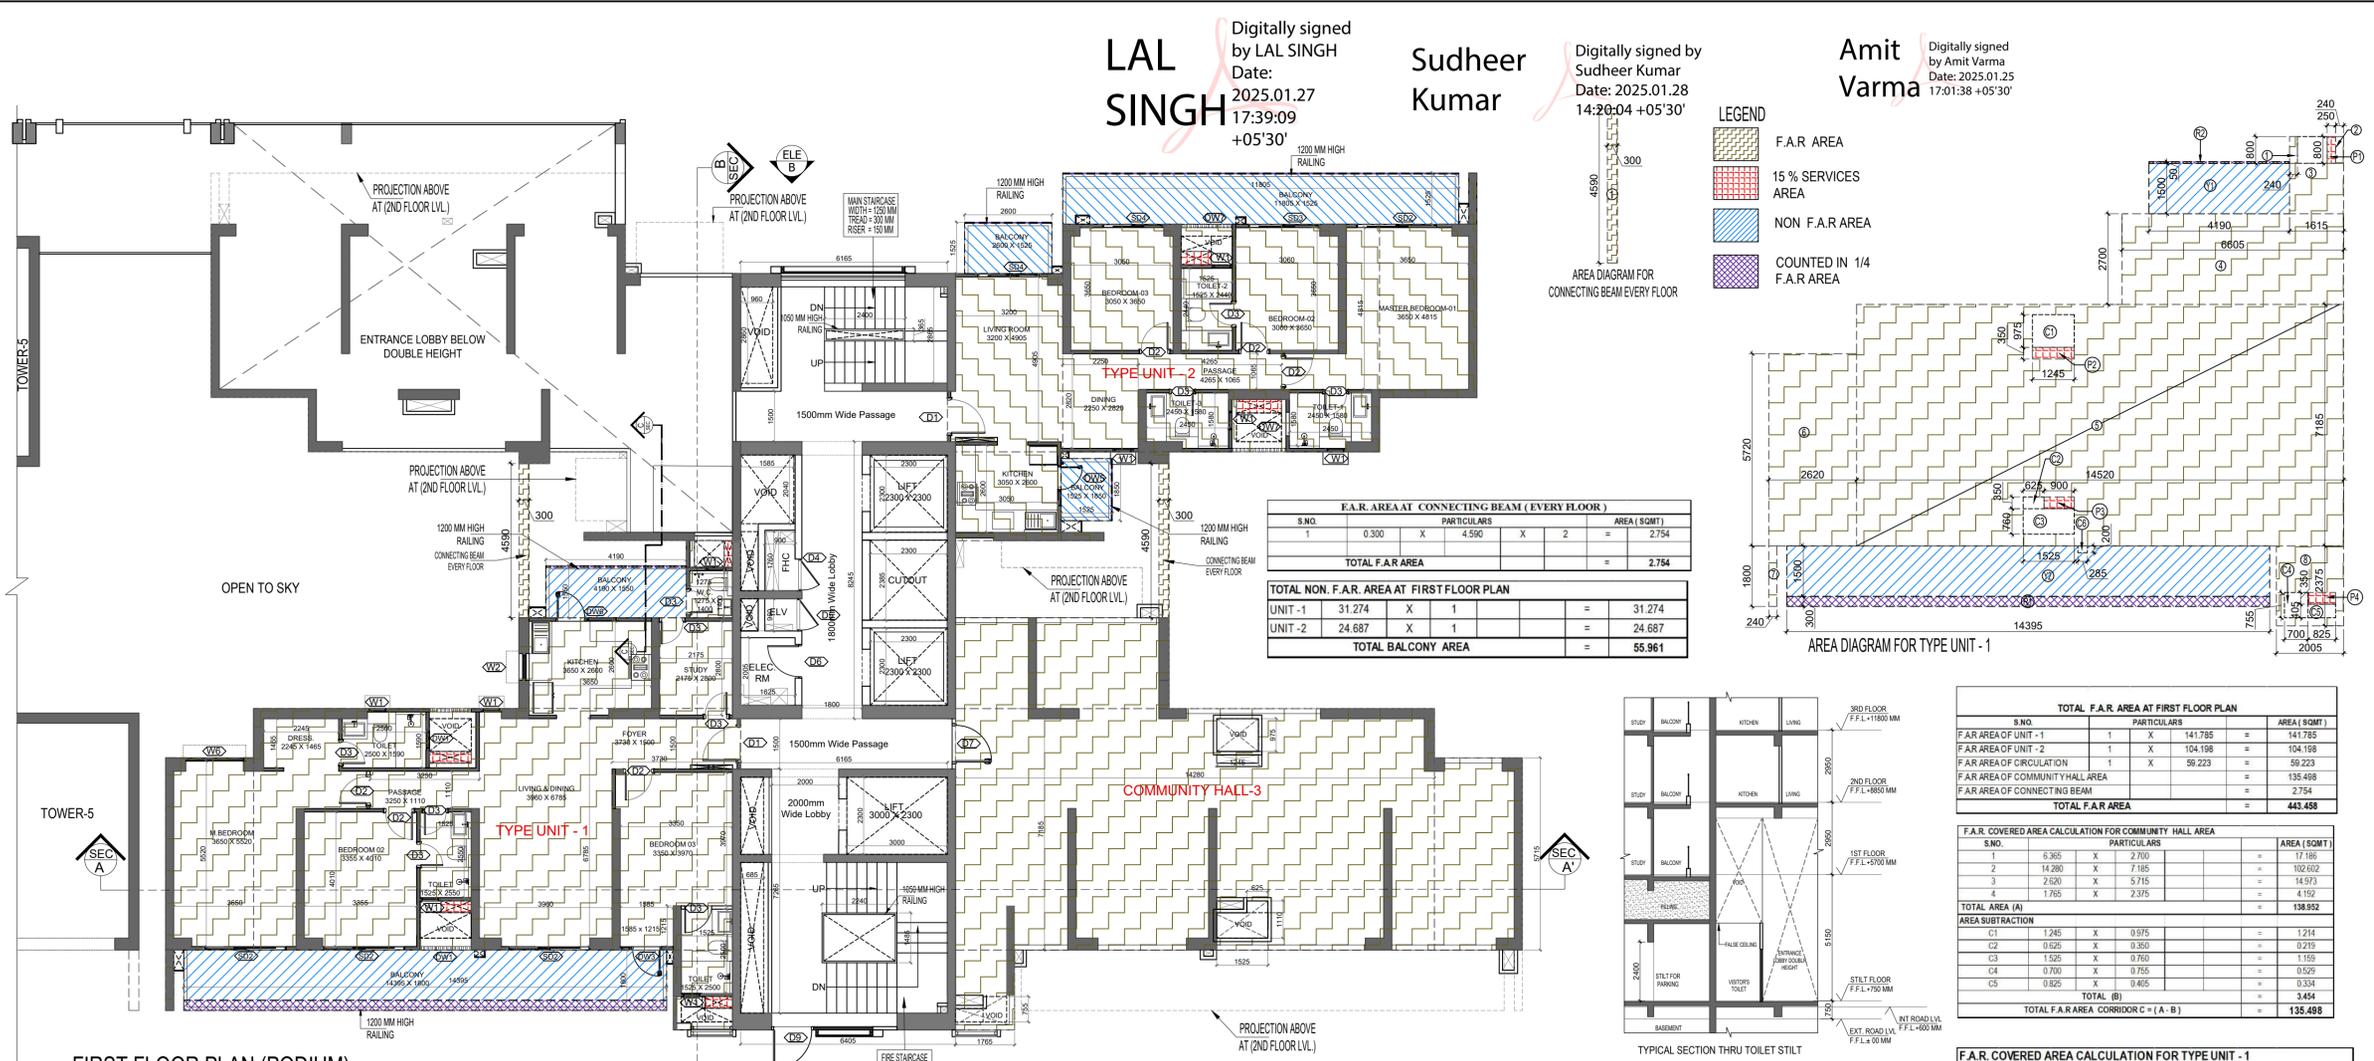

LAL SINGH
Digitally signed by LAL SINGH
Date: 2025.01.27 17:39:09 +05'30'

Sudheer Kumar
Digitally signed by Sudheer Kumar
Date: 2025.01.28 14:20:04 +05'30'

Amit Varma
Digitally signed by Amit Varma
Date: 2025.01.25 17:01:38 +05'30'

LEGEND


- F.A.R AREA
- 15% SERVICES AREA
- NON F.A.R AREA
- COUNTED IN 1/4 F.A.R AREA

F.A.R. AREA AT CONNECTING BEAM (EVERY FLOOR)

| S.NO. | 0.300 X | 4.590 X | 2 | AREA (SQMT) |
|-------------------------|---------|---------|---|--------------|
| 1 | | | | 2.754 |
| TOTAL F.A.R AREA | | | | 2.754 |

TOTAL NON F.A.R. AREA AT FIRST FLOOR PLAN

| UNIT | 1 | 31.274 X | 1 | AREA (SQMT) |
|---------------------------|---|----------|---|---------------|
| UNIT - 1 | | | | 31.274 |
| UNIT - 2 | | | | 24.687 |
| TOTAL BALCONY AREA | | | | 55.961 |

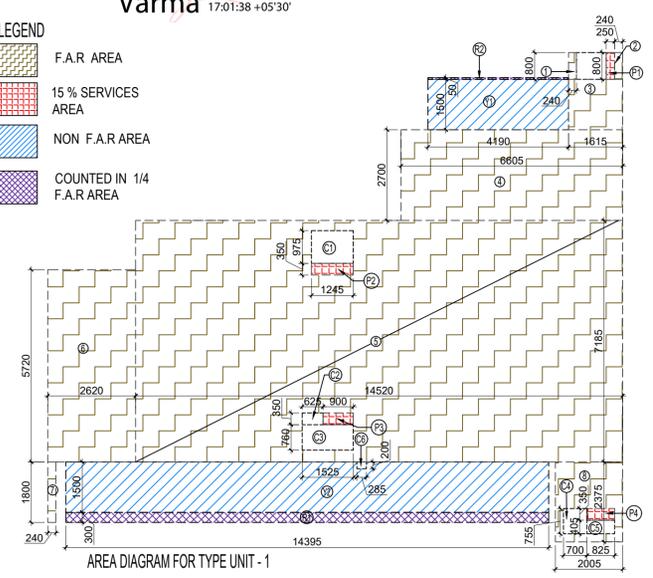

TOTAL F.A.R. AREA AT FIRST FLOOR PLAN


| S.NO. | 1 | X | 141.785 | AREA (SQMT) |
|-----------------------------------|---|---|---------|----------------|
| F.A.R AREA OF UNIT - 1 | | | | 141.785 |
| F.A.R AREA OF UNIT - 2 | | | | 104.198 |
| F.A.R AREA OF COMMUNITY HALL AREA | | | | 59.223 |
| F.A.R AREA OF CONNECTING BEAM | | | | 2.754 |
| TOTAL F.A.R AREA | | | | 443.458 |

F.A.R. COVERED AREA CALCULATION FOR COMMUNITY HALL AREA


| S.NO. | 1 | 6.365 X | 2 | AREA (SQMT) |
|-----------------------|---|---------|---|----------------|
| 1 | | | | 12.730 |
| 2 | | | | 14.973 |
| 3 | | | | 4.152 |
| 4 | | | | 138.952 |
| TOTAL AREA (A) | | | | 138.952 |

AREA SUBTRACTION

| S.NO. | 1 | 1.245 X | 0.975 | AREA (SQMT) |
|--|---|---------|-------|----------------|
| C1 | | | | 1.214 |
| C2 | | | | 0.219 |
| C3 | | | | 1.159 |
| C4 | | | | 0.529 |
| C5 | | | | 0.334 |
| TOTAL (B) | | | | 3.454 |
| TOTAL F.A.R AREA CORRIDOR C = (A - B) | | | | 135.498 |

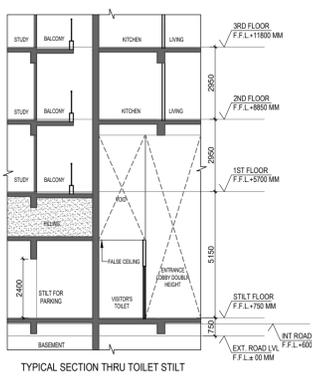

FIRST FLOOR PLAN (PODIUM)

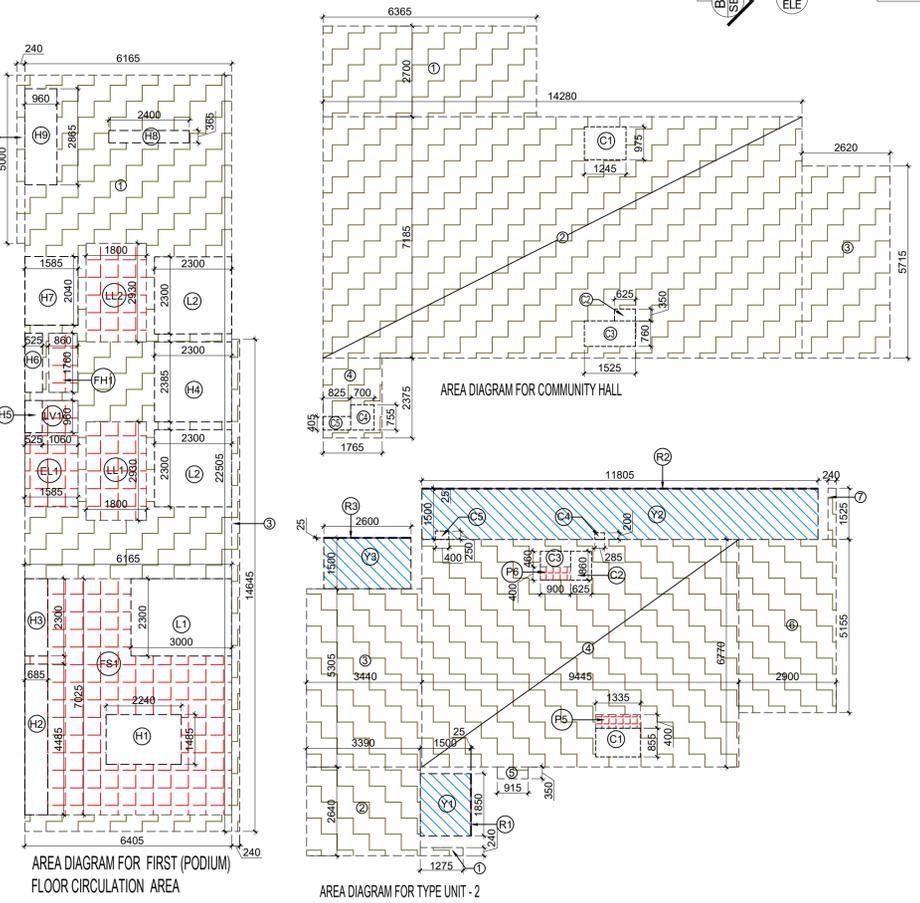

F.A.R. COVERED AREA CALCULATION FOR CIRCULATION AREA

| S.NO. | 1 | 6.165 X | 22.505 | AREA (SQMT) |
|-----------------------|---|---------|--------|----------------|
| 1 | | | | 138.743 |
| 2 | | | | 5.000 |
| 3 | | | | 3.515 |
| TOTAL AREA (A) | | | | 147.258 |

AREA SUBTRACTION

| S.NO. | 1 | 6.165 X | 7.025 | AREA (SQMT) |
|--|---|---------|-------|---------------|
| FS1 | | | | 43.309 |
| LL1 | | | | 5.274 |
| LL2 | | | | 5.274 |
| LV1 | | | | 1.018 |
| FH1 | | | | 1.514 |
| EL1 | | | | 3.503 |
| L2 | | | | 10.580 |
| H4 | | | | 5.486 |
| H5 | | | | 0.504 |
| H6 | | | | 0.924 |
| H7 | | | | 3.233 |
| H8 | | | | 0.876 |
| H9 | | | | 2.741 |
| TOTAL (B) | | | | 84.235 |
| TOTAL F.A.R AREA CORRIDOR C = (A - B) | | | | 59.223 |

CORRIDOR AREA CALCULATION TOWARDS 15% ADDITIONAL F.A.R

| S.NO. | 1 | 6.165 X | 7.025 | AREA (SQMT) |
|---|---|---------|-------|---------------|
| FS1 | | | | 43.309 |
| LL1 | | | | 5.274 |
| LL2 | | | | 5.274 |
| LV1 | | | | 1.018 |
| F.H.C SHAFT | | | | 1.514 |
| ELECTRICAL SHAFT | | | | 3.503 |
| TOTAL CORRIDOR AREA CALCULATION TOWARDS 15% ADDITIONAL F.A.R (A) | | | | 59.891 |

UNIT AREA CALCULATION TOWARDS 15% ADDITIONAL F.A.R

| S.NO. | 1 | 1.245 X | 0.350 | AREA (SQMT) |
|--|---|---------|-------|---------------|
| P1 | | | | 0.200 |
| P2 | | | | 0.436 |
| P3 | | | | 0.315 |
| P4 | | | | 0.334 |
| P5 | | | | 0.534 |
| P6 | | | | 0.360 |
| TOTAL UNIT AREA CALCULATION TOWARDS 15% ADDITIONAL F.A.R (B) | | | | 2.179 |
| TOTAL 15% ADDITIONAL F.A.R AREA (CORRIDOR AREA+UNIT AREA) = C (A+B) | | | | 62.070 |

AREA SUBTRACTION

| S.NO. | 1 | 2.240 X | 1.485 | AREA (SQMT) |
|--|---|---------|-------|---------------|
| H1 | | | | 3.326 |
| H2 | | | | 3.072 |
| H3 | | | | 1.576 |
| L1 | | | | 6.900 |
| TOTAL AREA (D) | | | | 14.874 |
| TOTAL 15% ADDITIONAL F.A.R AREA E = (C - D) | | | | 47.196 |

F.A.R. COVERED AREA CALCULATION FOR TYPE UNIT - 2

| S.NO. | 1 | 1.275 X | 0.240 | AREA (SQMT) |
|----------------------------|---|---------|-------|----------------|
| 1 | | | | 0.306 |
| 2 | | | | 8.950 |
| 3 | | | | 18.249 |
| 4 | | | | 63.943 |
| 5 | | | | 0.320 |
| 6 | | | | 14.950 |
| 7 | | | | 0.366 |
| UNIT FAR AREA = (A) | | | | 107.083 |

AREA SUBTRACTION PLUMBING CUTOUT

| S.NO. | 1 | 1.335 X | 0.400 | AREA (SQMT) |
|-------------------------------------|---|---------|-------|----------------|
| PS | | | | 0.534 |
| PB | | | | 0.360 |
| C1 | | | | 1.141 |
| C2 | | | | 0.538 |
| C3 | | | | 0.414 |
| TOTAL (B) | | | | 2.987 |
| TOTAL F.A.R AREA C = (A - B) | | | | 104.096 |

1/4 F.A.R AREA OF BALCONY

| S.NO. | 1 | 0.025 X | 1.850 | AREA (SQMT) |
|--|---|---------|-------|----------------|
| R1 | | | | 0.046 |
| R2 | | | | 0.295 |
| R3 | | | | 0.065 |
| TOTAL AREA (D) | | | | 0.406 |
| 1/4 BALCONY F.A.R AREA (E) | | | | 0.102 |
| TOTAL UNIT F.A.R AREA F = (C + E) | | | | 104.198 |

NON F.A.R AREA OF BALCONY

| S.NO. | 1 | 1.500 X | 1.850 | AREA (SQMT) |
|------------------------------------|---|---------|-------|---------------|
| Y1 | | | | 2.775 |
| Y2 | | | | 17.708 |
| Y3 | | | | 3.900 |
| 3/4 AREA OF BALCONY (D - E) | | | | 0.305 |
| TOTAL BALCONY AREA (G) | | | | 24.687 |

AREA SUBTRACTION

| S.NO. | 1 | 0.285 X | 0.200 | AREA (SQMT) |
|-------------------------------------|---|---------|-------|---------------|
| C4 | | | | 0.057 |
| C5 | | | | 0.100 |
| TOTAL (H) | | | | 0.157 |
| TOTAL F.A.R AREA J = (G - H) | | | | 24.530 |

15% SERVICES AREA OF UNIT (PLUMBING SHAFT)

| S.NO. | 1 | 1.335 X | 0.400 | AREA (SQMT) |
|--|---|---------|-------|--------------|
| P5 | | | | 0.534 |
| P6 | | | | 0.360 |
| TOTAL 15% SERVICES AREA OF UNIT (H) | | | | 0.894 |

COVERAGE AREA FOR UNIT = (F + G + H)

| S.NO. | 1 | 104.198 | 24.687 | 0.894 | AREA (SQMT) |
|---------------------------------|---|---------|--------|-------|----------------|
| 1 | | | | | 104.198 |
| 2 | | | | | 24.687 |
| 3 | | | | | 0.894 |
| TOTAL UNIT COVERAGE AREA | | | | | 129.779 |

F.A.R. COVERED AREA CALCULATION FOR TYPE UNIT - 1

| S.NO. | 1 | 0.240 X | 0.800 | AREA (SQMT) |
|----------------------------|---|---------|-------|----------------|
| 1 | | | | 0.192 |
| 2 | | | | 0.192 |
| 3 | | | | 2.423 |
| 4 | | | | 17.834 |
| 5 | | | | 104.326 |
| 6 | | | | 14.986 |
| 7 | | | | 0.432 |
| 8 | | | | 4.782 |
| UNIT FAR AREA = (A) | | | | 145.146 |

AREA SUBTRACTION PLUMBING CUTOUT

| S.NO. | 1 | 1.245 X | 0.350 | AREA (SQMT) |
|-------------------------------------|---|---------|-------|----------------|
| P2 | | | | 0.436 |
| P3 | | | | 0.315 |
| P4 | | | | 0.289 |
| C1 | | | | 1.214 |
| C2 | | | | 0.219 |
| C3 | | | | 1.159 |
| C4 | | | | 0.529 |
| C5 | | | | 0.334 |
| TOTAL (B) | | | | 4.494 |
| TOTAL F.A.R AREA C = (A - B) | | | | 140.653 |

1/4 F.A.R AREA OF BALCONY

| S.NO. | 1 | 14.395 X | 0.300 | AREA (SQMT) |
|--|---|----------|-------|----------------|
| R1 | | | | 4.319 |
| R2 | | | | 0.210 |
| TOTAL AREA (D) | | | | 4.528 |
| 1/4 BALCONY F.A.R AREA (E) | | | | 1.132 |
| TOTAL UNIT F.A.R AREA F = (C + E) | | | | 141.785 |

NON F.A.R AREA OF BALCONY

| S.NO. | 1 | 4.190 X | 1.500 | AREA (SQMT) |
|------------------------------------|---|---------|-------|---------------|
| Y1 | | | | 6.285 |
| Y2 | | | | 21.593 |
| 3/4 AREA OF BALCONY (D - E) | | | | 3.396 |
| TOTAL BALCONY AREA (G) | | | | 31.274 |

AREA SUBTRACTION

| S.NO. | 1 | 0.285 X | 0.200 | AREA (SQMT) |
|-------------------------------------|---|---------|-------|---------------|
| C6 | | | | 0.057 |
| TOTAL (H) | | | | 0.057 |
| TOTAL F.A.R AREA J = (G - H) | | | | 31.217 |

15% SERVICES AREA OF UNIT (PLUMBING SHAFT)

| S.NO. | 1 | 0.250 X | 0.800 | AREA (SQMT) |
|--|---|---------|-------|--------------|
| P1 | | | | 0.200 |
| P2 | | | | 0.436 |
| P3 | | | | 0.315 |
| P4 | | | | 0.289 |
| TOTAL 15% SERVICES AREA OF UNIT (K) | | | | 1.240 |

COVERAGE AREA FOR UNIT = (F + G + J)

| S.NO. | 1 | 141.785 | 31.274 | 1.240 | AREA (SQMT) |
|---------------------------------|---|---------|--------|-------|----------------|
| 1 | | | | | 141.785 |
| 2 | | | | | 31.274 |
| 3 | | | | | 1.240 |
| TOTAL UNIT COVERAGE AREA | | | | | 174.299 |

OWNER SIGN
Rajat pathak
2025.01.27 12:31:11 +05'30'

ARCHITECT SIGN
AVANISH SRIVASTAV
2025.01.23 12:31:19 +05'30'


TOWN PLANNER SIGN

DOOR SCHEDULE


| S.NO. | TYPE | OPENING | HEIGHT | WALL | LEVEL | LOCATION | DESCRIPTION |
|-------|------|---------|--------|------|-------|----------|-----------------------|
| 1 | DOOR | 2100 | 2100 | 2100 | 2100 | LIVING | UPVC FRAME GLASS DOOR |
| 2 | DOOR | 2100 | 2100 | 2100 | 2100 | KITCHEN | UPVC FRAME GLASS DOOR |
| 3 | DOOR | 2100 | 2100 | 2100 | 2100 | BEDROOM | UPVC FRAME GLASS DOOR |
| 4 | DOOR | 2100 | 2100 | 2100 | 2100 | BEDROOM | UPVC FRAME GLASS DOOR |
| 5 | DOOR | 2100 | 2100 | 2100 | 2100 | BEDROOM | UPVC FRAME GLASS DOOR |
| 6 | DOOR | 2100 | 2100 | 2100 | 2100 | BEDROOM | UPVC FRAME GLASS DOOR |
| 7 | DOOR | 2100 | 2100 | 2100 | 2100 | BEDROOM | UPVC FRAME GLASS DOOR |
| 8 | DOOR | 2100 | 2100 | 2100 | 2100 | BEDROOM | UPVC FRAME GLASS DOOR |
| 9 | DOOR | 2100 | 2100 | 2100 | 2100 | BEDROOM | UPVC FRAME GLASS DOOR |
| 10 | DOOR | 2100 | 2100 | 2100 | 2100 | BEDROOM | UPVC FRAME GLASS DOOR |
| 11 | DOOR | 2100 | 2100 | 2100 | 2100 | BEDROOM | UPVC FRAME GLASS DOOR |
| 12 | DOOR | 2100 | 2100 | 2100 | 2100 | BEDROOM | UPVC FRAME GLASS DOOR |
| 13 | DOOR | 2100 | 2100 | 2100 | 2100 | BEDROOM | UPVC FRAME GLASS DOOR |
| 14 | DOOR | 2100 | 2100 | 2100 | 2100 | BEDROOM | UPVC FRAME GLASS DOOR |
| 15 | DOOR | 2100 | 2100 | 2100 | 2100 | BEDROOM | UPVC FRAME GLASS DOOR |
| 16 | DOOR | 2100 | 2100 | 2100 | 2100 | BEDROOM | UPVC FRAME GLASS DOOR |
| 17 | DOOR | 2100 | 2100 | 2100 | 2100 | BEDROOM | UPVC FRAME GLASS DOOR |
| 18 | DOOR | 2100 | 2100 | 2100 | 2100 | BEDROOM | UPVC FRAME GLASS DOOR |
| 19 | DOOR | 2100 | 2100 | 2100 | 2100 | BEDROOM | UPVC FRAME GLASS DOOR |
| 20 | DOOR | 2100 | 2100 | 2100 | 2100 | BEDROOM | UPVC FRAME GLASS DOOR |

WINDOW SCHEDULE

| S.NO. | TYPE | OPENING | HEIGHT | WALL | LEVEL | LOCATION | DESCRIPTION |
|-------|--------|---------|--------|------|-------|----------|-------------------------|
| 1 | WINDOW | 600 | 2100 | 1900 | 2100 | LIVING | UPVC FRAME GLASS WINDOW |
| 2 | WINDOW | 450 | 1150 | 1050 | 2100 | KITCHEN | UPVC FRAME GLASS WINDOW |
| 3 | WINDOW | 900 | 1150 | 1050 | 2100 | DINING | UPVC FRAME GLASS WINDOW |
| 4 | WINDOW | 450 | 1150 | 1050 | 2100 | LIVING | UPVC FRAME GLASS WINDOW |
| 5 | | | | | | | |

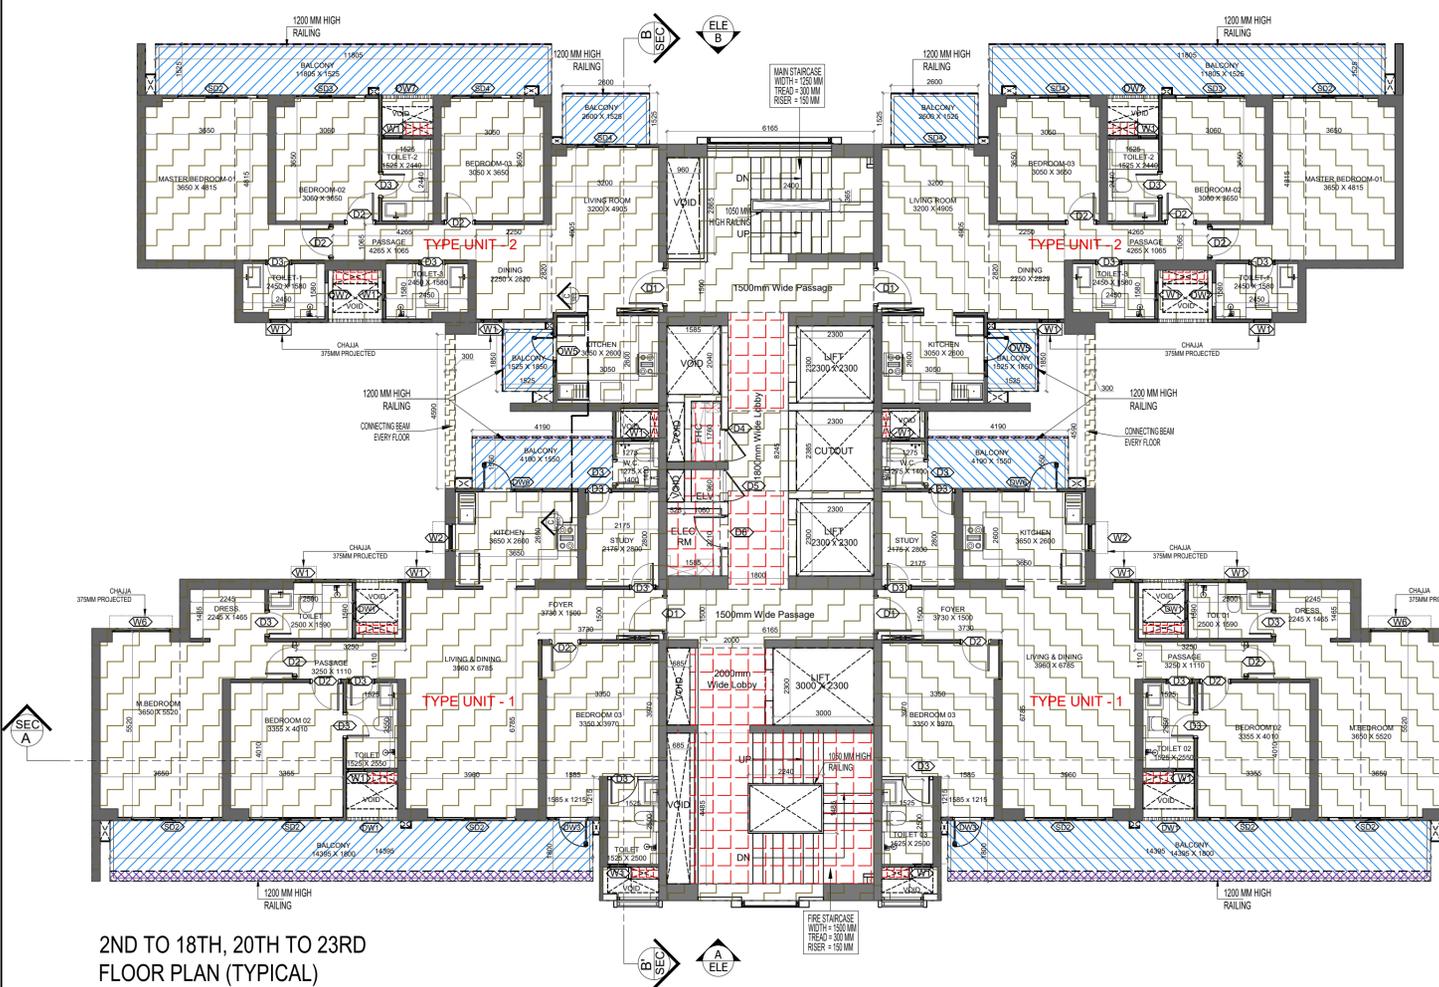

2ND TO 18TH, 20TH TO 23RD FLOOR PLAN (TYPICAL)

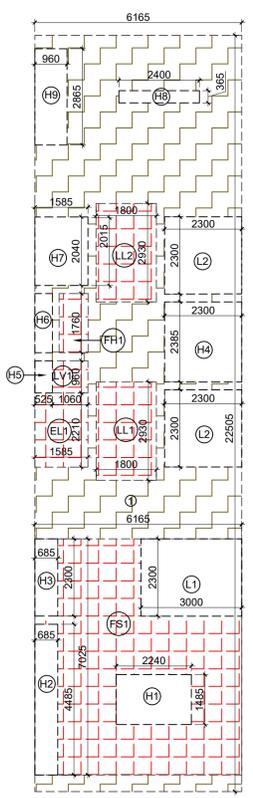

AREA DIAGRAM FOR TYPICAL FLOOR CIRCULATION AREA


| S.NO. | PARTICULARS | AREA (SQM) |
|--|-------------------|-----------------|
| 1 | 6.165 X 22.505 | = 138.743 |
| TOTAL AREA (A) | | |
| AREA SUBTRACTION | | |
| FS1 | 6.165 X 7.025 | = 43.309 |
| LL1 | 1.800 X 2.930 | = 5.274 |
| LL2 | 1.800 X 2.930 | = 5.274 |
| LV1 | 1.060 X 0.960 | = 1.018 |
| FH1 | 0.860 X 1.760 | = 1.514 |
| EL1 | 1.585 X 2.210 | = 3.503 |
| L2 | 2.300 X 2.300 X 2 | = 10.580 |
| H4 | 2.300 X 2.385 | = 5.486 |
| H5 | 0.525 X 0.960 | = 0.504 |
| H6 | 0.525 X 1.760 | = 0.924 |
| H7 | 1.585 X 2.040 | = 3.233 |
| H8 | 2.400 X 0.365 | = 0.876 |
| H9 | 0.960 X 2.855 | = 2.741 |
| TOTAL (B) | | = 84.235 |
| TOTAL F.A.R AREA CORRIDOR C = (A - B) | | = 54.508 |

| S.NO. | PARTICULARS | AREA (SQM) |
|--|-------------------|-----------------|
| FS1 | 6.165 X 7.025 | = 43.309 |
| LL1 | 1.800 X 2.930 | = 5.274 |
| LL2 | 1.800 X 2.930 | = 5.274 |
| LV SHAFT | FH1 0.860 X 1.760 | = 1.514 |
| F.H.C SHAFT | LV1 1.060 X 0.960 | = 1.018 |
| ELECTRICAL SHAFT | EL1 1.585 X 2.210 | = 3.503 |
| TOTAL CORRIDOR AREA CALCULATION TOWARDS 15% ADDITIONAL F.A.R (A) | | = 59.891 |
| UNIT AREA CALCULATION TOWARDS 15% ADDITIONAL F.A.R | | |
| PLUMBING SHAFT | | |
| P1 | 0.250 X 0.800 X 2 | = 0.400 |
| P2 | 1.245 X 0.350 X 2 | = 0.872 |
| P3 | 0.900 X 0.350 X 2 | = 0.630 |
| P4 | 0.825 X 0.405 X 2 | = 0.668 |
| P5 | 1.335 X 0.400 X 2 | = 1.068 |
| P6 | 0.900 X 0.400 X 2 | = 0.720 |
| TOTAL UNIT AREA CALCULATION TOWARDS 15% ADDITIONAL F.A.R (B) | | = 4.358 |
| TOTAL 15% ADDITIONAL F.A.R AREA (CORRIDOR AREA + UNIT AREA) = C = (A + B) | | = 64.249 |
| AREA SUBTRACTION | | |
| H1 | 2.240 X 1.485 | = 3.328 |
| H2 | 0.655 X 4.485 | = 2.932 |
| H3 | 0.655 X 2.300 | = 1.578 |
| L1 | 3.000 X 2.300 | = 6.900 |
| TOTAL AREA (D) | | = 14.874 |
| TOTAL 15% ADDITIONAL F.A.R AREA E = (C - D) | | = 49.375 |

| S.NO. | PARTICULARS | AREA (SQM) |
|--|-------------------|----------------|
| 1 | 0.300 X 4.590 X 2 | = 2.754 |
| TOTAL F.A.R AREA AT CONNECTING BEAM (EVERY FLOOR) | | = 2.754 |

| S.NO. | PARTICULARS | AREA (SQM) |
|--|-------------|------------------|
| 1 | 31.274 X 2 | = 62.547 |
| 2 | 24.687 X 2 | = 49.375 |
| TOTAL NON-F.A.R AREA AT 2ND TO 18TH & 20TH TO 23RD FLOOR PLAN (TYPICAL) | | = 111.922 |

| S.NO. | PARTICULARS | AREA (SQM) |
|---|-------------------------------|------------------|
| 1 | 1.275 X 0.240 | = 0.306 |
| 2 | 3.390 X 2.640 | = 8.950 |
| 3 | 3.440 X 5.305 | = 18.249 |
| 4 | 9.445 X 6.770 | = 63.943 |
| 5 | 0.915 X 0.350 | = 0.320 |
| 6 | 2.900 X 5.155 | = 14.950 |
| 7 | 0.240 X 1.525 | = 0.366 |
| UNIT FAR AREA = (A) | | = 107.083 |
| AREA SUBTRACTION PLUMBING CUTOUT | | |
| P5 | 1.335 X 0.400 | = 0.534 |
| P6 | 0.900 X 0.400 | = 0.360 |
| C1 | 1.335 X 0.855 | = 1.141 |
| C2 | 0.625 X 0.860 | = 0.538 |
| C3 | 0.900 X 0.460 | = 0.414 |
| TOTAL (B) | | = 2.987 |
| TOTAL F.A.R AREA C = (A - B) | | = 104.096 |
| 1/4 F.A.R AREA OF BALCONY | | |
| R1 | 0.025 X 1.850 | = 0.046 |
| R2 | 11.805 X 0.025 | = 0.295 |
| R3 | 2.600 X 0.025 | = 0.065 |
| TOTAL AREA (D) | | = 0.406 |
| 1/4 BALCONY F.A.R AREA (E) | | = 0.102 |
| TOTAL UNIT F.A.R AREA F = (C + E) | | = 104.198 |
| NON-F.A.R AREA OF BALCONY | | |
| Y1 | 1.500 X 1.850 | = 2.775 |
| Y2 | 11.805 X 1.500 | = 17.708 |
| Y3 | 2.600 X 1.500 | = 3.900 |
| 3/4 AREA OF BALCONY (D - E) | | = 0.305 |
| TOTAL BALCONY AREA (G) | | = 24.687 |
| AREA SUBTRACTION | | |
| C4 | 0.285 X 0.200 | = 0.057 |
| C5 | 0.400 X 0.250 | = 0.100 |
| TOTAL (H) | | = 0.157 |
| TOTAL F.A.R AREA J = (G - H) | | = 24.530 |
| 15% SERVICES AREA OF UNIT (PLUMBING SHAFT) | | |
| P5 | 1.335 X 0.400 | = 0.534 |
| P6 | 0.900 X 0.400 | = 0.360 |
| TOTAL 15% SERVICES AREA OF UNIT (H) | | = 0.894 |
| COVERAGE AREA FOR UNIT = (F + G + H) | | |
| 1 | TOTAL UNIT F.A.R AREA (F) | = 104.198 |
| 2 | NON-F.A.R AREA OF UNIT (G) | = 24.687 |
| 3 | 15% SERVICES AREA OF UNIT (H) | = 0.894 |
| TOTAL UNIT COVERAGE AREA | | 129.779 |

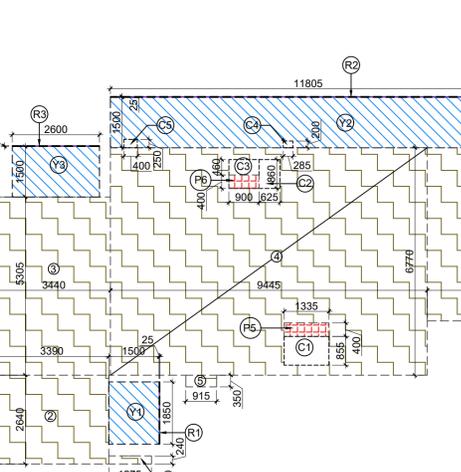


AREA DIAGRAM FOR TYPE UNIT - 2

Amit Varma Digitally signed by Amit Varma Date: 2025.01.25 17:02:00 +05'30'


Sudheer Kumar Digitally signed by Sudheer Kumar Date: 2025.01.28 14:20:30 +05'30'

LAL SINGH Digitally signed by LAL SINGH Date: 2025.01.27 17:39:30 +05'30'

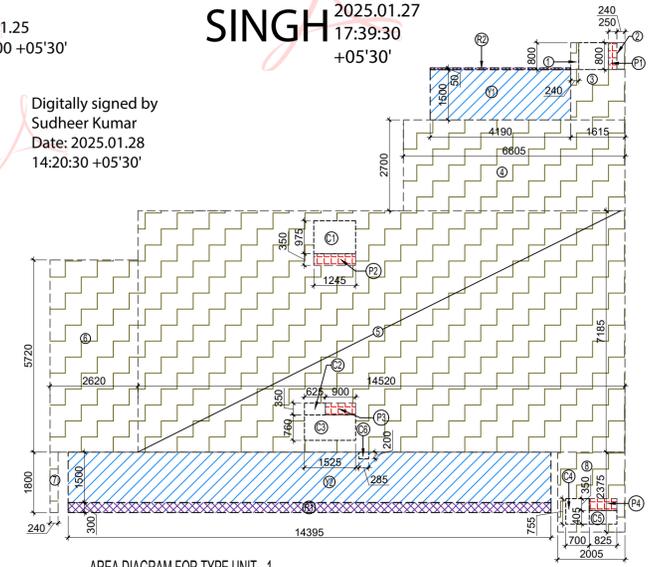

AREA DIAGRAM FOR TYPE UNIT - 1

| S.NO. | PARTICULARS | AREA (SQM) |
|-------------------------|-------------------|----------------|
| 1 | 0.300 X 4.590 X 2 | = 2.754 |
| TOTAL F.A.R AREA | | = 2.754 |

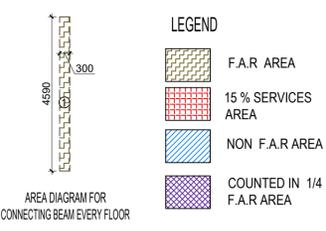

| S.NO. | PARTICULARS | AREA (SQM) |
|---|-------------------------------|------------------|
| 1 | 1.275 X 0.240 | = 0.306 |
| 2 | 3.390 X 2.640 | = 8.950 |
| 3 | 3.440 X 5.305 | = 18.249 |
| 4 | 9.445 X 6.770 | = 63.943 |
| 5 | 0.915 X 0.350 | = 0.320 |
| 6 | 2.900 X 5.155 | = 14.950 |
| 7 | 0.240 X 1.525 | = 0.366 |
| UNIT FAR AREA = (A) | | = 107.083 |
| AREA SUBTRACTION PLUMBING CUTOUT | | |
| P5 | 1.335 X 0.400 | = 0.534 |
| P6 | 0.900 X 0.400 | = 0.360 |
| C1 | 1.335 X 0.855 | = 1.141 |
| C2 | 0.625 X 0.860 | = 0.538 |
| C3 | 0.900 X 0.460 | = 0.414 |
| TOTAL (B) | | = 2.987 |
| TOTAL F.A.R AREA C = (A - B) | | = 104.096 |
| 1/4 F.A.R AREA OF BALCONY | | |
| R1 | 0.025 X 1.850 | = 0.046 |
| R2 | 11.805 X 0.025 | = 0.295 |
| R3 | 2.600 X 0.025 | = 0.065 |
| TOTAL AREA (D) | | = 0.406 |
| 1/4 BALCONY F.A.R AREA (E) | | = 0.102 |
| TOTAL UNIT F.A.R AREA F = (C + E) | | = 104.198 |
| NON-F.A.R AREA OF BALCONY | | |
| Y1 | 1.500 X 1.850 | = 2.775 |
| Y2 | 11.805 X 1.500 | = 17.708 |
| Y3 | 2.600 X 1.500 | = 3.900 |
| 3/4 AREA OF BALCONY (D - E) | | = 0.305 |
| TOTAL BALCONY AREA (G) | | = 24.687 |
| AREA SUBTRACTION | | |
| C4 | 0.285 X 0.200 | = 0.057 |
| C5 | 0.400 X 0.250 | = 0.100 |
| TOTAL (H) | | = 0.157 |
| TOTAL F.A.R AREA J = (G - H) | | = 24.530 |
| 15% SERVICES AREA OF UNIT (PLUMBING SHAFT) | | |
| P5 | 1.335 X 0.400 | = 0.534 |
| P6 | 0.900 X 0.400 | = 0.360 |
| TOTAL 15% SERVICES AREA OF UNIT (H) | | = 0.894 |
| COVERAGE AREA FOR UNIT = (F + G + H) | | |
| 1 | TOTAL UNIT F.A.R AREA (F) | = 104.198 |
| 2 | NON-F.A.R AREA OF UNIT (G) | = 24.687 |
| 3 | 15% SERVICES AREA OF UNIT (H) | = 0.894 |
| TOTAL UNIT COVERAGE AREA | | 129.779 |

| S.NO. | PARTICULARS | AREA (SQM) |
|---|-------------------------------|------------------|
| 1 | 0.240 X 0.800 | = 0.192 |
| 2 | 0.240 X 0.800 | = 0.192 |
| 3 | 1.615 X 1.500 | = 2.423 |
| 4 | 8.605 X 2.700 | = 23.237 |
| 5 | 14.520 X 7.185 | = 104.326 |
| 6 | 2.620 X 5.720 | = 14.986 |
| 7 | 0.240 X 1.800 | = 0.432 |
| 8 | 2.005 X 2.375 | = 4.762 |
| UNIT FAR AREA = (A) | | = 145.146 |
| AREA SUBTRACTION PLUMBING CUTOUT | | |
| P2 | 1.245 X 0.350 | = 0.436 |
| P3 | 0.900 X 0.350 | = 0.315 |
| P4 | 0.825 X 0.350 | = 0.289 |
| C1 | 1.245 X 0.975 | = 1.214 |
| C2 | 0.625 X 0.350 | = 0.219 |
| C3 | 1.525 X 0.760 | = 1.159 |
| C4 | 0.700 X 0.755 | = 0.529 |
| C5 | 0.825 X 0.405 | = 0.334 |
| TOTAL (B) | | = 4.494 |
| TOTAL F.A.R AREA C = (A - B) | | = 140.653 |
| 1/4 F.A.R AREA OF BALCONY | | |
| R1 | 14.395 X 0.300 | = 4.319 |
| R2 | 4.190 X 0.050 | = 0.210 |
| TOTAL AREA (D) | | = 4.528 |
| 1/4 BALCONY F.A.R AREA (E) | | = 1.132 |
| TOTAL UNIT F.A.R AREA F = (C + E) | | = 141.785 |
| NON-F.A.R AREA OF BALCONY | | |
| Y1 | 4.190 X 1.500 | = 6.285 |
| Y2 | 14.395 X 1.500 | = 21.593 |
| 3/4 AREA OF BALCONY (D - E) | | = 3.396 |
| TOTAL BALCONY AREA (G) | | = 31.274 |
| AREA SUBTRACTION | | |
| C6 | 0.285 X 0.200 | = 0.057 |
| TOTAL (H) | | = 0.057 |
| TOTAL F.A.R AREA J = (G - H) | | = 31.217 |
| 15% SERVICES AREA OF UNIT (PLUMBING SHAFT) | | |
| P1 | 0.250 X 0.800 | = 0.200 |
| P2 | 1.245 X 0.350 | = 0.436 |
| P3 | 0.900 X 0.350 | = 0.315 |
| P4 | 0.825 X 0.350 | = 0.289 |
| TOTAL 15% SERVICES AREA OF UNIT (K) | | = 1.240 |
| COVERAGE AREA FOR UNIT = (F + J + K) | | |
| 1 | TOTAL UNIT F.A.R AREA (F) | = 141.785 |
| 2 | NON-F.A.R AREA OF UNIT (J) | = 31.274 |
| 3 | 15% SERVICES AREA OF UNIT (K) | = 1.240 |
| TOTAL UNIT COVERAGE AREA | | 174.298 |

| S.NO. | PARTICULARS | AREA (SQM) |
|-------------------------|-------------------|----------------|
| 1 | 0.300 X 4.590 X 2 | = 2.754 |
| TOTAL F.A.R AREA | | = 2.754 |

| S.NO. | PARTICULARS | AREA (SQM) |
|--|-------------|------------------|
| 1 | 31.274 X 2 | = 62.547 |
| 2 | 24.687 X 2 | = 49.375 |
| TOTAL NON-F.A.R AREA AT 2ND TO 18TH & 20TH TO 23RD FLOOR PLAN (TYPICAL) | | = 111.922 |

| S.NO. | PARTICULARS | AREA (SQM) |
|---|-------------------------------|------------------|
| 1 | 1.275 X 0.240 | = 0.306 |
| 2 | 3.390 X 2.640 | = 8.950 |
| 3 | 3.440 X 5.305 | = 18.249 |
| 4 | 9.445 X 6.770 | = 63.943 |
| 5 | 0.915 X 0.350 | = 0.320 |
| 6 | 2.900 X 5.155 | = 14.950 |
| 7 | 0.240 X 1.525 | = 0.366 |
| UNIT FAR AREA = (A) | | = 107.083 |
| AREA SUBTRACTION PLUMBING CUTOUT | | |
| P5 | 1.335 X 0.400 | = 0.534 |
| P6 | 0.900 X 0.400 | = 0.360 |
| C1 | 1.335 X 0.855 | = 1.141 |
| C2 | 0.625 X 0.860 | = 0.538 |
| C3 | 0.900 X 0.460 | = 0.414 |
| TOTAL (B) | | = 2.987 |
| TOTAL F.A.R AREA C = (A - B) | | = 104.096 |
| 1/4 F.A.R AREA OF BALCONY | | |
| R1 | 0.025 X 1.850 | = 0.046 |
| R2 | 11.805 X 0.025 | = 0.295 |
| R3 | 2.600 X 0.025 | = 0.065 |
| TOTAL AREA (D) | | = 0.406 |
| 1/4 BALCONY F.A.R AREA (E) | | = 0.102 |
| TOTAL UNIT F.A.R AREA F = (C + E) | | = 104.198 |
| NON-F.A.R AREA OF BALCONY | | |
| Y1 | 1.500 X 1.850 | = 2.775 |
| Y2 | 11.805 X 1.500 | = 17.708 |
| Y3 | 2.600 X 1.500 | = 3.900 |
| 3/4 AREA OF BALCONY (D - E) | | = 0.305 |
| TOTAL BALCONY AREA (G) | | = 24.687 |
| AREA SUBTRACTION | | |
| C4 | 0.285 X 0.200 | = 0.057 |
| C5 | 0.400 X 0.250 | = 0.100 |
| TOTAL (H) | | = 0.157 |
| TOTAL F.A.R AREA J = (G - H) | | = 24.530 |
| 15% SERVICES AREA OF UNIT (PLUMBING SHAFT) | | |
| P5 | 1.335 X 0.400 | = 0.534 |
| P6 | 0.900 X 0.400 | = 0.360 |
| TOTAL 15% SERVICES AREA OF UNIT (H) | | = 0.894 |
| COVERAGE AREA FOR UNIT = (F + G + H) | | |
| 1 | TOTAL UNIT F.A.R AREA (F) | = 104.198 |
| 2 | NON-F.A.R AREA OF UNIT (G) | = 24.687 |
| 3 | 15% SERVICES AREA OF UNIT (H) | = 0.894 |
| TOTAL UNIT COVERAGE AREA | | 129.779 |

| S.NO. | PARTICULARS | AREA (SQM) |
|-------|----------------|------------|
| 1 | 0.240 X 0.800 | = 0.192 |
| 2 | 0.240 X 0.800 | = 0.192 |
| 3 | 1.615 X 1.500 | = 2.423 |
| 4 | 8.605 X 2.700 | = 23.237 |
| 5 | 14.520 X 7.185 | = 104.326 |
| 6 | 2.620 X 5.720 | = 14.986 |
| 7 | 0.240 X 1.800 | = 0.432 |
| 8 | 2.005 X 2.375 | = 4.762 |

OWNER SIGN
Rajat pathak
 Rajat pathak
 2025.01.23
 12:31:59
 +05'30'

ARCHITECT SIGN
AVANISH SRIVASTAV
 AVANISH SRIVASTAV
 2025.01.23
 12:32:07
 +05'30'

TOWN PLANNER SIGN

DOOR SCHEDULE

| S.NO. | TYPE | OPENING | HEIGHT | W.C. | LOCATION | DESCRIPTION |
|-------|------|---------|--------|------|----------|-----------------------|
| 1 | DOOR | 2100 | 2100 | | LIVING | UPVC FRAME GLASS DOOR |
| 2 | DOOR | 2100 | 2100 | | BEDROOM | UPVC FRAME GLASS DOOR |
| 3 | DOOR | 2100 | 2100 | | KITCHEN | UPVC FRAME GLASS DOOR |
| 4 | DOOR | 2100 | 2100 | | BEDROOM | UPVC FRAME GLASS DOOR |
| 5 | DOOR | 2100 | 2100 | | BEDROOM | UPVC FRAME GLASS DOOR |
| 6 | DOOR | 2100 | 2100 | | BEDROOM | UPVC FRAME GLASS DOOR |
| 7 | DOOR | 2100 | 2100 | | BEDROOM | UPVC FRAME GLASS DOOR |
| 8 | DOOR | 2100 | 2100 | | BEDROOM | UPVC FRAME GLASS DOOR |
| 9 | DOOR | 2100 | 2100 | | BEDROOM | UPVC FRAME GLASS DOOR |
| 10 | DOOR | 2100 | 2100 | | BEDROOM | UPVC FRAME GLASS DOOR |
| 11 | DOOR | 2100 | 2100 | | BEDROOM | UPVC FRAME GLASS DOOR |
| 12 | DOOR | 2100 | 2100 | | BEDROOM | UPVC FRAME GLASS DOOR |
| 13 | DOOR | 2100 | 2100 | | BEDROOM | UPVC FRAME GLASS DOOR |
| 14 | DOOR | 2100 | 2100 | | BEDROOM | UPVC FRAME GLASS DOOR |
| 15 | DOOR | 2100 | 2100 | | BEDROOM | UPVC FRAME GLASS DOOR |
| 16 | DOOR | 2100 | 2100 | | BEDROOM | UPVC FRAME GLASS DOOR |
| 17 | DOOR | 2100 | 2100 | | BEDROOM | UPVC FRAME GLASS DOOR |
| 18 | DOOR | 2100 | 2100 | | BEDROOM | UPVC FRAME GLASS DOOR |
| 19 | DOOR | 2100 | 2100 | | BEDROOM | UPVC FRAME GLASS DOOR |
| 20 | DOOR | 2100 | 2100 | | BEDROOM | UPVC FRAME GLASS DOOR |

WINDOW SCHEDULE

| S.NO. | TYPE | OPENING | HEIGHT | W.C. | LOCATION | DESCRIPTION |
|-------|------|---------|--------|------|----------|-------------|
| 1 | W1 | 400 | 2200 | 1900 | 2200 | TOILET |
| 2 | W2 | 400 | 1100 | 1500 | 2300 | DRESS |
| 3 | W3 | 400 | 1100 | 1500 | 2200 | DINING |
| 4 | W4 | 400 | 1100 | 1500 | 2200 | W.C. TOILET |
| 5 | W5 | 1000 | 1100 | 1500 | 2300 | LIVING |
| 6 | W6 | 1700 | 1100 | 1500 | 2200 | M. BEDROOM |

OWNER
GODREJ PROPERTIES LIMITED

SUBMISSION DRAWING

KEY PLAN

PROJECT

PROPOSED GROUP HOUSING FOR PLOT NO :- GH-01/B,C,D,E,J & K SECTOR-12, GREATER NOIDA, G.B. NAGAR, (U.P.)

| DATE | PROJECT INCH. | CHECKED BY |
|------------|---------------|---------------|
| 08-01-2025 | BALRAJ SINGH | BALRAJ SINGH |
| SCALE | DEALT BY | APPROVED BY |
| 1:100 | ABDHESH JHA | VISHAL SHARMA |

DRAWING TITLE

19TH FLOOR PLAN (REFUGE LVL.)

TOWER-4

ARCHITECTS

GOLDEN INDIA ARCHITECTS

THE TEAM OF ARCHITECTS
 FF-37, KADAMBA SHOPPING COMPLEX
 GAMMA-IGREATER NOIDA
 CONN. +91-94-1585-6777

DESIGN BY:


Confluence
 NEW DELHI, INDIA

F-1, FIRST FLOOR, MIRA CORPORATE SUITES,
 ISHWAR NAGAR, NEW DELHI 110065


| PH. | +91-11-26925684 | ccs@confluence.com | Member of IGBC |
|--------------|-----------------|--------------------|-----------------|
| PH. | +91-11-40564768 | www.confluence.com | ISO - 9001:2000 |
| architecture | urban design | hospitality | interiors |

DRAWING NO. **S-38**

REVISION

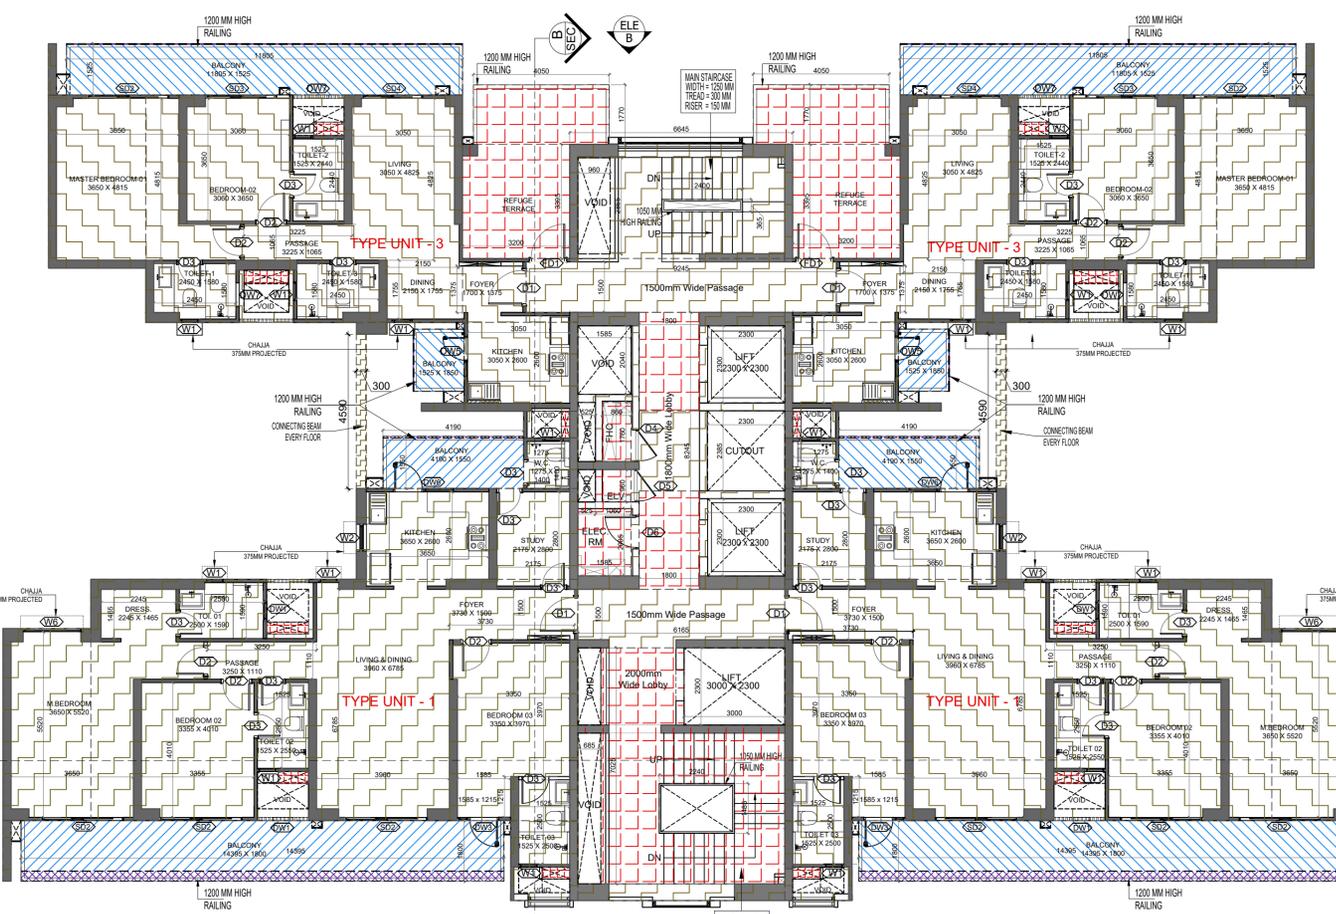

19TH FLOOR PLAN (REFUGE LVL.)

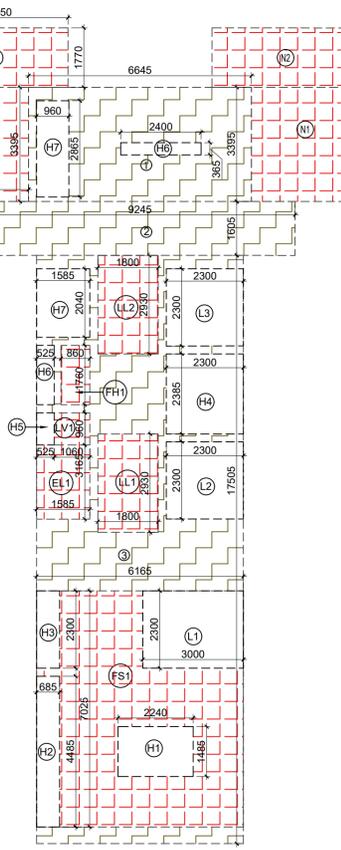

AREA DIAGRAM FOR TYPICAL FLOOR CIRCULATION AREA

F.A.R. COVERED AREA CALCULATION FOR CIRCULATION AREA

| S.NO. | PARTICULARS | AREA (SQMT) |
|---|-------------------|------------------|
| 1 | 6.645 X 3.395 | = 22.560 |
| 2 | 9.245 X 1.905 | = 14.838 |
| 3 | 6.165 X 17.505 | = 107.918 |
| TOTAL AREA (A) | | = 145.316 |
| AREA SUBTRACTION | | |
| FS1 | 6.165 X 7.025 | = 43.309 |
| LL1 | 1.800 X 2.930 | = 5.274 |
| LL2 | 1.800 X 2.930 | = 5.274 |
| LV1 | 1.060 X 0.960 | = 1.018 |
| FH1 | 0.860 X 1.760 | = 1.514 |
| EL1 | 1.585 X 2.210 | = 3.503 |
| L2 | 2.300 X 2.300 X 2 | = 10.580 |
| H4 | 2.300 X 2.385 | = 5.484 |
| H5 | 0.525 X 0.960 | = 0.504 |
| H6 | 0.525 X 1.760 | = 0.924 |
| H7 | 1.585 X 2.040 | = 3.233 |
| H8 | 2.400 X 0.385 | = 0.924 |
| H9 | 0.960 X 2.855 | = 2.741 |
| TOTAL (B) | | = 84.235 |
| TOTAL F.A.R. AREA CORRIDOR C = (A - B) | | = 61.081 |

CORRIDOR AREA CALCULATION TOWARDS 15% ADDITIONAL F.A.R.


| S.NO. | PARTICULARS | AREA (SQMT) |
|---|-------------------|----------------------------|
| FS1 | 6.165 X 7.025 | = 43.309 |
| LL1 | 1.800 X 2.930 | = 5.274 |
| LL2 | 1.800 X 2.930 | = 5.274 |
| LV1 | 1.060 X 0.960 | = 1.018 |
| F.H.C. SHAFT | FH1 | 0.860 X 1.760 = 1.514 |
| ELECTRICAL SHAFT | EL1 | 1.585 X 2.210 = 3.503 |
| REFUGE AREA | N1 | 3.300 X 3.395 X 2 = 22.176 |
| | N2 | 4.06 X 1.770 X 2 = 14.337 |
| TOTAL CORRIDOR AREA CALCULATION TOWARDS 15% ADDITIONAL F.A.R (A) | | = 95.966 |
| UNIT AREA CALCULATION TOWARDS 15% ADDITIONAL F.A.R | | |
| PLUMBING SHAFT | | |
| P1 | 0.250 X 0.800 X 2 | = 0.400 |
| P2 | 1.245 X 0.350 X 2 | = 0.872 |
| P3 | 0.900 X 0.350 X 2 | = 0.630 |
| P4 | 0.825 X 0.405 X 2 | = 0.668 |
| P5 | 1.335 X 0.400 X 2 | = 1.068 |
| P6 | 0.900 X 0.400 X 2 | = 0.720 |
| TOTAL UNIT AREA CALCULATION TOWARDS 15% ADDITIONAL F.A.R (B) | | = 4.358 |
| TOTAL 15% ADDITIONAL F.A.R. AREA (CORRIDOR AREA+UNIT AREA) = (A+B) | | = 100.314 |
| AREA SUBTRACTION | | |
| H1 | 2.240 X 1.485 | = 3.326 |
| H2 | 0.685 X 4.485 | = 3.072 |
| H3 | 0.685 X 2.300 | = 1.576 |
| L1 | 3.000 X 2.300 | = 6.900 |
| TOTAL AREA (D) | | = 14.874 |
| TOTAL 15% ADDITIONAL F.A.R. AREA E = (C - D) | | = 85.440 |

TOTAL F.A.R. AREA AT 19TH FLOOR (REFUGE LVL.)

| S.NO. | PARTICULARS | AREA (SQMT) |
|--------------------------|--------------------------------|------------------|
| 1 | F.A.R. AREA OF UNIT - 1 | 141.785 |
| 2 | F.A.R. AREA OF UNIT - 3 | 90.015 |
| 3 | F.A.R. AREA OF CIRCULATION | 61.081 |
| 4 | F.A.R. AREA OF CONNECTING BEAM | 2.754 |
| TOTAL F.A.R. AREA | | = 527.435 |

TOTAL NON-F.A.R. AREA AT 19TH FLOOR (REFUGE LVL.)

| S.NO. | PARTICULARS | AREA (SQMT) |
|---------------------------|-------------|------------------|
| 1 | UNIT - 1 | 31.274 |
| 2 | UNIT - 3 | 20.741 |
| TOTAL BALCONY AREA | | = 104.030 |

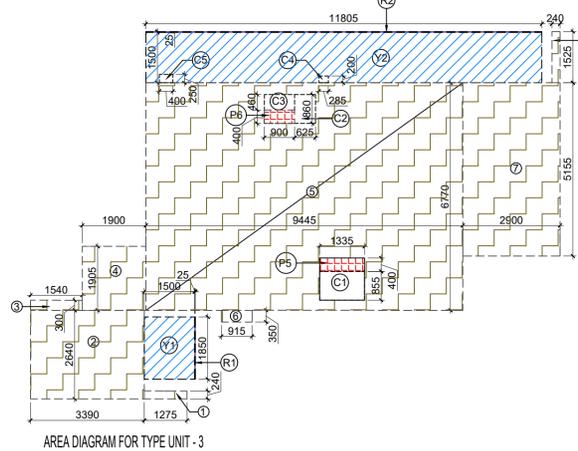


AREA DIAGRAM FOR TYPE UNIT - 3

Amit Varma
 Digitally signed by Amit Varma
 Date: 2025.01.25
 17:02:27 +05'30'

Sudheer Kumar
 Digitally signed by Sudheer Kumar
 Date: 2025.01.28
 14:20:56 +05'30'

LAL SINGH
 Digitally signed by LAL SINGH
 Date: 2025.01.27
 17:39:49
 +05'30'

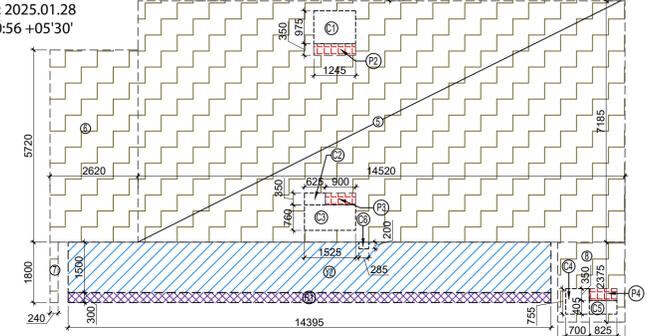

AREA DIAGRAM FOR TYPE UNIT - 1

REFUGE AREA REQUIRED -
 = 710.524 SQMTR (BLDG. PLATE) X 2 FLOORS X 0.3
 = 426.314 SQMTR (0.9 SQMTR FOR SPECIFIED)
 = 56.065 SQMTR (SAY 56.065 SQMTR)
 REFUGE AREA PROPOSED = 56.065 SQMTR

E.A.R. AREA AT CONNECTING BEAM (EVERY FLOOR)

| S.NO. | PARTICULARS | AREA (SQMT) |
|--------------------------|-------------------|----------------|
| 1 | 0.300 X 4.500 X 2 | = 2.754 |
| TOTAL F.A.R. AREA | | = 2.754 |

F.A.R. COVERED AREA CALCULATION FOR TYPE UNIT - 3

| S.NO. | PARTICULARS | AREA (SQMT) |
|---|----------------|-----------------|
| 1 | 1.275 X 0.240 | = 0.306 |
| 2 | 3.390 X 2.640 | = 8.950 |
| 3 | 1.540 X 0.300 | = 0.462 |
| 4 | 1.900 X 1.905 | = 3.620 |
| 5 | 9.445 X 6.770 | = 63.943 |
| 6 | 0.915 X 0.350 | = 0.320 |
| 7 | 2.900 X 5.155 | = 14.950 |
| 8 | 0.240 X 1.525 | = 0.366 |
| UNIT F.A.R. AREA = (A) | | = 92.916 |
| AREA SUBTRACTION PLUMBING CUTOUT | | |
| P5 | 1.335 X 0.400 | = 0.534 |
| P6 | 0.900 X 0.400 | = 0.360 |
| C1 | 1.335 X 0.855 | = 1.141 |
| C2 | 0.625 X 0.860 | = 0.538 |
| C3 | 0.900 X 0.460 | = 0.414 |
| TOTAL (B) | | = 2.987 |
| TOTAL F.A.R. AREA C = (A - B) | | = 89.929 |
| 1/4 F.A.R. AREA OF BALCONY | | |
| R1 | 0.025 X 2.000 | = 0.050 |
| R2 | 11.805 X 0.025 | = 0.295 |
| TOTAL AREA (D) | | = 0.345 |
| 1/4 BALCONY F.A.R. AREA (E) | | = 0.086 |
| TOTAL UNIT F.A.R. AREA F = (C + E) | | = 90.015 |

F.A.R. COVERED AREA CALCULATION FOR TYPE UNIT - 1

| S.NO. | PARTICULARS | AREA (SQMT) |
|---|----------------|------------------|
| 1 | 0.240 X 0.800 | = 0.192 |
| 2 | 0.240 X 0.800 | = 0.192 |
| 3 | 1.615 X 1.500 | = 2.423 |
| 4 | 6.605 X 2.700 | = 17.834 |
| 5 | 14.520 X 7.165 | = 104.326 |
| 6 | 2.620 X 5.720 | = 14.986 |
| 7 | 0.240 X 1.800 | = 0.432 |
| 8 | 2.005 X 2.375 | = 4.762 |
| UNIT F.A.R. AREA = (A) | | = 145.146 |
| AREA SUBTRACTION PLUMBING CUTOUT | | |
| P2 | 1.245 X 0.350 | = 0.436 |
| P3 | 0.900 X 0.350 | = 0.315 |
| P4 | 0.825 X 0.350 | = 0.289 |
| C1 | 1.245 X 0.975 | = 1.214 |
| C2 | 0.625 X 0.350 | = 0.219 |
| C3 | 1.525 X 0.760 | = 1.159 |
| C4 | 0.700 X 0.755 | = 0.529 |
| C5 | 0.825 X 0.405 | = 0.334 |
| TOTAL (B) | | = 4.494 |
| TOTAL F.A.R. AREA C = (A - B) | | = 140.653 |
| 1/4 F.A.R. AREA OF BALCONY | | |
| R1 | 14.395 X 0.300 | = 4.319 |
| R2 | 4.190 X 0.050 | = 0.210 |
| TOTAL AREA (D) | | = 4.528 |
| 1/4 BALCONY F.A.R. AREA (E) | | = 1.132 |
| TOTAL UNIT F.A.R. AREA F = (C + E) | | = 141.785 |

NON-F.A.R. AREA OF BALCONY

| S.NO. | PARTICULARS | AREA (SQMT) |
|--------------------------------------|----------------|-----------------|
| Y1 | 1.500 X 1.850 | = 2.775 |
| Y2 | 11.805 X 1.500 | = 17.708 |
| 3/4 AREA OF BALCONY (D - E) | | = 0.259 |
| TOTAL BALCONY AREA (G) | | = 20.741 |
| AREA SUBTRACTION | | |
| C4 | 0.285 X 0.200 | = 0.057 |
| C5 | 0.400 X 0.250 | = 0.100 |
| TOTAL (H) | | = 0.157 |
| TOTAL F.A.R. AREA J = (G - H) | | = 20.584 |

15% SERVICES AREA OF UNIT (PLUMBING SHAFT)

| S.NO. | PARTICULARS | AREA (SQMT) |
|--|-------------------------------|------------------|
| P5 | 1.335 X 0.400 | = 0.534 |
| P6 | 0.900 X 0.400 | = 0.360 |
| TOTAL 15% SERVICES AREA OF UNIT (K) | | = 0.894 |
| COVERED AREA FOR UNIT = (F + J + K) | | |
| 1 | TOTAL UNIT F.A.R. AREA (F) | = 90.015 |
| 2 | NON F.A.R. AREA OF UNIT (J) | = 20.741 |
| 3 | 15% SERVICES AREA OF UNIT (K) | = 0.894 |
| TOTAL UNIT COVERED AREA | | = 111.650 |

15% SERVICES AREA OF UNIT (PLUMBING SHAFT)

| S.NO. | PARTICULARS | AREA (SQMT) |
|--|-------------------------------|------------------|
| P1 | 0.250 X 0.800 | = 0.200 |
| P2 | 1.245 X 0.350 | = 0.436 |
| P3 | 0.900 X 0.350 | = 0.315 |
| P4 | 0.825 X 0.350 | = 0.289 |
| TOTAL 15% SERVICES AREA OF UNIT (K) | | = 1.240 |
| COVERED AREA FOR UNIT = (F + J + K) | | |
| 1 | TOTAL UNIT F.A.R. AREA (F) | = 141.785 |
| 2 | NON F.A.R. AREA OF UNIT (J) | = 31.274 |
| 3 | 15% SERVICES AREA OF UNIT (K) | = 1.240 |
| TOTAL UNIT COVERED AREA | | = 174.299 |

M.R.M & O.H.T TOP TERRACE
T.O.S. LVL.+80750 MM

MUMTY TERRACE LVL
T.O.S. LVL.+76350 MM

TERRACE
T.O.S. LVL.+73700 MM

23RD FLOOR FFL.
+70800 MM

22ND FLOOR FFL.
+67850 MM

21ST FLOOR FFL.
+64900MM

20TH FLOOR FFL.
+61950 MM

19TH FLOOR FFL.
REFUGE FLOOR
+59000 MM

18TH FLOOR FFL.
+56050 MM

17TH FLOOR FFL.
+53100 MM

16TH FLOOR FFL.
+50150 MM

15TH FLOOR FFL.
+47200 MM

14TH FLOOR FFL.
+44250 MM

13TH FLOOR FFL.
+41300 MM

12TH FLOOR FFL.
+38350 MM

11TH FLOOR FFL.
+35400 MM

10TH FLOOR FFL.
+32450 MM

9TH FLOOR FFL.
+29500 MM

8TH FLOOR FFL.
+26550 MM

7TH FLOOR FFL.
+23600 MM

6TH FLOOR FFL.
+20650 MM

5TH FLOOR FFL.
+17700 MM

4TH FLOOR FFL.
+14750 MM

3RD FLOOR FFL.
+11800 MM

2ND FLOOR FFL.
+8850 MM

1ST FLOOR FFL.
+5900 MM

PODIUM SLAB
F.F.L.+4400 MM

TOWER LOBBY FL.
+900 MM

STILT FLOOR FFL.(PARKING)
+750 MM

EXT. ROAD LVL
F.L.± 00 MM

INT ROAD LVL
F.L.+ 600 MM

BASEMENT FFL.(PARKING)
F.L.-5000 MM

LAL SINGH

Digitally signed
by LAL SINGH
Date:
2025.01.27
17:48:18
+05'30'

Sudheer Kumar

Digitally signed by Sudheer
Kumar
Date: 2025.01.28 14:23:56
+05'30'

Amit Varma

Digitally signed
by Amit Varma
Date: 2025.01.25
17:05:24 +05'30'

OHT BEHIND


TOWER CROWN
BEHIND


150 mm high
slab

150 mm high
slab



SECTION - BB'

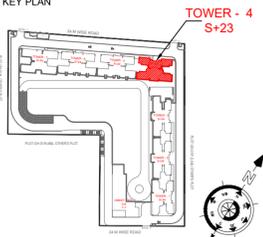
| | | | |
|---|-------------------------------|--|--|
| OWNER SIGN Rajat pathak Rajat pathak 2025.01.23 12:33:57 +05'30' | | ARCHITECT SIGN AVANISH SRIVASTAV AVANISH SRIVASTAV 2025.01.23 12:34:11 +05'30' | |
| TOWN PLANNER SIGN | | | |
| OWNER GODREJ PROPERTIES LIMITED | | | |
| SUBMISSION DRAWING | | | |
| KEY PLAN  | | | |
| PROJECT PROPOSED GROUP HOUSING FOR PLOT NO :- GH-01/B,C,D,E,J & K SECTOR -12, GREATER NOIDA, G.B. NAGAR, (U.P.) | | | |
| DATE 08 - 01 -2025 | PROJECT INCH. BALRAJ SINGH | CHECKED BY BALRAJ SINGH | |
| SCALE 1:100 | DEALT BY ABDHESH JHA | APPROVED BY VISHAL SHARMA | |
| DRAWING TITLE SECTION - B-B' | | | |
| TOWER - 4 | | | |
| ARCHITECTS  GOLDEN INDIA ARCHITECTS THE TEAM OF ARCHITECTS FF-37, KADAMBA SHOPPING COMPLEX GAMMA-IGREATER NOIDA CON...+ 91-94-1585-6777 | | | |
| DESIGN BY: Confluence NEW DELHI, INDIA F-1, FIRST FLOOR, MIRA CORPORATE SUITES, ISHWAR NAGAR, NEW DELHI 110055 Ph: +91-11-26925684 ccs@confluence.com Member of IGBC Ph: +91-11-40564766 www.confluence.com ISO - 9001 : 2000 architecture urban design hospitality interiors | | | |
| DRAWING NO. S-43 | | REVISION | |

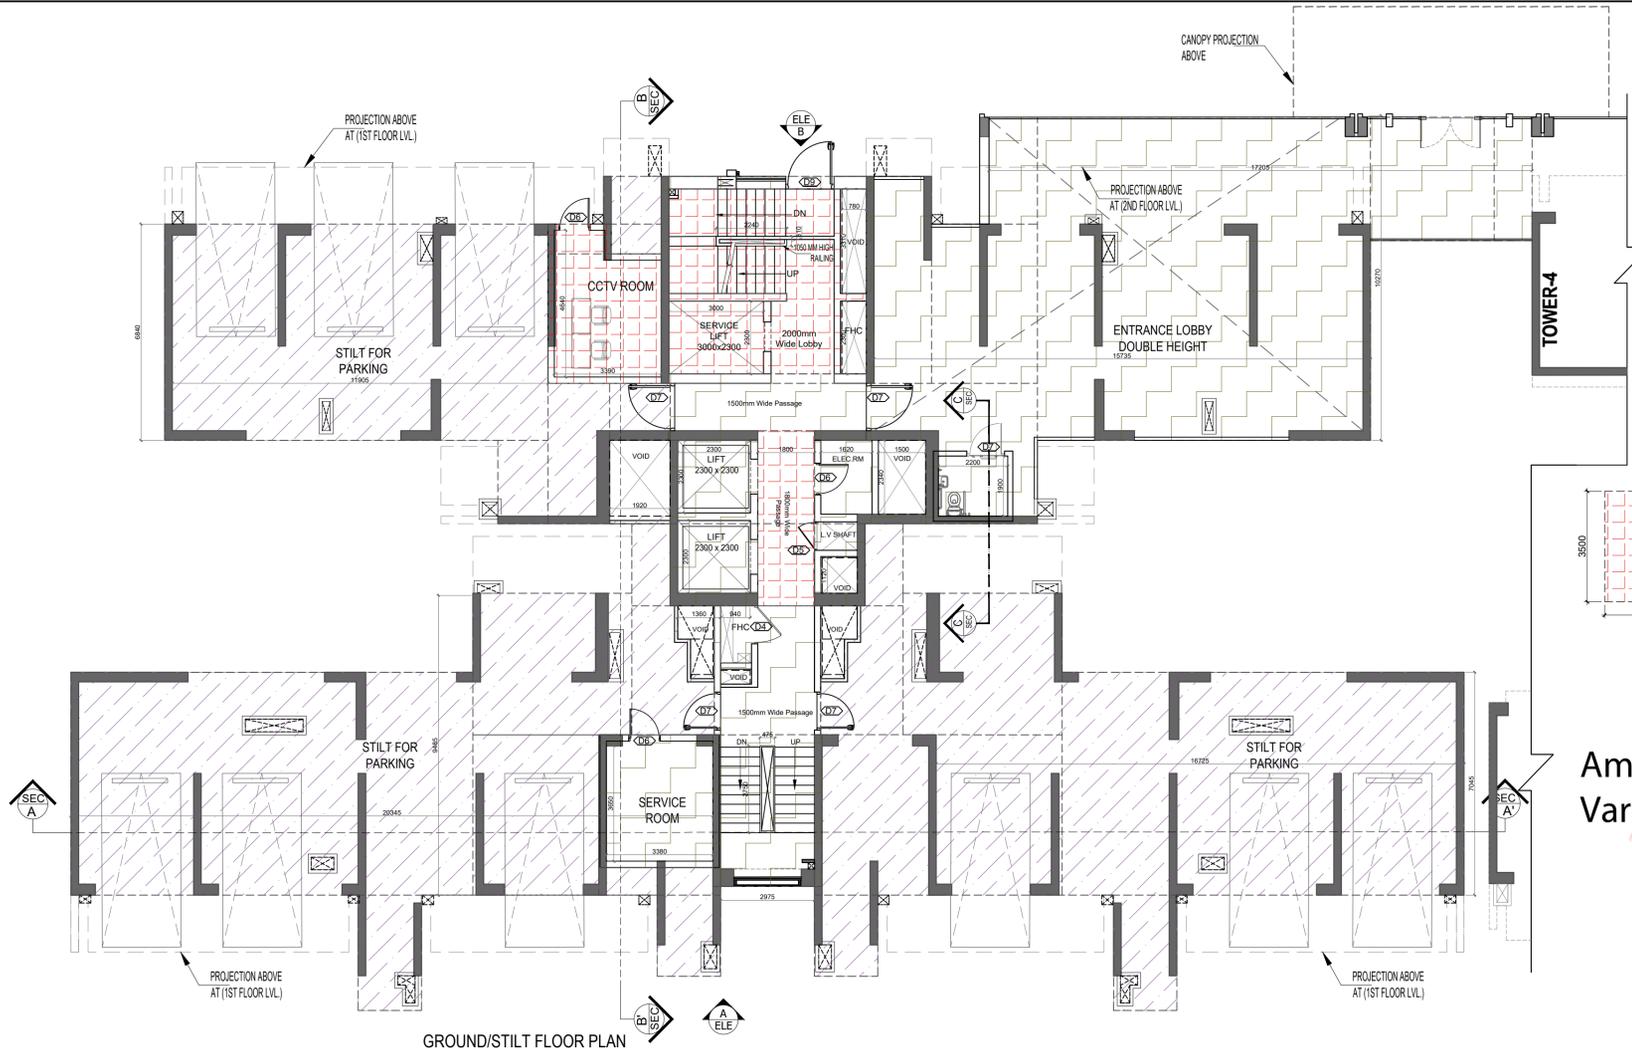

Sudheer Kumar
Digitally signed by Sudheer Kumar
Date: 2025.01.28
14:25:22 +05'30'

LAL SINGH
Digitally signed by LAL SINGH
Date: 2025.01.27
17:48:53 +05'30'

Amit Varma
Digitally signed by Amit Varma
Date: 2025.01.25
17:07:07 +05'30'

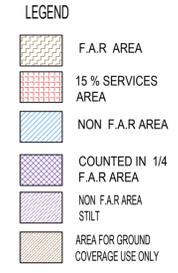

| F.A.R. COVERED AREA CALCULATION FOR CIRCULATION AREA AT GROUND FLOOR / STILT LOBBY | | | | | |
|--|--------|---|--------|--|----------------|
| S.NO. | | | | | AREA (SQMT) |
| 1 | 3.455 | X | 4.795 | | = 16.567 |
| 2 | 3.620 | X | 4.200 | | = 15.204 |
| 3 | 3.375 | X | 4.080 | | = 13.770 |
| 4 | 6.180 | X | 2.830 | | = 17.698 |
| 5 | 11.645 | X | 4.440 | | = 51.704 |
| 6 | 8.555 | X | 6.550 | | = 56.101 |
| 7 | 3.355 | X | 5.040 | | = 16.909 |
| 8 | 1.830 | X | 3.380 | | = 6.185 |
| 9 | 10.555 | X | 10.220 | | = 107.872 |
| 10 | 3.920 | X | 3.900 | | = 15.288 |
| 11 | 1.200 | X | 3.900 | | = 4.680 |
| TOTAL F.A.R AREA (A) | | | | | 320.348 |

| AREA SUBTRACTION | | | | | |
|--|-------|---|-------|--|----------------|
| S.NO. | | | | | AREA (SQMT) |
| FS1 | 6.260 | X | 5.850 | | = 36.621 |
| LL1 | 1.800 | X | 5.540 | | = 9.972 |
| H3 | 1.500 | X | 2.340 | | = 3.510 |
| H4 | 1.120 | X | 1.120 | | = 1.254 |
| H5 | 0.940 | X | 0.435 | | = 0.409 |
| TOTAL (B) | | | | | 51.766 |
| TOTAL F.A.R AREA CORRIDOR C = (A - B) | | | | | 268.582 |

| AREA CALCULATION TOWARDS 15% ADDITIONAL F.A.R AT GROUND FLOOR / STILT LOBBY | | | | | |
|---|--------|---|-------|--|---------------|
| S.NO. | | | | | AREA (SQMT) |
| FIRE TOWER AREA | | | | | |
| FS1 | 6.260 | X | 5.850 | | = 36.621 |
| LIFT LOBBY | | | | | |
| LL1 | 1.800 | X | 5.540 | | = 9.972 |
| CCTV ROOM | | | | | |
| F1 | 3.590 | X | 4.100 | | = 14.718 |
| F2 | 2.005 | X | 0.940 | | = 1.885 |
| CANOPY AREA | | | | | |
| C1 | 10.000 | X | 3.500 | | = 35.000 |
| TOTAL AREA (D) | | | | | 98.197 |
| AREA SUBTRACTION | | | | | |
| H1 | 0.780 | X | 3.310 | | = 2.582 |
| H2 | 0.780 | X | 2.300 | | = 1.794 |
| TOTAL (E) | | | | | 4.376 |
| TOTAL 15% F.A.R AREA F = (D - E) | | | | | 93.821 |

| NON F.A.R. AREA CALCULATION FOR GROUND FLOOR / STILT AREA | | | | | |
|---|--------|---|-------|---|----------------|
| S.NO. | | | | | AREA (SQMT) |
| S1 | 2.005 | X | 3.650 | X | 2 = 14.637 |
| S2 | 2.005 | X | 2.570 | X | 2 = 10.306 |
| S3 | 0.240 | X | 0.275 | X | 2 = 0.132 |
| S4 | 3.620 | X | 0.875 | | = 3.168 |
| S5 | 3.990 | X | 5.075 | | = 20.249 |
| S6 | 12.735 | X | 7.050 | X | 2 = 179.564 |
| S7 | 5.040 | X | 4.475 | X | 2 = 45.108 |
| S8 | 2.610 | X | 4.080 | X | 2 = 21.298 |
| S9 | 1.210 | X | 2.600 | X | 2 = 6.292 |
| S10 | 1.920 | X | 0.240 | | = 0.461 |
| S11 | 1.950 | X | 4.440 | | = 8.658 |
| S12 | 1.920 | X | 1.800 | | = 3.456 |
| S13 | 1.590 | X | 2.640 | | = 4.198 |
| S14 | 12.145 | X | 6.840 | | = 83.072 |
| S15 | 1.585 | X | 0.940 | | = 1.490 |
| S16 | 1.825 | X | 1.510 | | = 2.756 |
| S17 | 7.610 | X | 5.075 | | = 38.621 |
| TOTAL AREA (G) | | | | | 443.463 |
| AREA SUBTRACTION | | | | | |
| H6 | 1.120 | X | 1.050 | X | 2 = 2.352 |
| H7 | 0.705 | X | 1.120 | X | 2 = 1.578 |
| TOTAL AREA (H) | | | | | 3.931 |
| TOTAL NON F.A.R AREA STILT PARKING J = (G - H) | | | | | 439.531 |

| TOTAL F.A.R. AREA AT GROUND FLOOR / STILT LVL. | | | |
|---|---|--|----------------|
| S.NO. | | | AREA (SQMT) |
| F.A.R AREA OF CIRCULATION & ENTRANCE LOBBY | | | |
| 1 | X | | = 268.582 |
| TOTAL F.A.R AREA | | | 268.582 |

| | TOWER - 5 | | | |
|--------------------------------|-----------------|------------------|-----------------|--------------------------------|
| | GROUND COVERAGE | F.A.R. AREA | 15% AREA | STILT NON F.A.R AREA (PARKING) |
| GROUND / STILT FLOOR (F.A.R) | 815.247 | 268.582 | 93.821 | 439.531 |
| 1ST / PODIUM FLOOR AREA | | 512.518 | 45.369 | 92.504 |
| 2nd FLOOR AREA | | 630.130 | 46.129 | 120.441 |
| 3rd FLOOR AREA | | 630.130 | 46.129 | 120.441 |
| 4th FLOOR AREA | | 630.130 | 46.129 | 120.441 |
| 5th FLOOR AREA | | 630.130 | 46.129 | 120.441 |
| 6th FLOOR AREA | | 630.130 | 46.129 | 120.441 |
| 7th FLOOR AREA | | 630.130 | 46.129 | 120.441 |
| 8th FLOOR AREA | | 630.130 | 46.129 | 120.441 |
| 9th FLOOR AREA | | 630.130 | 46.129 | 120.441 |
| 10th FLOOR AREA | | 630.130 | 46.129 | 120.441 |
| 11th FLOOR AREA | | 630.130 | 46.129 | 120.441 |
| 12th FLOOR AREA | | 630.130 | 46.129 | 120.441 |
| 13th FLOOR AREA | | 630.130 | 46.129 | 120.441 |
| 14th FLOOR AREA | | 630.130 | 46.129 | 120.441 |
| 15th FLOOR AREA | | 630.130 | 46.129 | 120.441 |
| 16th FLOOR AREA | | 630.130 | 46.129 | 120.441 |
| 17th FLOOR AREA | | 630.130 | 46.129 | 120.441 |
| 18th FLOOR AREA | | 630.130 | 46.129 | 120.441 |
| 19th FLOOR AREA | | 630.130 | 46.129 | 120.441 |
| 20th FLOOR AREA (REFUGE FLOOR) | | 592.541 | 89.863 | 115.387 |
| 20th FLOOR AREA | | 630.130 | 46.129 | 120.441 |
| 21st FLOOR AREA | | 630.130 | 46.129 | 120.441 |
| 22nd FLOOR AREA | | 630.130 | 46.129 | 120.441 |
| 23rd FLOOR AREA | | 630.130 | 46.129 | 120.441 |
| 24th FLOOR AREA | | 630.130 | 46.129 | 120.441 |
| TERRACE FLOOR | | 28.375 | 96.517 | |
| MACHINE ROOM LVL. | | | 58.410 | |
| D.H TANK LVL. | | | 22.560 | |
| TOTAL | 815.247 | 15264.871 | 1441.374 | 439.531 |

OWNER SIGN
Rajat pathak
2025.01.23
12:34:53
+05'30'

ARCHITECT SIGN
AVANIS SRIVASTAV
2025.01.23
12:35:01
+05'30'

DOOR SCHEDULE


| S.NO. | TYPE | ORIGIN | HEIGHT | SW. | LOC. | DESCRIPTION |
|-------|------|--------|--------|------|----------|---|
| 1 | DOOR | 2000 | 2000 | 2000 | ALUMINUM | ALUMINUM UPVC FRAME OPERABLE DOOR-OPENING LIFTED WINDOW |
| 2 | DOOR | 2000 | 2000 | 2000 | ALUMINUM | ALUMINUM UPVC FRAME OPERABLE DOOR-OPENING LIFTED WINDOW |
| 3 | DOOR | 2000 | 2000 | 2000 | ALUMINUM | ALUMINUM UPVC FRAME OPERABLE DOOR-OPENING LIFTED WINDOW |
| 4 | DOOR | 2000 | 2000 | 2000 | ALUMINUM | ALUMINUM UPVC FRAME OPERABLE DOOR-OPENING LIFTED WINDOW |
| 5 | DOOR | 2000 | 2000 | 2000 | ALUMINUM | ALUMINUM UPVC FRAME OPERABLE DOOR-OPENING LIFTED WINDOW |
| 6 | DOOR | 2000 | 2000 | 2000 | ALUMINUM | ALUMINUM UPVC FRAME OPERABLE DOOR-OPENING LIFTED WINDOW |
| 7 | DOOR | 2000 | 2000 | 2000 | ALUMINUM | ALUMINUM UPVC FRAME OPERABLE DOOR-OPENING LIFTED WINDOW |
| 8 | DOOR | 2000 | 2000 | 2000 | ALUMINUM | ALUMINUM UPVC FRAME OPERABLE DOOR-OPENING LIFTED WINDOW |
| 9 | DOOR | 2000 | 2000 | 2000 | ALUMINUM | ALUMINUM UPVC FRAME OPERABLE DOOR-OPENING LIFTED WINDOW |
| 10 | DOOR | 2000 | 2000 | 2000 | ALUMINUM | ALUMINUM UPVC FRAME OPERABLE DOOR-OPENING LIFTED WINDOW |
| 11 | DOOR | 2000 | 2000 | 2000 | ALUMINUM | ALUMINUM UPVC FRAME OPERABLE DOOR-OPENING LIFTED WINDOW |
| 12 | DOOR | 2000 | 2000 | 2000 | ALUMINUM | ALUMINUM UPVC FRAME OPERABLE DOOR-OPENING LIFTED WINDOW |
| 13 | DOOR | 2000 | 2000 | 2000 | ALUMINUM | ALUMINUM UPVC FRAME OPERABLE DOOR-OPENING LIFTED WINDOW |
| 14 | DOOR | 2000 | 2000 | 2000 | ALUMINUM | ALUMINUM UPVC FRAME OPERABLE DOOR-OPENING LIFTED WINDOW |
| 15 | DOOR | 2000 | 2000 | 2000 | ALUMINUM | ALUMINUM UPVC FRAME OPERABLE DOOR-OPENING LIFTED WINDOW |
| 16 | DOOR | 2000 | 2000 | 2000 | ALUMINUM | ALUMINUM UPVC FRAME OPERABLE DOOR-OPENING LIFTED WINDOW |
| 17 | DOOR | 2000 | 2000 | 2000 | ALUMINUM | ALUMINUM UPVC FRAME OPERABLE DOOR-OPENING LIFTED WINDOW |
| 18 | DOOR | 2000 | 2000 | 2000 | ALUMINUM | ALUMINUM UPVC FRAME OPERABLE DOOR-OPENING LIFTED WINDOW |
| 19 | DOOR | 2000 | 2000 | 2000 | ALUMINUM | ALUMINUM UPVC FRAME OPERABLE DOOR-OPENING LIFTED WINDOW |
| 20 | DOOR | 2000 | 2000 | 2000 | ALUMINUM | ALUMINUM UPVC FRAME OPERABLE DOOR-OPENING LIFTED WINDOW |

WINDOW SCHEDULE

| S.NO. | TYPE | ORIGIN | HEIGHT | SW. | LOC. | DESCRIPTION |
|-------|--------|--------|--------|------|----------|---|
| 1 | WINDOW | 1000 | 1000 | 1000 | ALUMINUM | ALUMINUM UPVC FRAME OPERABLE WINDOW-OPENING LIFTED WINDOW |
| 2 | WINDOW | 1000 | 1000 | 1000 | ALUMINUM | ALUMINUM UPVC FRAME OPERABLE WINDOW-OPENING LIFTED WINDOW |
| 3 | WINDOW | 1000 | 1000 | 1000 | ALUMINUM | ALUMINUM UPVC FRAME OPERABLE WINDOW-OPENING LIFTED WINDOW |
| 4 | WINDOW | 1000 | 1000 | 1000 | ALUMINUM | ALUMINUM UPVC FRAME OPERABLE WINDOW-OPENING LIFTED WINDOW |
| 5 | WINDOW | 1000 | 1000 | 1000 | ALUMINUM | ALUMINUM UPVC FRAME OPERABLE WINDOW-OPENING LIFTED WINDOW |
| 6 | WINDOW | 1000 | 1000 | 1000 | ALUMINUM | ALUMINUM UPVC FRAME OPERABLE WINDOW-OPENING LIFTED WINDOW |
| 7 | WINDOW | 1000 | 1000 | 1000 | ALUMINUM | ALUMINUM UPVC FRAME OPERABLE WINDOW-OPENING LIFTED WINDOW |
| 8 | WINDOW | 1000 | 1000 | 1000 | ALUMINUM | ALUMINUM UPVC FRAME OPERABLE WINDOW-OPENING LIFTED WINDOW |
| 9 | WINDOW | 1000 | 1000 | 1000 | ALUMINUM | ALUMINUM UPVC FRAME OPERABLE WINDOW-OPENING LIFTED WINDOW |
| 10 | WINDOW | 1000 | 1000 | 1000 | ALUMINUM | ALUMINUM UPVC FRAME OPERABLE WINDOW-OPENING LIFTED WINDOW |
| 11 | WINDOW | 1000 | 1000 | 1000 | ALUMINUM | ALUMINUM UPVC FRAME OPERABLE WINDOW-OPENING LIFTED WINDOW |
| 12 | WINDOW | 1000 | 1000 | 1000 | ALUMINUM | ALUMINUM UPVC FRAME OPERABLE WINDOW-OPENING LIFTED WINDOW |
| 13 | WINDOW | 1000 | 1000 | 1000 | ALUMINUM | ALUMINUM UPVC FRAME OPERABLE WINDOW-OPENING LIFTED WINDOW |
| 14 | WINDOW | 1000 | 1000 | 1000 | ALUMINUM | ALUMINUM UPVC FRAME OPERABLE WINDOW-OPENING LIFTED WINDOW |
| 15 | WINDOW | 1000 | 1000 | 1000 | ALUMINUM | ALUMINUM UPVC FRAME OPERABLE WINDOW-OPENING LIFTED WINDOW |
| 16 | WINDOW | 1000 | 1000 | 1000 | ALUMINUM | ALUMINUM UPVC FRAME OPERABLE WINDOW-OPENING LIFTED WINDOW |
| 17 | WINDOW | 1000 | 1000 | 1000 | ALUMINUM | ALUMINUM UPVC FRAME OPERABLE WINDOW-OPENING LIFTED WINDOW |
| 18 | WINDOW | 1000 | 1000 | 1000 | ALUMINUM | ALUMINUM UPVC FRAME OPERABLE WINDOW-OPENING LIFTED WINDOW |
| 19 | WINDOW | 1000 | 1000 | 1000 | ALUMINUM | ALUMINUM UPVC FRAME OPERABLE WINDOW-OPENING LIFTED WINDOW |
| 20 | WINDOW | 1000 | 1000 | 1000 | ALUMINUM | ALUMINUM UPVC FRAME OPERABLE WINDOW-OPENING LIFTED WINDOW |

OWNER
GODREJ PROPERTIES LIMITED

SUBMISSION DRAWING

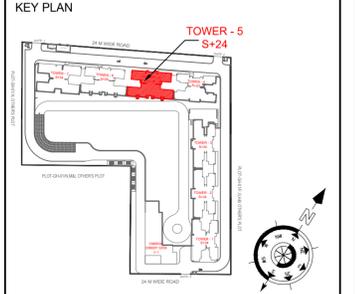

PROJECT
PROPOSED GROUP HOUSING FOR PLOT NO :- GH-01/B,C,D,E,J & K SECTOR -12, GREATER NOIDA, G.B. NAGAR, (U.P.)

| | | |
|------------------------------|--------------------------------------|-------------------------------------|
| DATE 08 - 01 -2025 | PROJECT INCH. BALRAJ SINGH | CHECKED BY BALRAJ SINGH |
| SCALE 1:100 | DEALT BY ABDRESH JHA | APPROVED BY VISHAL SHARMA |

DRAWING TITLE
GROUND/STILT FLOOR PLAN

TOWER - 5


ARCHITECTS
GOLDEN INDIA ARCHITECTS
THE TEAM OF ARCHITECTS
FF-37, KADAMBA SHOPPING COMPLEX
GAMMA-IGREATER NOIDA
CON. +91-94-1585-6777

DESIGN BY:
Confluence
NEW DELHI, INDIA


F-1, FIRST FLOOR, MIRA CORPORATE SUITES,
ISHWAR NAGAR, NEW DELHI 110065

Ph- +91-11-28925684 ccs@inconflience.com Member of IGBC
Ph- +91-11-40564768 www.inconflience.com ISO - 9001:2000
architecture urban design hospitality interiors

DRAWING NO. S-45 **REVISION**

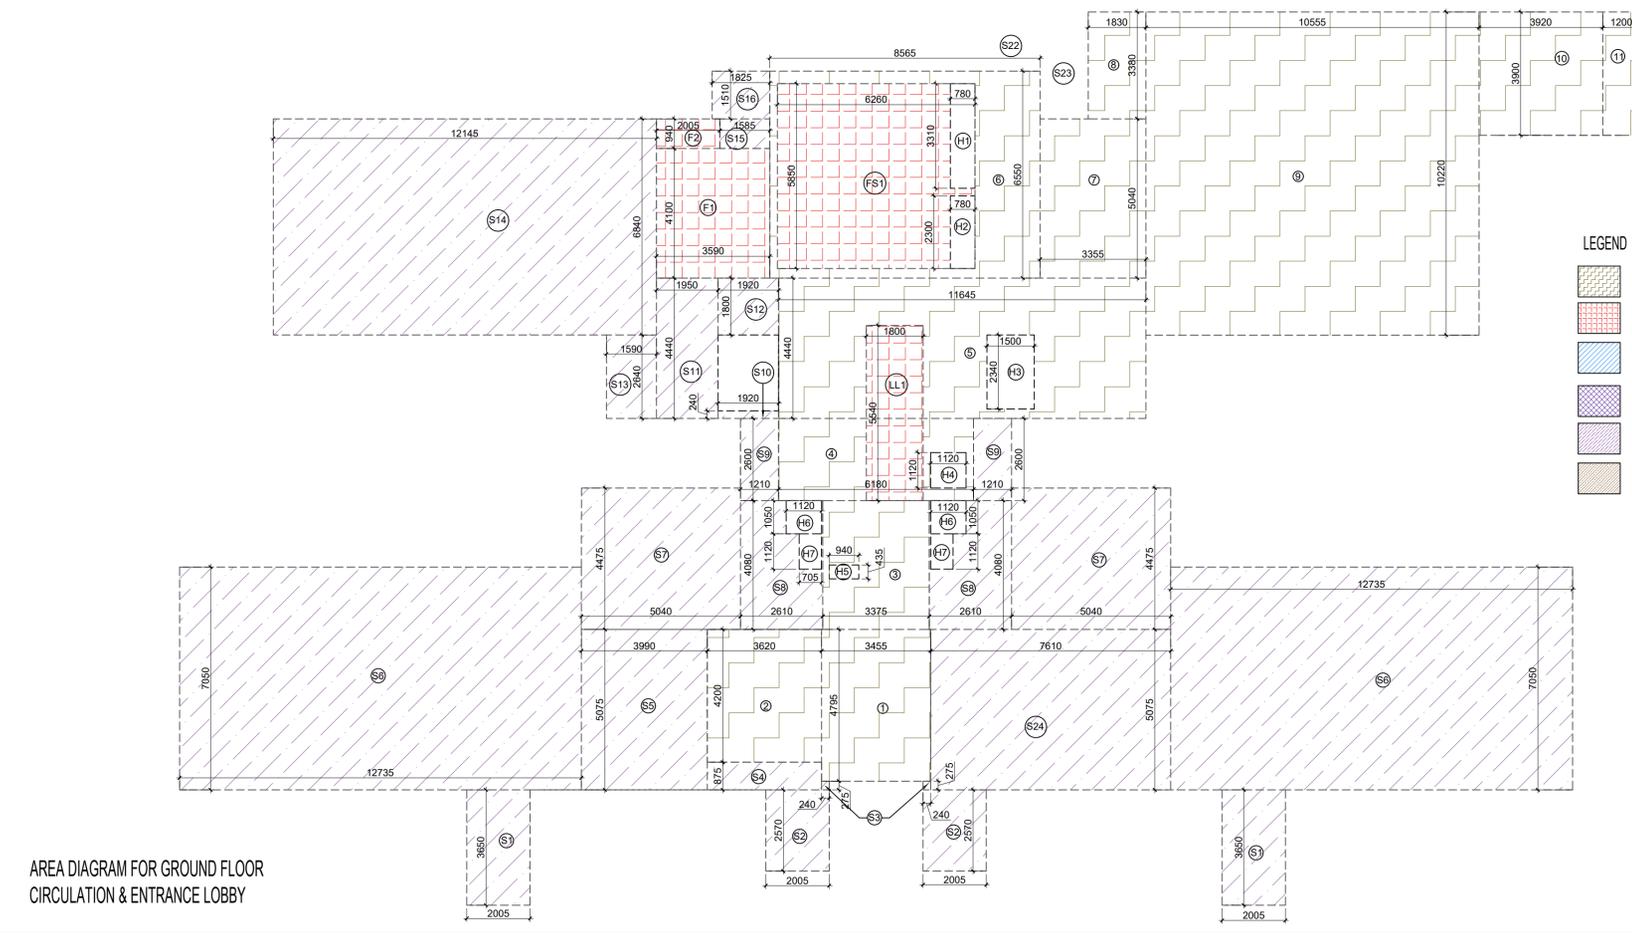



AREA DIAGRAM FOR GROUND FLOOR CIRCULATION & ENTRANCE LOBBY

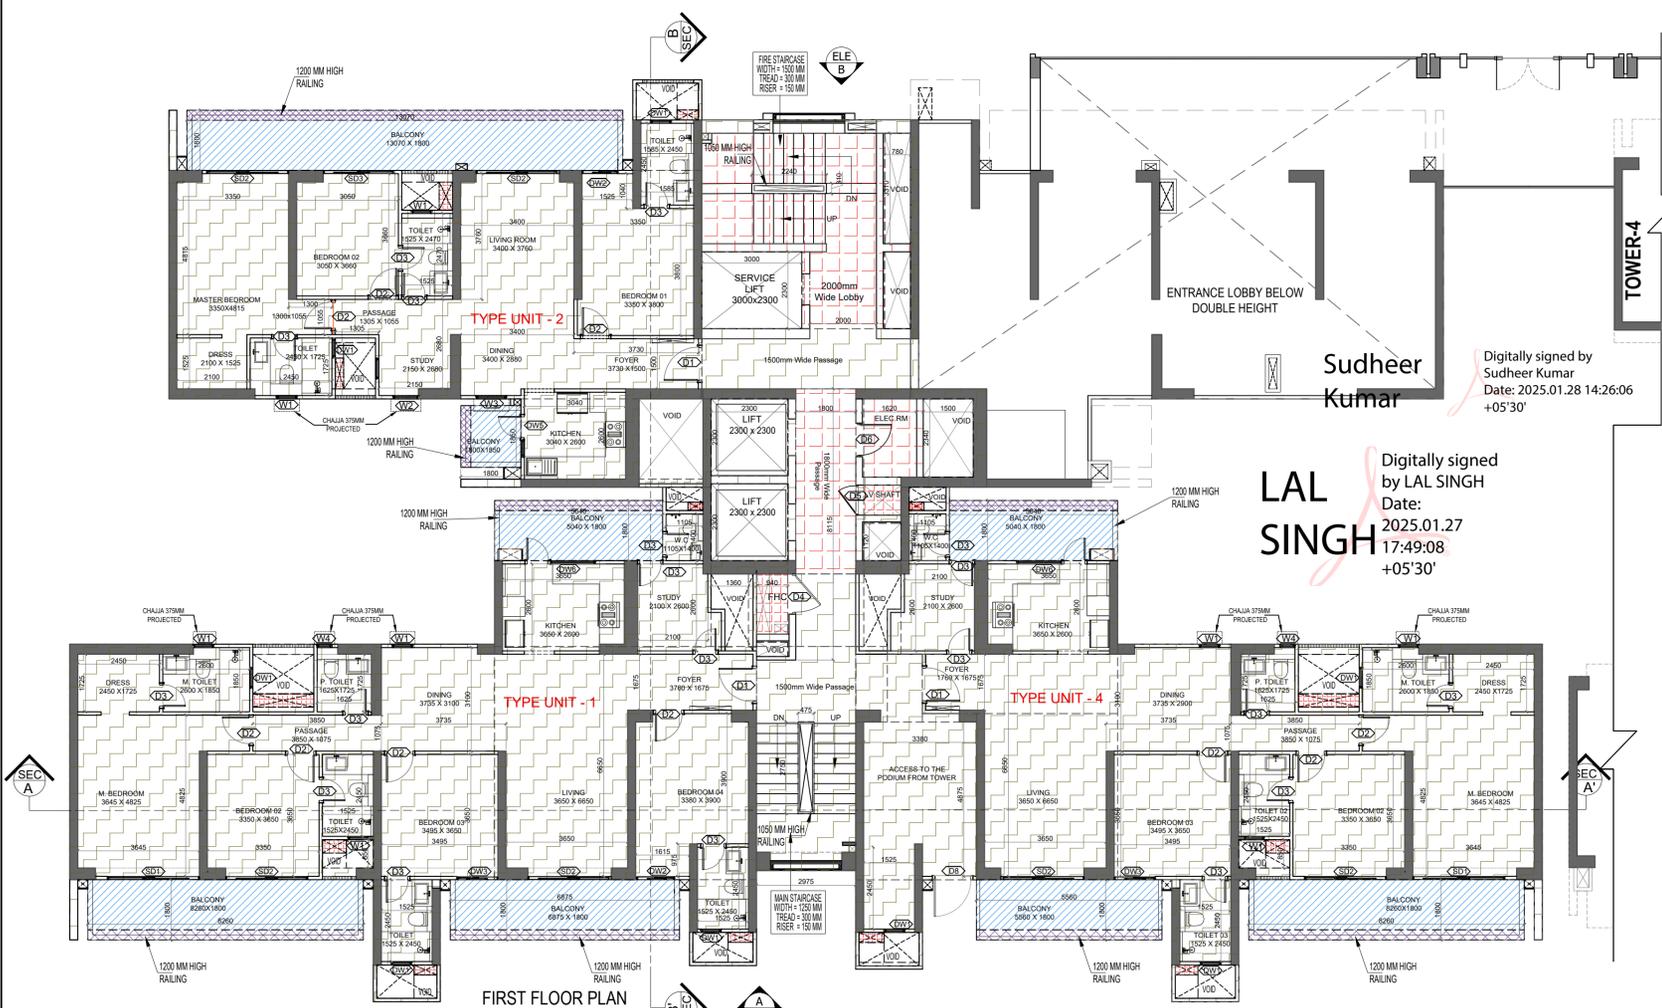

Amit Varma
Digitally signed by Amit Varma
Date: 2025.01.25 17:08:06 +05'30'


Sudheer Kumar
Digitally signed by Sudheer Kumar
Date: 2025.01.28 14:26:05 +05'30'

LAL SINGH
Digitally signed by LAL SINGH
Date: 2025.01.27 17:49:08 +05'30'

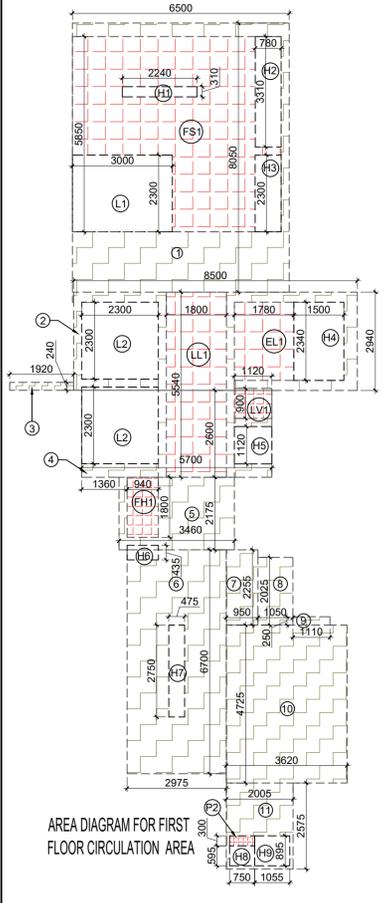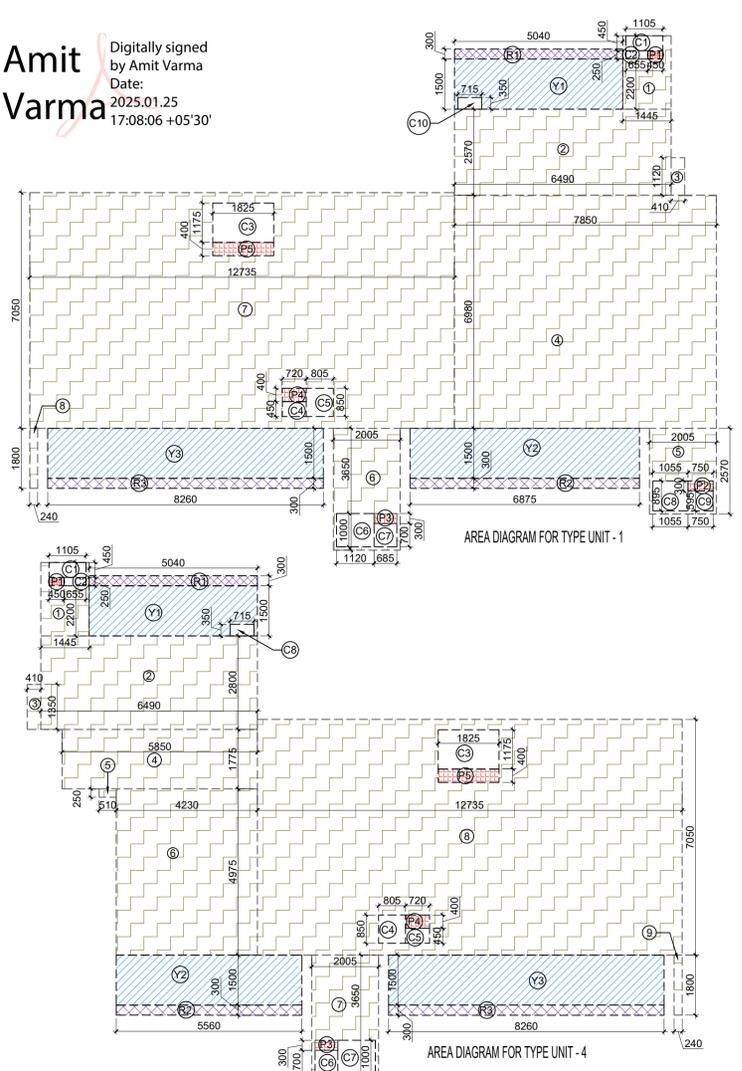

| S.NO. | PARTICULARS | AREA (SQM) |
|-----------------------|---------------|----------------|
| 1 | 6.500 X 8.000 | 52.000 |
| 2 | 8.500 X 2.340 | 19.890 |
| 3 | 1.500 X 0.240 | 0.360 |
| 4 | 5.700 X 2.600 | 14.820 |
| 5 | 3.400 X 2.175 | 7.398 |
| 6 | 2.975 X 6.700 | 19.933 |
| 7 | 0.950 X 2.255 | 2.142 |
| 8 | 1.050 X 2.025 | 2.126 |
| 9 | 1.110 X 0.250 | 0.278 |
| 10 | 0.500 X 4.125 | 2.063 |
| 11 | 2.005 X 2.575 | 5.165 |
| TOTAL AREA (A) | | 148.867 |

| S.NO. | PARTICULARS | AREA (SQM) |
|--|-------------|----------------|
| 1 | 170.944 | 170.944 |
| 1 | 121.183 | 121.183 |
| 1 | 145.657 | 145.657 |
| 1 | 74.734 | 74.734 |
| TOTAL F.A.R. AREA AT FIRST FLOOR/PODIUM | | 512.518 |

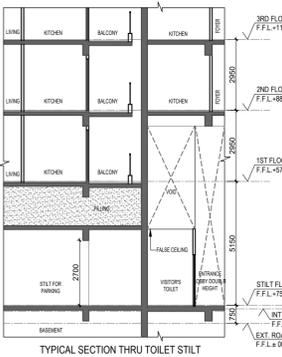


| S.NO. | PARTICULARS | AREA (SQM) |
|-------------------------------|----------------|----------------|
| 1 | 1.440 X 2.200 | 3.170 |
| 2 | 0.450 X 2.570 | 1.163 |
| 3 | 0.410 X 1.120 | 0.459 |
| 4 | 7.850 X 0.580 | 4.543 |
| 5 | 2.005 X 2.570 | 5.153 |
| 6 | 2.000 X 3.600 | 7.200 |
| 7 | 12.735 X 7.050 | 89.782 |
| 8 | 0.240 X 1.800 | 0.432 |
| UNIT F.A.R. AREA = (A) | | 117.795 |

| S.NO. | PARTICULARS | AREA (SQM) |
|--------------------------------------|---------------|----------------|
| 1 | 1.800 X 0.240 | 0.432 |
| 2 | 0.450 X 0.300 | 0.135 |
| 3 | 0.685 X 0.300 | 0.206 |
| 4 | 0.720 X 0.400 | 0.288 |
| 5 | 1.825 X 0.400 | 0.730 |
| 6 | 1.105 X 0.450 | 0.497 |
| 7 | 0.650 X 0.250 | 0.163 |
| 8 | 1.825 X 1.175 | 2.144 |
| 9 | 0.720 X 0.450 | 0.324 |
| 10 | 0.805 X 0.850 | 0.684 |
| 11 | 0.400 X 1.600 | 0.640 |
| 12 | 0.685 X 0.700 | 0.480 |
| 13 | 1.055 X 0.855 | 0.904 |
| 14 | 0.750 X 0.555 | 0.416 |
| TOTAL (B) | | 8.365 |
| TOTAL F.A.R. AREA C = (A - B) | | 169.431 |

| S.NO. | PARTICULARS | AREA (SQM) |
|-------------------------------|----------------|----------------|
| 1 | 1.440 X 2.200 | 3.170 |
| 2 | 0.450 X 2.570 | 1.163 |
| 3 | 0.410 X 1.120 | 0.459 |
| 4 | 7.850 X 0.580 | 4.543 |
| 5 | 2.005 X 2.570 | 5.153 |
| 6 | 2.000 X 3.600 | 7.200 |
| 7 | 12.735 X 7.050 | 89.782 |
| 8 | 0.240 X 1.800 | 0.432 |
| UNIT F.A.R. AREA = (A) | | 117.795 |

| S.NO. | PARTICULARS | AREA (SQM) |
|---|---------------|---------------|
| FS1 | 6.250 X 5.850 | 36.621 |
| LL1 | 1.800 X 5.540 | 9.972 |
| LV1 | 1.120 X 0.900 | 1.008 |
| PH1 | 0.940 X 1.800 | 1.692 |
| L2 | 2.300 X 2.300 | 5.290 |
| H4 | 1.500 X 2.340 | 3.510 |
| H5 | 1.120 X 1.120 | 1.254 |
| H6 | 0.940 X 0.435 | 0.409 |
| H7 | 0.475 X 2.750 | 1.306 |
| H8 | 0.780 X 0.056 | 0.044 |
| H9 | 1.055 X 0.855 | 0.904 |
| P2 | 0.750 X 0.300 | 0.225 |
| TOTAL (B) | | 72.133 |
| TOTAL F.A.R. AREA CORRIDOR C = (A - B) | | 74.734 |

| S.NO. | PARTICULARS | AREA (SQM) |
|---------------------------|-------------|---------------|
| UNIT -1 | 34.552 | 34.552 |
| UNIT -2 | 25.669 | 25.669 |
| UNIT -4 | 32.283 | 32.283 |
| TOTAL BALCONY AREA | | 92.504 |

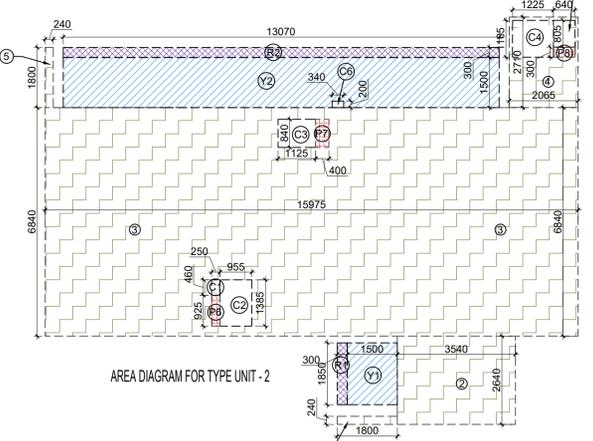

| S.NO. | PARTICULARS | AREA (SQM) |
|------------------------------------|---------------|---------------|
| Y1 | 0.940 X 1.500 | 1.410 |
| Y2 | 0.875 X 1.550 | 1.356 |
| Y3 | 0.290 X 1.500 | 0.435 |
| 3/4 AREA OF BALCONY (D - E) | | 3.201 |
| TOTAL AREA (G) | | 34.802 |

| S.NO. | PARTICULARS | AREA (SQM) |
|--------------------------------------|---------------|----------------|
| 1 | 1.800 X 0.240 | 0.432 |
| 2 | 0.450 X 0.300 | 0.135 |
| 3 | 0.685 X 0.300 | 0.206 |
| 4 | 0.720 X 0.400 | 0.288 |
| 5 | 1.825 X 0.400 | 0.730 |
| 6 | 1.105 X 0.450 | 0.497 |
| 7 | 0.650 X 0.250 | 0.163 |
| 8 | 1.825 X 1.175 | 2.144 |
| 9 | 0.720 X 0.450 | 0.324 |
| 10 | 0.805 X 0.850 | 0.684 |
| 11 | 0.400 X 1.600 | 0.640 |
| 12 | 0.685 X 0.700 | 0.480 |
| 13 | 1.055 X 0.855 | 0.904 |
| 14 | 0.750 X 0.555 | 0.416 |
| TOTAL (B) | | 8.365 |
| TOTAL F.A.R. AREA C = (A - B) | | 169.431 |


| S.NO. | PARTICULARS | AREA (SQM) |
|-------------------------------|----------------|----------------|
| 1 | 1.440 X 2.200 | 3.170 |
| 2 | 0.450 X 2.570 | 1.163 |
| 3 | 0.410 X 1.120 | 0.459 |
| 4 | 7.850 X 0.580 | 4.543 |
| 5 | 2.005 X 2.570 | 5.153 |
| 6 | 2.000 X 3.600 | 7.200 |
| 7 | 12.735 X 7.050 | 89.782 |
| 8 | 0.240 X 1.800 | 0.432 |
| UNIT F.A.R. AREA = (A) | | 117.795 |

| SL. NO. | TYPE | HEIGHT | LEVEL | LOCATION | DESCRIPTION |
|---------|-------|--------|-------|----------|-----------------------|
| 1 | GLASS | 2000 | 2000 | LIVING | UPVC FRAME GLASS DOOR |
| 2 | GLASS | 2000 | 2000 | LIVING | UPVC FRAME GLASS DOOR |
| 3 | GLASS | 1500 | 1500 | LIVING | UPVC FRAME GLASS DOOR |
| 4 | GLASS | 1500 | 1500 | LIVING | UPVC FRAME GLASS DOOR |
| 5 | GLASS | 1500 | 1500 | LIVING | UPVC FRAME GLASS DOOR |
| 6 | GLASS | 1500 | 1500 | LIVING | UPVC FRAME GLASS DOOR |
| 7 | GLASS | 1500 | 1500 | LIVING | UPVC FRAME GLASS DOOR |
| 8 | GLASS | 1500 | 1500 | LIVING | UPVC FRAME GLASS DOOR |
| 9 | GLASS | 1500 | 1500 | LIVING | UPVC FRAME GLASS DOOR |
| 10 | GLASS | 1500 | 1500 | LIVING | UPVC FRAME GLASS DOOR |
| 11 | GLASS | 1500 | 1500 | LIVING | UPVC FRAME GLASS DOOR |
| 12 | GLASS | 1500 | 1500 | LIVING | UPVC FRAME GLASS DOOR |
| 13 | GLASS | 1500 | 1500 | LIVING | UPVC FRAME GLASS DOOR |
| 14 | GLASS | 1500 | 1500 | LIVING | UPVC FRAME GLASS DOOR |
| 15 | GLASS | 1500 | 1500 | LIVING | UPVC FRAME GLASS DOOR |
| 16 | GLASS | 1500 | 1500 | LIVING | UPVC FRAME GLASS DOOR |
| 17 | GLASS | 1500 | 1500 | LIVING | UPVC FRAME GLASS DOOR |
| 18 | GLASS | 1500 | 1500 | LIVING | UPVC FRAME GLASS DOOR |
| 19 | GLASS | 1500 | 1500 | LIVING | UPVC FRAME GLASS DOOR |
| 20 | GLASS | 1500 | 1500 | LIVING | UPVC FRAME GLASS DOOR |

| SL. NO. | TYPE | HEIGHT | LEVEL | LOCATION | DESCRIPTION |
|---------|-------|--------|-------|----------|-----------------------|
| 1 | GLASS | 2000 | 2000 | LIVING | UPVC FRAME GLASS DOOR |
| 2 | GLASS | 2000 | 2000 | LIVING | UPVC FRAME GLASS DOOR |
| 3 | GLASS | 1500 | 1500 | LIVING | UPVC FRAME GLASS DOOR |
| 4 | GLASS | 1500 | 1500 | LIVING | UPVC FRAME GLASS DOOR |
| 5 | GLASS | 1500 | 1500 | LIVING | UPVC FRAME GLASS DOOR |
| 6 | GLASS | 1500 | 1500 | LIVING | UPVC FRAME GLASS DOOR |
| 7 | GLASS | 1500 | 1500 | LIVING | UPVC FRAME GLASS DOOR |
| 8 | GLASS | 1500 | 1500 | LIVING | UPVC FRAME GLASS DOOR |
| 9 | GLASS | 1500 | 1500 | LIVING | UPVC FRAME GLASS DOOR |
| 10 | GLASS | 1500 | 1500 | LIVING | UPVC FRAME GLASS DOOR |
| 11 | GLASS | 1500 | 1500 | LIVING | UPVC FRAME GLASS DOOR |
| 12 | GLASS | 1500 | 1500 | LIVING | UPVC FRAME GLASS DOOR |
| 13 | GLASS | 1500 | 1500 | LIVING | UPVC FRAME GLASS DOOR |
| 14 | GLASS | 1500 | 1500 | LIVING | UPVC FRAME GLASS DOOR |
| 15 | GLASS | 1500 | 1500 | LIVING | UPVC FRAME GLASS DOOR |
| 16 | GLASS | 1500 | 1500 | LIVING | UPVC FRAME GLASS DOOR |
| 17 | GLASS | 1500 | 1500 | LIVING | UPVC FRAME GLASS DOOR |
| 18 | GLASS | 1500 | 1500 | LIVING | UPVC FRAME GLASS DOOR |
| 19 | GLASS | 1500 | 1500 | LIVING | UPVC FRAME GLASS DOOR |
| 20 | GLASS | 1500 | 1500 | LIVING | UPVC FRAME GLASS DOOR |

OWNER: GODREJ PROPERTIES LIMITED

SUBMISSION DRAWING

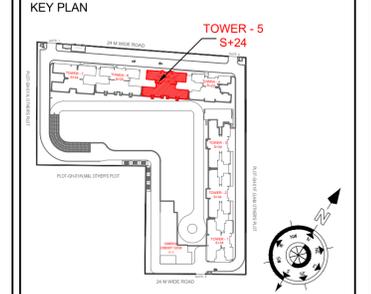

PROPOSED GROUP HOUSING FOR PLOT NO. - GH-01/B,C,D,E,J & K SECTOR -12, GREATER NOIDA, G.B. NAGAR, (U.P.)

| DATE | PROJECT INCH. | CHECKED BY |
|----------------|---------------|--------------|
| 08 - 01 - 2025 | BALRAJ SINGH | BALRAJ SINGH |

| SCALE | DEALT BY | APPROVED BY |
|-------|-------------|---------------|
| 1:100 | ABDRESH JHA | VISHAL SHARMA |

DRAWING TITLE: FIRST FLOOR PLAN


TOWER - 5

ARCHITECTS: GOLDEN INDIA ARCHITECTS
THE TEAM OF ARCHITECTS
FF-37, KADAMBA SHOPPING COMPLEX
GAMMA-1 GREATER NOIDA
CON. +91-94-1585-6777

DESIGN BY: Confluence
NEW DELHI, INDIA
F-1, FIRST FLOOR, MIRA CORPORATE SUITES,
ISHWAR NAGAR, NEW DELHI 110065


| DRAWING NO. | REVISION |
|-------------|----------|
| S-46 | |

LAL SINGH
Digitally signed by LAL SINGH
Date: 2025.01.27
17:49:28
+05'30'

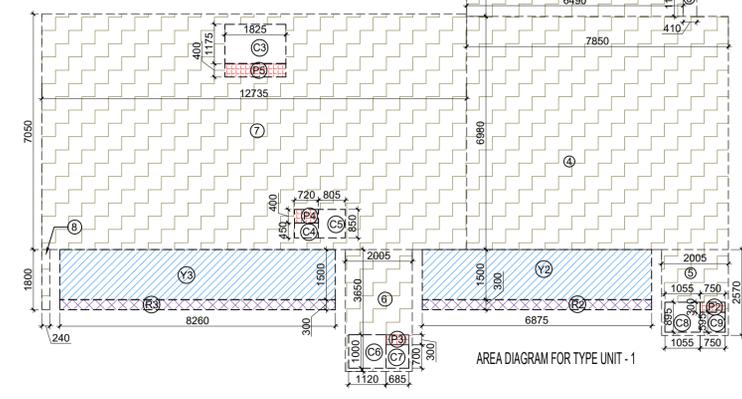


Amit Varma
Digitally signed by Amit Varma
Date: 2025.01.25
17:10:55 +05'30'

Sudheer Kumar
Digitally signed by Sudheer Kumar
Date: 2025.01.28
14:26:50 +05'30'

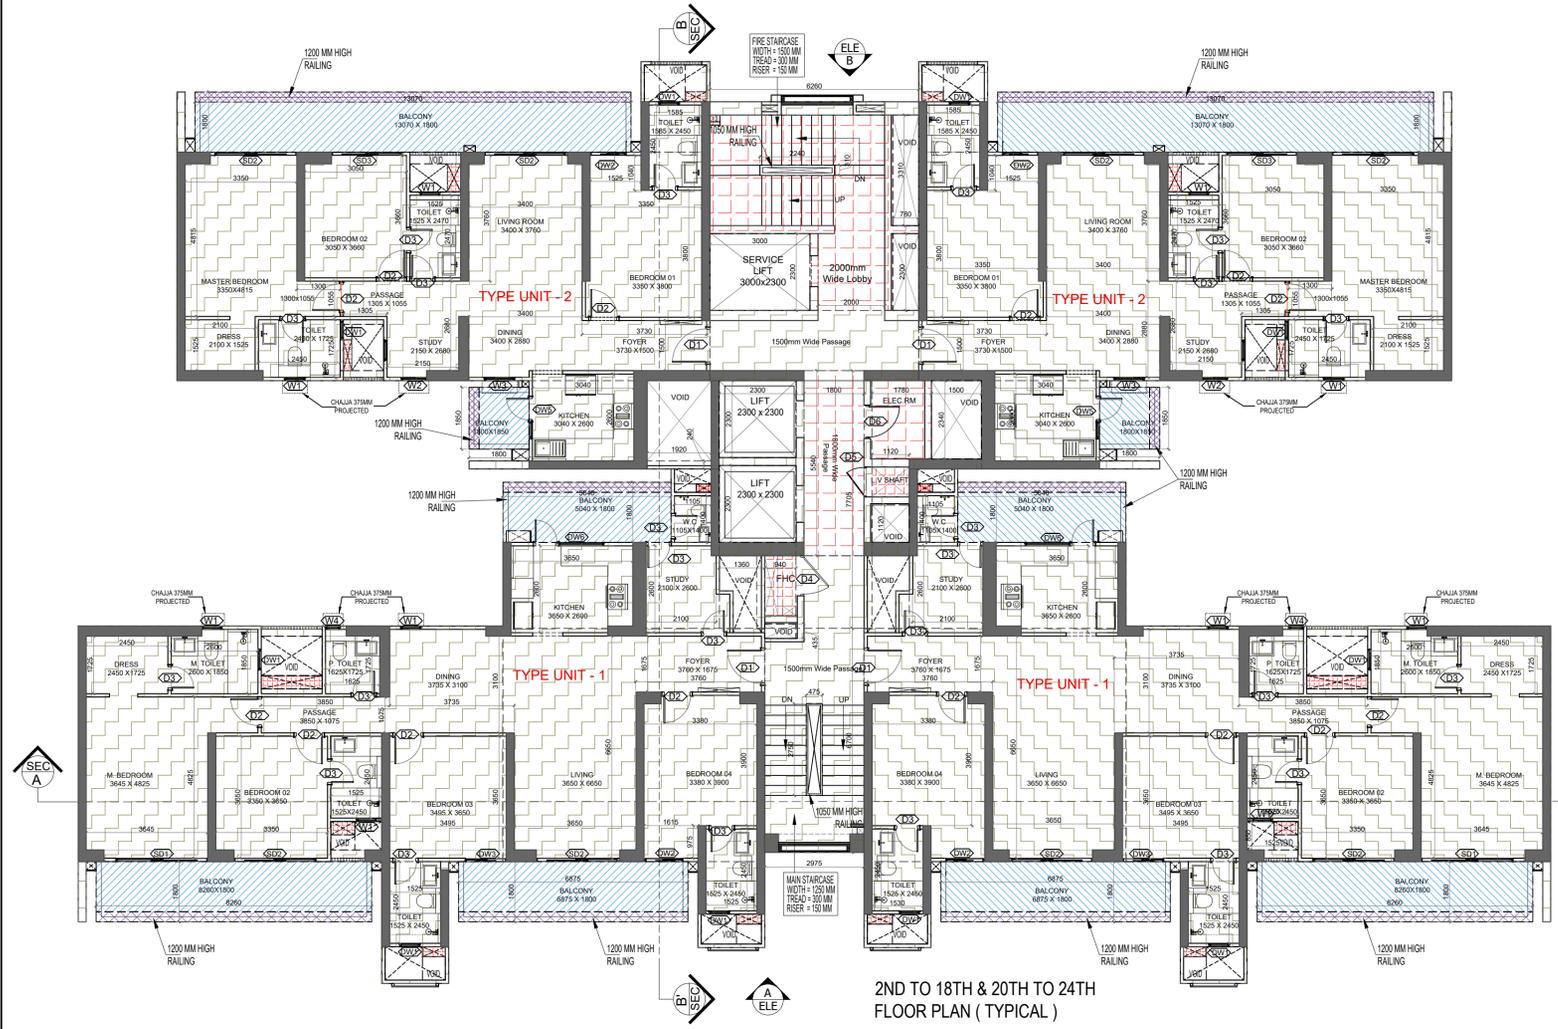

LEGEND

- F.A.R AREA
- 15% SERVICES AREA
- NON F.A.R AREA
- COUNTED IN 1/4 F.A.R AREA

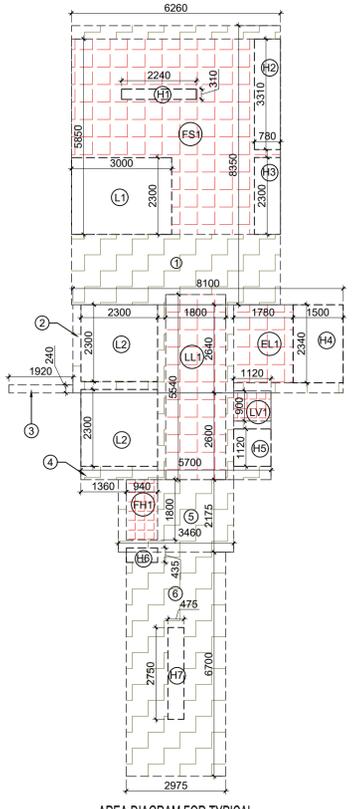

F.A.R COVERED AREA CALCULATION FOR CIRCULATION AREA


| S.NO. | S.NO. | PARTICULARS | AREA (SQM) | | | | |
|--|-------|-------------|------------|----------|----------------|---|--------|
| 1 | 6.260 | X | 8.350 | = | 52.271 | | |
| 2 | 8.100 | X | 2.540 | = | 21.364 | | |
| 3 | 1.920 | X | 0.240 | = | 0.461 | | |
| 4 | 5.700 | X | 2.800 | = | 14.820 | | |
| 5 | 3.460 | X | 2.175 | = | 7.528 | | |
| 6 | 2.975 | X | 6.700 | = | 19.933 | | |
| TOTAL AREA (A) | | | | = | 116.384 | | |
| AREA SUBTRACTION | | | | | | | |
| FS1 | 6.260 | X | 5.850 | = | 36.821 | | |
| LL1 | 1.800 | X | 5.540 | = | 9.972 | | |
| EL1 | 1.780 | X | 2.340 | = | 4.165 | | |
| FH1 | 1.120 | X | 0.900 | = | 1.008 | | |
| LV1 | 0.940 | X | 1.800 | = | 1.692 | | |
| L2 | 2.300 | X | 2.300 | X | 2 | = | 10.580 |
| H4 | 1.500 | X | 2.340 | = | 3.510 | | |
| HS | 1.120 | X | 1.120 | = | 1.254 | | |
| HB | 0.940 | X | 0.435 | = | 0.409 | | |
| H7 | 0.475 | X | 2.750 | = | 1.308 | | |
| TOTAL (B) | | | | = | 76.518 | | |
| TOTAL F.A.R AREA CORRIDOR C = (A - B) | | | | = | 45.876 | | |

TOTAL F.A.R AREA AT 2ND TO 18TH, 20TH TO 24TH FLOOR PLAN (TYPICAL)

| S.NO. | PARTICULARS | AREA (SQM) | | | |
|---------------------------|-------------|------------|---------|----------|----------------|
| F.A.R AREA OF UNIT - 1 | 2 | X | 170.944 | = | 341.888 |
| F.A.R AREA OF UNIT - 2 | 2 | X | 121.183 | = | 242.366 |
| F.A.R AREA OF CIRCULATION | 1 | X | 45.876 | = | 45.876 |
| TOTAL F.A.R AREA | | | | = | 630.130 |

TOTAL NON F.A.R AREA AT 2ND TO 18TH, 20TH TO 24TH FLOOR PLAN (TYPICAL)

| UNIT | AREA | Count | Total Area | | |
|---------------------------|--------|-------|------------|----------|----------------|
| UNIT - 1 | 34.552 | X | 2 | = | 69.103 |
| UNIT - 2 | 25.669 | X | 2 | = | 51.338 |
| TOTAL BALCONY AREA | | | | = | 120.441 |

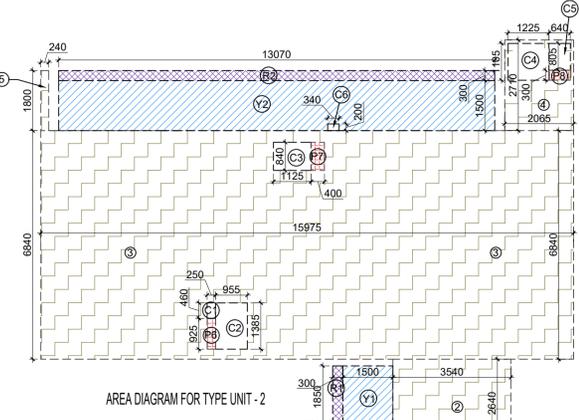

CORRIDOR AREA CALCULATION TOWARDS 15% ADDITIONAL F.A.R

| S.NO. | PARTICULARS | AREA (SQM) | | | | | |
|--|-------------|------------|-------|----------|---------------|---|-------|
| FS1 | 6.260 | X | 5.850 | = | 36.821 | | |
| LL1 | 1.800 | X | 5.540 | = | 9.972 | | |
| EL1 | 1.780 | X | 2.340 | = | 4.165 | | |
| FH1 | 1.120 | X | 0.900 | = | 1.008 | | |
| LV1 | 0.940 | X | 1.800 | = | 1.692 | | |
| TOTAL CORRIDOR AREA CALCULATION TOWARDS 15% ADDITIONAL F.A.R (A) | | | | = | 53.658 | | |
| UNIT AREA CALCULATION TOWARDS 15% ADDITIONAL F.A.R | | | | | | | |
| PLUMBING SHAFT | | | | | | | |
| P1 | 0.450 | X | 0.250 | X | 2 | = | 0.225 |
| P2 | 0.750 | X | 0.300 | X | 2 | = | 0.450 |
| P3 | 0.685 | X | 0.300 | X | 2 | = | 0.411 |
| P4 | 0.720 | X | 0.400 | X | 2 | = | 0.576 |
| P5 | 1.825 | X | 0.400 | X | 2 | = | 1.460 |
| P6 | 0.250 | X | 0.925 | X | 2 | = | 0.463 |
| P7 | 0.400 | X | 0.840 | X | 2 | = | 0.672 |
| P8 | 0.640 | X | 0.300 | X | 2 | = | 0.384 |
| TOTAL UNIT AREA CALCULATION TOWARDS 15% ADDITIONAL F.A.R (B) | | | | = | 4.641 | | |
| TOTAL 15% ADDITIONAL F.A.R AREA (CORRIDOR AREA + UNIT AREA) C = (A + B) | | | | = | 58.099 | | |
| AREA SUBTRACTION | | | | | | | |
| H1 | 2.240 | X | 0.310 | = | 0.694 | | |
| H2 | 0.780 | X | 3.310 | = | 2.582 | | |
| H3 | 0.780 | X | 2.300 | = | 1.794 | | |
| L1 | 3.000 | X | 2.300 | = | 6.900 | | |
| TOTAL AREA (D) | | | | = | 11.976 | | |
| TOTAL 15% ADDITIONAL F.A.R AREA E = (C - D) | | | | = | 46.123 | | |

F.A.R COVERED AREA CALCULATION FOR TYPE UNIT - 2

| S.NO. | PARTICULARS | AREA (SQM) | | | |
|---|-------------|------------|-------|----------|----------------|
| 1 | 1.800 | X | 0.240 | = | 0.432 |
| 2 | 3.540 | X | 2.640 | = | 9.348 |
| 3 | 15.975 | X | 6.840 | = | 109.269 |
| 4 | 2.065 | X | 2.710 | = | 5.596 |
| 5 | 0.240 | X | 1.800 | = | 0.432 |
| UNIT FAR AREA = (A) | | | | = | 125.075 |
| AREA SUBTRACTION PLUMBING CUTOUT | | | | | |
| P6 | 0.250 | X | 0.925 | = | 0.231 |
| P7 | 0.400 | X | 0.840 | = | 0.336 |
| P8 | 0.640 | X | 0.300 | = | 0.192 |
| C1 | 0.250 | X | 0.450 | = | 0.113 |
| C2 | 0.955 | X | 1.385 | = | 1.323 |
| C3 | 1.125 | X | 0.840 | = | 0.945 |
| C4 | 1.225 | X | 1.105 | = | 1.354 |
| C5 | 0.640 | X | 0.805 | = | 0.515 |
| TOTAL (B) | | | | = | 5.011 |
| TOTAL F.A.R AREA C = (A - B) | | | | = | 120.064 |

1/4 F.A.R AREA OF BALCONY

| R | Area | Total | | | |
|--|----------------|---------|----------|--------------|----------------|
| R1 | 0.300 X 1.850 | = 0.555 | | | |
| R2 | 13.070 X 0.300 | = 3.921 | | | |
| TOTAL AREA (D) | | | = | 4.476 | |
| 1/4 BALCONY F.A.R AREA (E) | | | = | 1.119 | |
| TOTAL UNIT F.A.R AREA F = (C + E) | | | | = | 121.183 |

NON F.A.R AREA OF BALCONY

| Y | Area | Total | | | |
|---------------------------------------|----------------|----------|----------|---------------|--|
| Y1 | 1.500 X 1.850 | = 2.775 | | | |
| Y2 | 13.070 X 1.500 | = 19.605 | | | |
| 3/4 AREA OF BALCONY (D - E) | | | = | 3.567 | |
| TOTAL AREA (G) | | | = | 25.737 | |
| AREA SUBTRACTION | | | | | |
| C6 | 0.340 X 0.200 | = 0.068 | | | |
| TOTAL AREA (H) | | | = | 0.668 | |
| TOTAL BALCONY AREA J = (D - H) | | | = | 25.669 | |

15% SERVICES AREA OF UNIT (PLUMBING SHAFT)

| P | Area | Total | | | |
|---|---------------|---------|----------|--------------|----------------|
| P6 | 0.250 X 0.925 | = 0.231 | | | |
| P7 | 0.400 X 0.840 | = 0.336 | | | |
| P8 | 0.640 X 0.300 | = 0.192 | | | |
| TOTAL 15% SERVICES AREA OF UNIT (K) | | | = | 0.759 | |
| COVERAGE AREA FOR UNIT = (F + J + K) | | | | = | 121.183 |
| TOTAL UNIT F.A.R AREA (F) | | | | = | 121.183 |
| TOTAL NON F.A.R AREA (J) | | | | = | 25.669 |
| TOTAL 15% SERVICES AREA OF UNIT (K) | | | | = | 0.759 |
| TOTAL UNIT COVERAGE AREA | | | | = | 147.611 |

F.A.R COVERED AREA CALCULATION FOR TYPE UNIT - 1

| S.NO. | PARTICULARS | AREA (SQM) | | | |
|---|-------------|------------|-------|----------|----------------|
| 1 | 1.445 | X | 2.200 | = | 3.179 |
| 2 | 5.490 | X | 2.570 | = | 16.679 |
| 3 | 0.410 | X | 1.120 | = | 0.459 |
| 4 | 7.850 | X | 6.980 | = | 54.793 |
| 5 | 2.005 | X | 2.570 | = | 5.153 |
| 6 | 2.005 | X | 3.650 | = | 7.318 |
| 7 | 12.735 | X | 7.050 | = | 89.782 |
| 8 | 0.240 | X | 1.800 | = | 0.432 |
| UNIT FAR AREA = (A) | | | | = | 177.795 |
| AREA SUBTRACTION PLUMBING CUTOUT | | | | | |
| P1 | 0.450 | X | 0.250 | = | 0.113 |
| P2 | 0.750 | X | 0.300 | = | 0.225 |
| P3 | 0.685 | X | 0.300 | = | 0.206 |
| P4 | 0.720 | X | 0.400 | = | 0.288 |
| P5 | 1.825 | X | 0.400 | = | 0.730 |
| C1 | 1.105 | X | 0.450 | = | 0.497 |
| C2 | 0.655 | X | 0.250 | = | 0.164 |
| C3 | 1.825 | X | 1.175 | = | 2.144 |
| C4 | 0.720 | X | 0.450 | = | 0.324 |
| C5 | 0.805 | X | 0.650 | = | 0.684 |
| C8 | 1.120 | X | 1.000 | = | 1.120 |
| C7 | 0.685 | X | 0.700 | = | 0.480 |
| C8 | 1.055 | X | 0.695 | = | 0.944 |
| C9 | 0.750 | X | 0.595 | = | 0.446 |
| TOTAL (B) | | | | = | 8.365 |
| TOTAL F.A.R AREA C = (A - B) | | | | = | 169.431 |

1/4 F.A.R AREA OF BALCONY

| R | Area | Total | | | |
|--|---------------|---------|----------|--------------|----------------|
| R1 | 5.040 X 0.300 | = 1.512 | | | |
| R2 | 6.875 X 0.300 | = 2.063 | | | |
| R3 | 8.260 X 0.300 | = 2.478 | | | |
| TOTAL AREA (D) | | | = | 6.853 | |
| 1/4 BALCONY F.A.R AREA (E) | | | = | 1.513 | |
| TOTAL UNIT F.A.R AREA F = (C + E) | | | | = | 170.944 |

NON F.A.R AREA OF BALCONY

| Y | Area | Total | | | |
|---------------------------------------|---------------|----------|----------|---------------|--|
| Y1 | 5.040 X 1.500 | = 7.560 | | | |
| Y2 | 6.875 X 1.500 | = 10.313 | | | |
| Y3 | 8.260 X 1.500 | = 12.390 | | | |
| 3/4 AREA OF BALCONY (D - E) | | | = | 4.539 | |
| TOTAL AREA (G) | | | = | 34.802 | |
| AREA SUBTRACTION | | | | | |
| C10 | 0.715 X 0.350 | = 0.250 | | | |
| TOTAL AREA (H) | | | = | 0.250 | |
| TOTAL BALCONY AREA J = (G - H) | | | = | 34.552 | |

15% SERVICES AREA OF UNIT (PLUMBING SHAFT)

| P | Area | Total | | | |
|---|---------------|---------|----------|--------------|----------------|
| P1 | 0.450 X 0.250 | = 0.113 | | | |
| P2 | 0.750 X 0.300 | = 0.225 | | | |
| P3 | 0.685 X 0.300 | = 0.206 | | | |
| P4 | 0.720 X 0.400 | = 0.288 | | | |
| P5 | 1.825 X 0.400 | = 0.730 | | | |
| TOTAL 15% SERVICES AREA OF UNIT (K) | | | = | 1.561 | |
| COVERAGE AREA FOR UNIT = (F + J + K) | | | | = | 170.944 |
| TOTAL UNIT F.A.R AREA (F) | | | | = | 170.944 |
| TOTAL NON F.A.R AREA (J) | | | | = | 34.552 |
| TOTAL 15% SERVICES AREA OF UNIT (K) | | | | = | 1.561 |
| TOTAL UNIT COVERAGE AREA | | | | = | 207.057 |

DOOR SCHEDULE

| S.NO. | TYPE | OPENING | HEIGHT | W.D. | LEVEL | LOCATION | DESCRIPTION |
|-------|------|-------------|--------|------|-------|----------|-------------------------------|
| 1 | DOOR | 2100 X 1175 | 2100 | 1175 | 0.00 | LIVING | UPVC FRAME SLIDING GLASS DOOR |
| 2 | DOOR | 2100 X 1175 | 2100 | 1175 | 0.00 | LIVING | UPVC FRAME SLIDING GLASS DOOR |
| 3 | DOOR | 2100 X 1175 | 2100 | 1175 | 0.00 | LIVING | UPVC FRAME SLIDING GLASS DOOR |
| 4 | DOOR | 2100 X 1175 | 2100 | 1175 | 0.00 | LIVING | UPVC FRAME SLIDING GLASS DOOR |
| 5 | DOOR | 2100 X 1175 | 2100 | 1175 | 0.00 | LIVING | UPVC FRAME SLIDING GLASS DOOR |
| 6 | DOOR | 2100 X 1175 | 2100 | 1175 | 0.00 | LIVING | UPVC FRAME SLIDING GLASS DOOR |
| 7 | DOOR | 2100 X 1175 | 2100 | 1175 | 0.00 | LIVING | UPVC FRAME SLIDING GLASS DOOR |
| 8 | DOOR | 2100 X 1175 | 2100 | 1175 | 0.00 | LIVING | UPVC FRAME SLIDING GLASS DOOR |
| 9 | DOOR | 2100 X 1175 | 2100 | 1175 | 0.00 | LIVING | UPVC FRAME SLIDING GLASS DOOR |
| 10 | DOOR | 2100 X 1175 | 2100 | 1175 | 0.00 | LIVING | UPVC FRAME SLIDING GLASS DOOR |
| 11 | DOOR | 2100 X 1175 | 2100 | 1175 | 0.00 | LIVING | UPVC FRAME SLIDING GLASS DOOR |
| 12 | DOOR | 2100 X 1175 | 2100 | 1175 | 0.00 | LIVING | UPVC FRAME SLIDING GLASS DOOR |
| 13 | DOOR | 2100 X 1175 | 2100 | 1175 | 0.00 | LIVING | UPVC FRAME SLIDING GLASS DOOR |
| 14 | DOOR | 2100 X 1175 | 2100 | 1175 | 0.00 | LIVING | UPVC FRAME SLIDING GLASS DOOR |
| 15 | DOOR | 2100 X 1175 | 2100 | 1175 | 0.00 | LIVING | UPVC FRAME SLIDING GLASS DOOR |
| 16 | DOOR | 2100 X 1175 | 2100 | 1175 | 0.00 | LIVING | UPVC FRAME SLIDING GLASS DOOR |
| 17 | DOOR | 2100 X 1175 | 2100 | 1175 | 0.00 | LIVING | UPVC FRAME SLIDING GLASS DOOR |
| 18 | DOOR | 2100 X 1175 | 2100 | 1175 | 0.00 | LIVING | UPVC FRAME SLIDING GLASS DOOR |
| 19 | DOOR | 2100 X 1175 | 2100 | 1175 | 0.00 | LIVING | UPVC FRAME SLIDING GLASS DOOR |
| 20 | DOOR | 2100 X 1175 | 2100 | 1175 | 0.00 | LIVING | UPVC FRAME SLIDING GLASS DOOR |
| 21 | DOOR | 2100 X 1175 | 2100 | 1175 | 0.00 | LIVING | UPVC FRAME SLIDING GLASS DOOR |
| 22 | DOOR | 2100 X 1175 | 2100 | 1175 | 0.00 | LIVING | UPVC FRAME SLIDING GLASS DOOR |
| 23 | DOOR | 2100 X 1175 | 2100 | 1175 | 0.00 | LIVING | UPVC FRAME SLIDING GLASS DOOR |
| 24 | DOOR | 2100 X 1175 | 2100 | 1175 | 0.00 | LIVING | UPVC FRAME SLIDING GLASS DOOR |
| 25 | DOOR | 2100 X 1175 | 2100 | 1175 | 0.00 | LIVING | UPVC FRAME SLIDING GLASS DOOR |
| 26 | DOOR | 2100 X 1175 | 2100 | 1175 | 0.00 | LIVING | UPVC FRAME SLIDING GLASS DOOR |
| 27 | DOOR | 2100 X 1175 | 2100 | 1175 | 0.00 | LIVING | UPVC FRAME SLIDING GLASS DOOR |
| 28 | DOOR | 2100 X 1175 | 2100 | 1175 | 0.00 | LIVING | UPVC FRAME SLIDING GLASS DOOR |
| 29 | DOOR | 2100 X 1175 | 2100 | 1175 | 0.00 | LIVING | UPVC FRAME SLIDING GLASS DOOR |
| 30 | DOOR | 2100 X 1175 | 2100 | 1175 | 0.00 | LIVING | UPVC FRAME SLIDING GLASS DOOR |

WINDOW SCHEDULE

| S.NO. | TYPE | OPENING | HEIGHT | W.D. | LEVEL | LOCATION | DESCRIPTION |
|-------|--------|-------------|--------|------|-------|----------|---------------------------------|
| 1 | WINDOW | 1500 X 1175 | 1500 | 1175 | 0.00 | LIVING | UPVC FRAME SLIDING GLASS WINDOW |
| 2 | WINDOW | 1500 X 1175 | 1500 | 1175 | 0.00 | LIVING | UPVC FRAME SLIDING GLASS WINDOW |
| 3 | WINDOW | 1500 X 1175 | 1500 | 1175 | 0.00 | LIVING | UPVC FRAME SLIDING GLASS WINDOW |
| 4 | WINDOW | 1500 X 1175 | 1500 | 1175 | 0.00 | LIVING | UPVC FRAME SLIDING GLASS WINDOW |
| 5 | WINDOW | 1500 X 1175 | 1500 | 1175 | 0.00 | LIVING | UPVC FRAME SLIDING GLASS WINDOW |
| 6 | WINDOW | 1500 X 1175 | 1500 | 1175 | 0.00 | LIVING | UPVC FRAME SLIDING GLASS WINDOW |
| 7 | WINDOW | 1500 X 1175 | 1500 | 1175 | 0.00 | LIVING | UPVC FRAME SLIDING GLASS WINDOW |
| 8 | WINDOW | 1500 X 1175 | | | | | |

Sudheer Kumar
Digitally signed by Sudheer Kumar
Date: 2025.01.28
14:27:37 +05'30'

LAL SINGH
Digitally signed by LAL SINGH
Date: 2025.01.27
17:49:46 +05'30'

Amit Varma
Digitally signed by Amit Varma
Date: 2025.01.25
17:11:15 +05'30'

OWNER SIGN
Rajat pathak
2025.01.23
12:36:20
+05'30'

ARCHITECT SIGN
AVANIS SRIVASTAV
2025.01.23
12:36:34
+05'30'

TOWN PLANNER SIGN

DOOR SCHEDULE

| S.NO. | TYPE | OPENING | HEIGHT | LEVEL | LOCATION | DESCRIPTION |
|-------|------|-------------|--------|-------|----------|-------------------------------|
| 1 | 001 | 2100 X 1200 | 2100 | 000 | LIVING | UPVC FRAME SLIDING GLASS DOOR |
| 2 | 002 | 1800 X 1200 | 1800 | 000 | LIVING | UPVC FRAME SLIDING GLASS DOOR |
| 3 | 003 | 1200 X 1200 | 1200 | 000 | LIVING | UPVC FRAME SLIDING GLASS DOOR |
| 4 | 004 | 1200 X 1200 | 1200 | 000 | BEDROOM | UPVC FRAME SLIDING GLASS DOOR |
| 5 | 005 | 1200 X 1200 | 1200 | 000 | BEDROOM | UPVC FRAME SLIDING GLASS DOOR |
| 6 | 006 | 1200 X 1200 | 1200 | 000 | BEDROOM | UPVC FRAME SLIDING GLASS DOOR |
| 7 | 007 | 1200 X 1200 | 1200 | 000 | BEDROOM | UPVC FRAME SLIDING GLASS DOOR |
| 8 | 008 | 1200 X 1200 | 1200 | 000 | BEDROOM | UPVC FRAME SLIDING GLASS DOOR |
| 9 | 009 | 1200 X 1200 | 1200 | 000 | BEDROOM | UPVC FRAME SLIDING GLASS DOOR |
| 10 | 010 | 1200 X 1200 | 1200 | 000 | BEDROOM | UPVC FRAME SLIDING GLASS DOOR |
| 11 | 011 | 1200 X 1200 | 1200 | 000 | BEDROOM | UPVC FRAME SLIDING GLASS DOOR |
| 12 | 012 | 1200 X 1200 | 1200 | 000 | BEDROOM | UPVC FRAME SLIDING GLASS DOOR |
| 13 | 013 | 1200 X 1200 | 1200 | 000 | BEDROOM | UPVC FRAME SLIDING GLASS DOOR |
| 14 | 014 | 1200 X 1200 | 1200 | 000 | BEDROOM | UPVC FRAME SLIDING GLASS DOOR |
| 15 | 015 | 1200 X 1200 | 1200 | 000 | BEDROOM | UPVC FRAME SLIDING GLASS DOOR |
| 16 | 016 | 1200 X 1200 | 1200 | 000 | BEDROOM | UPVC FRAME SLIDING GLASS DOOR |
| 17 | 017 | 1200 X 1200 | 1200 | 000 | BEDROOM | UPVC FRAME SLIDING GLASS DOOR |
| 18 | 018 | 1200 X 1200 | 1200 | 000 | BEDROOM | UPVC FRAME SLIDING GLASS DOOR |
| 19 | 019 | 1200 X 1200 | 1200 | 000 | BEDROOM | UPVC FRAME SLIDING GLASS DOOR |
| 20 | 020 | 1200 X 1200 | 1200 | 000 | BEDROOM | UPVC FRAME SLIDING GLASS DOOR |

WINDOW SCHEDULE

| S.NO. | TYPE | OPENING | HEIGHT | LEVEL | LOCATION | DESCRIPTION |
|-------|------|-------------|--------|-------|----------|-------------------|
| 1 | 001 | 1200 X 1500 | 1200 | 000 | LIVING | UPVC FRAME WINDOW |
| 2 | 002 | 1200 X 1500 | 1200 | 000 | LIVING | UPVC FRAME WINDOW |
| 3 | 003 | 1200 X 1500 | 1200 | 000 | LIVING | UPVC FRAME WINDOW |
| 4 | 004 | 1200 X 1500 | 1200 | 000 | LIVING | UPVC FRAME WINDOW |
| 5 | 005 | 1200 X 1500 | 1200 | 000 | LIVING | UPVC FRAME WINDOW |
| 6 | 006 | 1200 X 1500 | 1200 | 000 | LIVING | UPVC FRAME WINDOW |
| 7 | 007 | 1200 X 1500 | 1200 | 000 | LIVING | UPVC FRAME WINDOW |
| 8 | 008 | 1200 X 1500 | 1200 | 000 | LIVING | UPVC FRAME WINDOW |
| 9 | 009 | 1200 X 1500 | 1200 | 000 | LIVING | UPVC FRAME WINDOW |
| 10 | 010 | 1200 X 1500 | 1200 | 000 | LIVING | UPVC FRAME WINDOW |
| 11 | 011 | 1200 X 1500 | 1200 | 000 | LIVING | UPVC FRAME WINDOW |
| 12 | 012 | 1200 X 1500 | 1200 | 000 | LIVING | UPVC FRAME WINDOW |
| 13 | 013 | 1200 X 1500 | 1200 | 000 | LIVING | UPVC FRAME WINDOW |
| 14 | 014 | 1200 X 1500 | 1200 | 000 | LIVING | UPVC FRAME WINDOW |
| 15 | 015 | 1200 X 1500 | 1200 | 000 | LIVING | UPVC FRAME WINDOW |
| 16 | 016 | 1200 X 1500 | 1200 | 000 | LIVING | UPVC FRAME WINDOW |
| 17 | 017 | 1200 X 1500 | 1200 | 000 | LIVING | UPVC FRAME WINDOW |
| 18 | 018 | 1200 X 1500 | 1200 | 000 | LIVING | UPVC FRAME WINDOW |
| 19 | 019 | 1200 X 1500 | 1200 | 000 | LIVING | UPVC FRAME WINDOW |
| 20 | 020 | 1200 X 1500 | 1200 | 000 | LIVING | UPVC FRAME WINDOW |

OWNER
GODREJ PROPERTIES LIMITED

SUBMISSION DRAWING

KEY PLAN

PROPOSED GROUP HOUSING FOR PLOT NO :- GH-01/B,C,D,E,J & K SECTOR -12, GREATER NOIDA, G.B. NAGAR, (U.P.)

DATE: 08-01-2025
PROJECT INCH: BALRAJ SINGH
CHECKED BY: BALRAJ SINGH

SCALE: 1:100
DEALT BY: ABDESH JHA
APPROVED BY: VISHAL SHARMA

DRAWING TITLE
19TH FLOOR PLAN (REFUGE LVL.)

TOWER - 5


ARCHITECTS
GOLDEN INDIA ARCHITECTS
THE TEAM OF ARCHITECTS
FF-37, KADAMBA SHOPPING COMPLEX
GAMMA-1 GREATER NOIDA
CON. +91-94-1585-6777

DESIGN BY:
Confluence
NEW DELHI, INDIA


F-1, FIRST FLOOR, MIRA CORPORATE SUITES,
ISHWAR NAGAR, NEW DELHI 110065

Ph: +91-11-26925684
cs@inconfluence.com
Member of IGCBC
Ph: +91-11-40564768
www.inconfluence.com
ISO: 9001:2000
architecture urban design hospitality interiors


DRAWING NO. S-48
REVISION

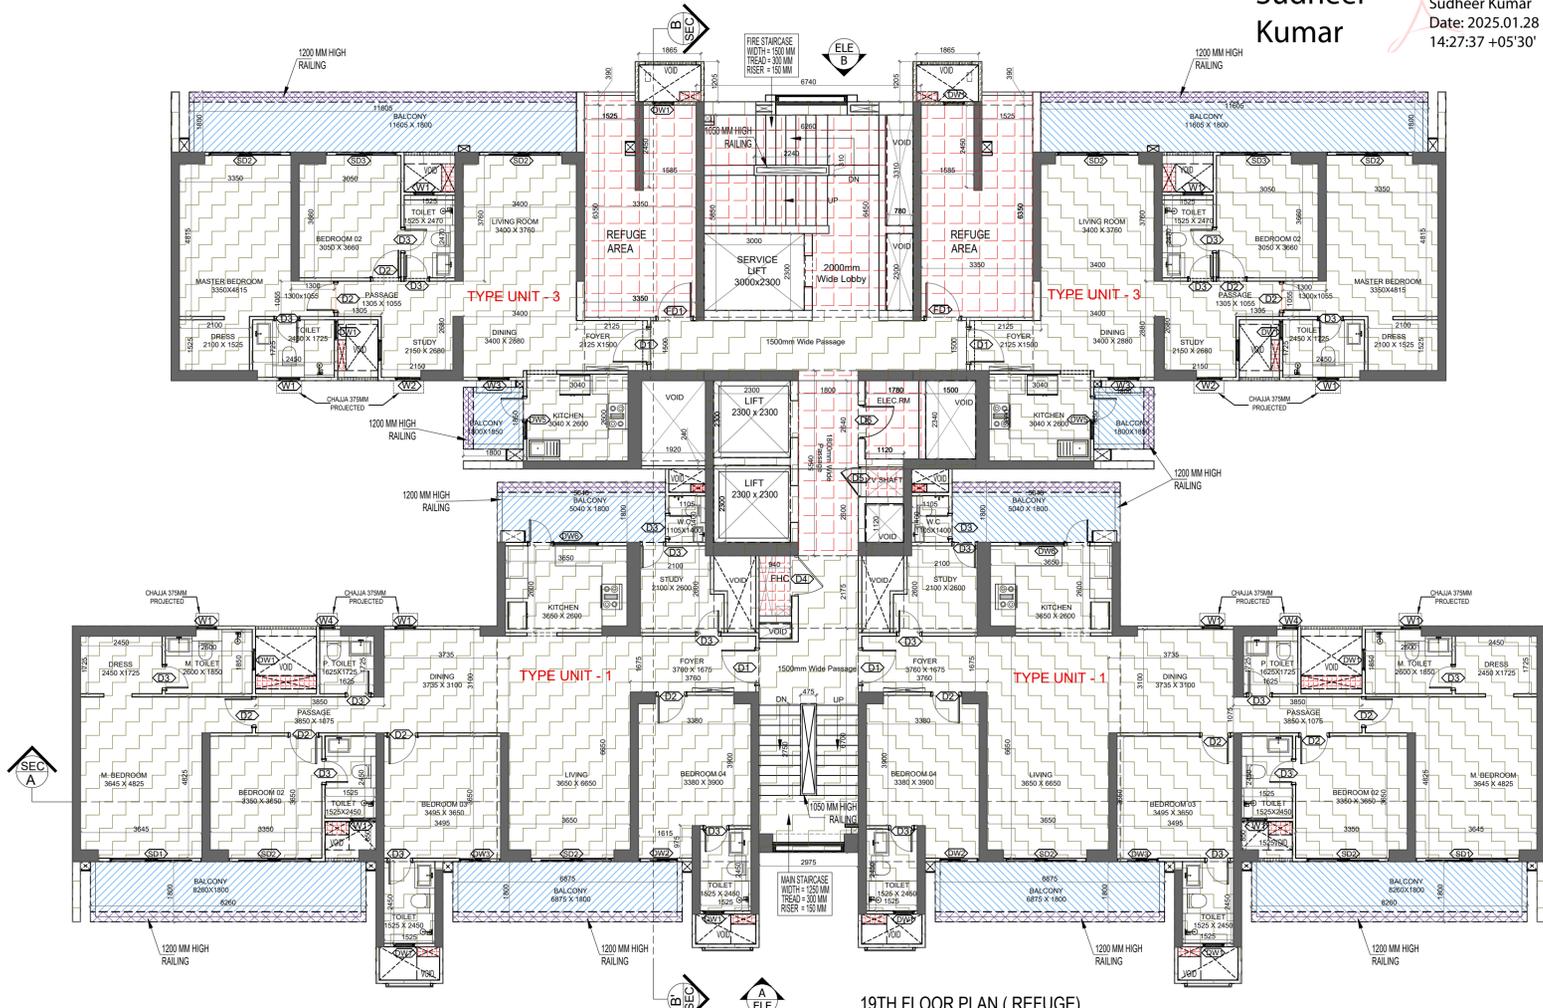

19TH FLOOR PLAN (REFUGE)

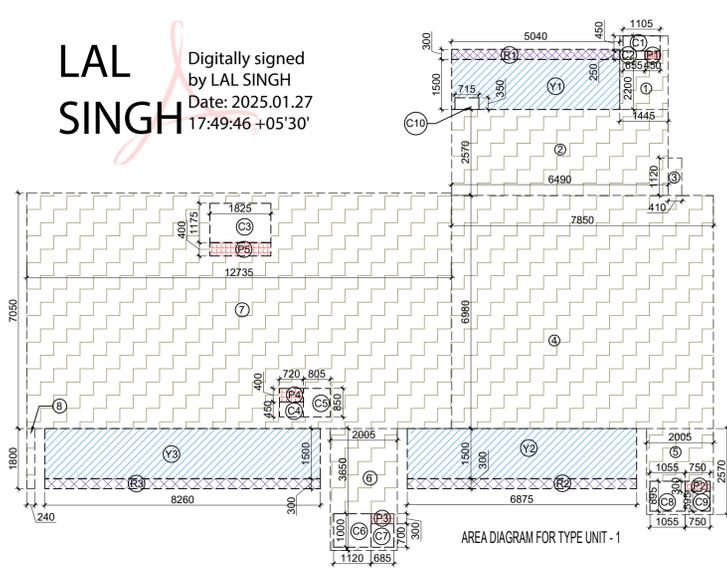

AREA DIAGRAM FOR TYPE UNIT - 1

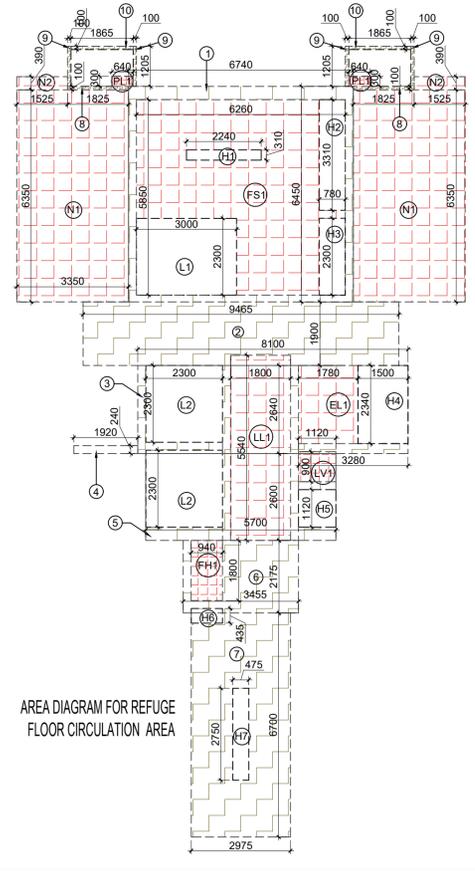

AREA DIAGRAM FOR REFUGE FLOOR CIRCULATION AREA

F.A.R. COVERED AREA CALCULATION FOR CIRCULATION AREA

| S.NO. | PARTICULARS | AREA (SQMTR) |
|--|-------------------|--------------|
| 1 | 6.740 X 6.450 | = 43.473 |
| 2 | 5.465 X 1.900 | = 10.384 |
| 3 | 8.100 X 2.640 | = 21.384 |
| 4 | 1.920 X 0.240 | = 0.461 |
| 5 | 5.700 X 2.600 | = 14.820 |
| 6 | 3.400 X 2.175 | = 7.398 |
| 7 | 2.975 X 6.700 | = 20.033 |
| 8 | 1.825 X 0.100 X 2 | = 0.365 |
| 9 | 0.100 X 1.205 X 4 | = 0.482 |
| 10 | 1.885 X 0.100 X 2 | = 0.373 |
| TOTAL AREA (A) | | = 128.799 |
| AREA SUBTRACTION | | |
| FS1 | 6.250 X 5.850 | = 36.521 |
| LL1 | 1.800 X 5.540 | = 9.972 |
| EL1 | 1.780 X 2.240 | = 3.985 |
| LV1 | 1.120 X 0.900 | = 1.008 |
| FH1 | 0.940 X 1.800 | = 1.692 |
| L2 | 2.300 X 2.300 X 2 | = 10.580 |
| H1 | 1.500 X 2.340 | = 3.510 |
| H5 | 1.120 X 1.120 | = 1.254 |
| H6 | 0.940 X 0.435 | = 0.409 |
| H7 | 0.475 X 2.750 | = 1.306 |
| TOTAL (B) | | = 70.518 |
| TOTAL F.A.R. AREA CORRIDOR C = (A - B) | | = 58.282 |

TOTAL F.A.R. AREA AT 19TH FLOOR PLAN (REFUGE LVL.)



| S.NO. | PARTICULARS | AREA (SQMTR) |
|-------------------|----------------------------|--------------|
| 1 | F.A.R. AREA OF UNIT - 1 | 170.944 |
| 2 | F.A.R. AREA OF UNIT - 3 | 97.188 |
| 3 | F.A.R. AREA OF CIRCULATION | 58.282 |
| TOTAL F.A.R. AREA | | = 526.314 |

TOTAL NON F.A.R. AREA AT 19TH FLOOR PLAN (REFUGE LVL.)

| UNIT | AREA | |
|--------------------|---------------------|-----------|
| UNIT - 1 | 34.552 X 2 = 69.103 | |
| UNIT - 3 | 23.142 X 2 = 46.284 | |
| TOTAL BALCONY AREA | | = 115.387 |

REFUGE AREA REQUIRED -
-786.700 SQMTR (BLDG. PLATE) X 2 FLOORS X 0.3
= 478.020 / 12.5 + 0.9 SQM (for spec. abled)
= 39.142 SQM. SAY. 40.00 SQM.

REFUGE AREA PROPOSED = 43.735 SQMTR

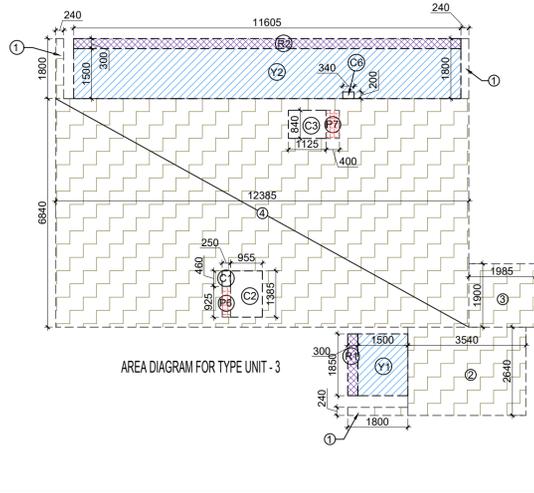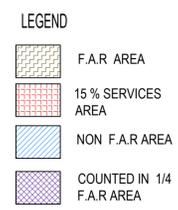

AREA DIAGRAM FOR TYPE UNIT - 3

F.A.R. COVERED AREA CALCULATION FOR TYPE UNIT - 3

| S.NO. | PARTICULARS | AREA (SQMTR) |
|------------------------------------|-------------------|--------------|
| 1 | 1.800 X 0.240 X 3 | = 1.296 |
| 2 | 3.540 X 2.640 | = 9.348 |
| 3 | 1.985 X 1.900 | = 3.772 |
| 4 | 12.385 X 6.840 | = 84.713 |
| UNIT FAR AREA = (A) | | = 99.127 |
| AREA SUBTRACTION PLUMBING CUTOFF | | |
| P6 | 0.250 X 0.925 | = 0.231 |
| P7 | 0.400 X 0.840 | = 0.336 |
| C1 | 0.250 X 0.450 | = 0.113 |
| C2 | 0.955 X 1.385 | = 1.323 |
| C3 | 1.125 X 0.840 | = 0.945 |
| TOTAL (B) | | = 2.950 |
| TOTAL F.A.R. AREA C = (A - B) | | = 96.177 |
| 1/4 F.A.R. AREA OF BALCONY | | |
| R1 | 0.300 X 1.850 | = 0.555 |
| R2 | 11.805 X 0.300 | = 3.542 |
| TOTAL AREA (D) | | = 4.097 |
| 1/4 BALCONY F.A.R. AREA (E) | | = 1.009 |
| TOTAL UNIT F.A.R. AREA F = (C + E) | | = 97.188 |

NON F.A.R. AREA OF BALCONY

| Y | AREA |
|---|-------------------------|
| Y1 | 1.500 X 1.850 = 2.775 |
| Y2 | 11.805 X 1.500 = 17.408 |
| TOTAL AREA (G) = 20.183 | |
| TOTAL AREA (H) = 0.068 | |
| TOTAL BALCONY AREA J = (G + H) = 20.251 | |
| TOTAL 15% SERVICES AREA OF UNIT (K) = 0.967 | |
| TOTAL UNIT COVERAGE AREA = 120.895 | |

F.A.R. COVERED AREA CALCULATION FOR TYPE UNIT - 1

| S.NO. | PARTICULARS | AREA (SQMTR) |
|---|------------------------|--------------|
| 1 | 1.445 X 2.200 | = 3.179 |
| 2 | 6.490 X 2.570 | = 16.679 |
| 3 | 0.410 X 1.120 | = 0.459 |
| 4 | 7.850 X 6.980 | = 54.793 |
| 5 | 2.205 X 2.570 | = 5.653 |
| 6 | 2.205 X 3.650 | = 8.049 |
| 7 | 12.735 X 7.050 | = 89.782 |
| 8 | 0.240 X 1.800 | = 0.432 |
| UNIT FAR AREA = (A) | | = 177.795 |
| AREA SUBTRACTION PLUMBING CUTOFF | | |
| P1 | 0.450 X 0.250 | = 0.113 |
| P2 | 0.750 X 0.300 | = 0.225 |
| P3 | 0.685 X 0.300 | = 0.206 |
| P4 | 0.720 X 0.400 | = 0.288 |
| P5 | 1.825 X 0.400 | = 0.730 |
| C1 | 1.105 X 0.450 | = 0.497 |
| C2 | 0.655 X 0.250 | = 0.164 |
| C3 | 1.825 X 1.175 | = 2.144 |
| C4 | 0.720 X 0.450 | = 0.324 |
| C5 | 0.955 X 0.850 | = 0.811 |
| C6 | 1.120 X 1.000 | = 1.120 |
| C7 | 0.685 X 0.700 | = 0.480 |
| C8 | 1.055 X 0.895 | = 0.944 |
| C9 | 0.750 X 0.595 | = 0.446 |
| TOTAL (B) | | = 8.365 |
| TOTAL F.A.R. AREA C = (A - B) | | = 169.431 |
| 1/4 F.A.R. AREA OF BALCONY | | |
| R1 | 5.040 X 0.300 | = 1.512 |
| R2 | 6.875 X 0.300 | = 2.063 |
| R3 | 8.260 X 0.300 | = 2.478 |
| TOTAL AREA (D) | | = 6.053 |
| 1/4 BALCONY F.A.R. AREA (E) | | = 1.513 |
| TOTAL UNIT F.A.R. AREA F = (C + E) | | = 170.944 |
| NON F.A.R. AREA OF BALCONY | | |
| Y1 | 5.040 X 1.500 = 7.560 | |
| Y2 | 6.875 X 1.500 = 10.313 | |
| Y3 | 8.260 X 1.500 = 12.390 | |
| TOTAL AREA (G) = 30.263 | | |
| TOTAL AREA (H) = 0.250 | | |
| TOTAL BALCONY AREA J = (G + H) = 30.513 | | |
| TOTAL 15% SERVICES AREA OF UNIT (K) = 1.561 | | |
| TOTAL UNIT COVERAGE AREA = 207.057 | | |

1/4 F.A.R. AREA OF BALCONY


| R | AREA |
|---|------------------------|
| R1 | 0.300 X 1.850 = 0.555 |
| R2 | 11.805 X 0.300 = 3.542 |
| TOTAL AREA (D) = 4.097 | |
| 1/4 BALCONY F.A.R. AREA (E) = 1.009 | |
| TOTAL UNIT F.A.R. AREA F = (C + E) = 97.188 | |

NON F.A.R. AREA OF BALCONY

| Y | AREA |
|---|-------------------------|
| Y1 | 1.500 X 1.850 = 2.775 |
| Y2 | 11.805 X 1.500 = 17.408 |
| TOTAL AREA (G) = 20.183 | |
| TOTAL AREA (H) = 0.068 | |
| TOTAL BALCONY AREA J = (G + H) = 20.251 | |
| TOTAL 15% SERVICES AREA OF UNIT (K) = 0.967 | |
| TOTAL UNIT COVERAGE AREA = 120.895 | |

15% SERVICES AREA OF UNIT (PLUMBING SHAFT)

| P | AREA |
|---|-----------------------|
| P1 | 0.450 X 0.250 = 0.113 |
| P2 | 0.750 X 0.300 = 0.225 |
| P3 | 0.685 X 0.300 = 0.206 |
| P4 | 0.720 X 0.400 = 0.288 |
| P5 | 1.825 X 0.400 = 0.730 |
| TOTAL 15% SERVICES AREA OF UNIT (K) = 1.561 | |
| TOTAL UNIT COVERAGE AREA = 207.057 | |

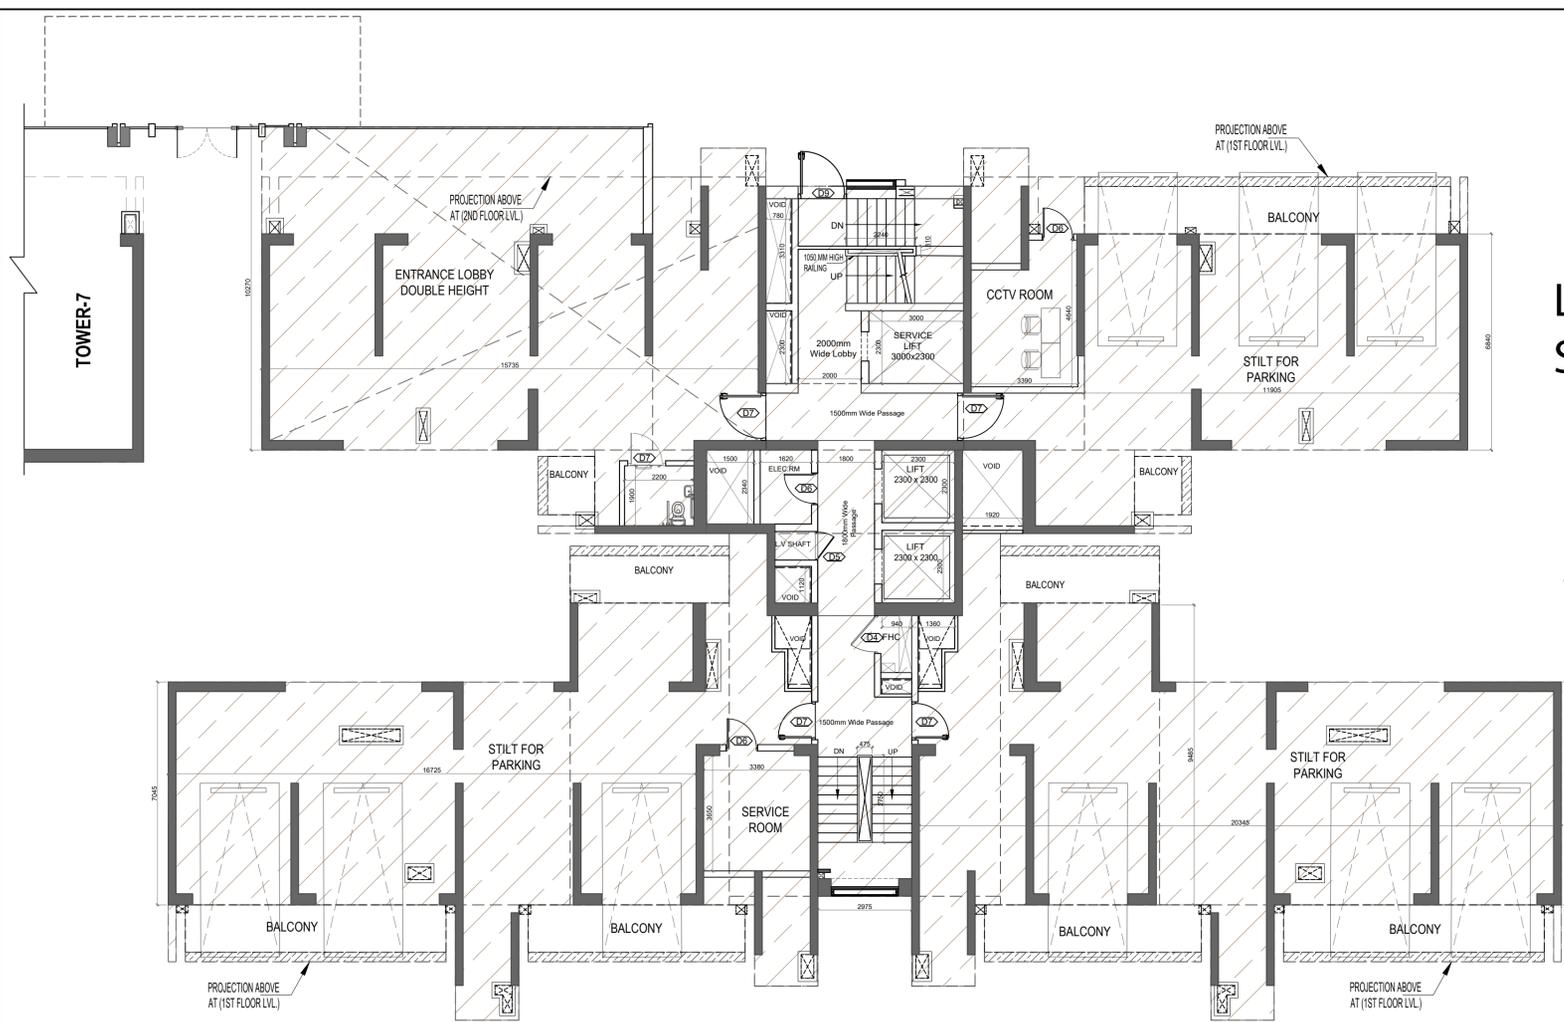


LAL SINGH
 Digitally signed by LAL SINGH
 Date: 2025.01.28
 17:50:28 +05'30'

Amit Varma
 Digitally signed by Amit Varma
 Date: 2025.01.25
 17:11:44 +05'30'

Sudheer Kumar
 Digitally signed by Sudheer Kumar
 Date: 2025.01.28
 14:29:57 +05'30'

GROUND COVERAGE PLAN

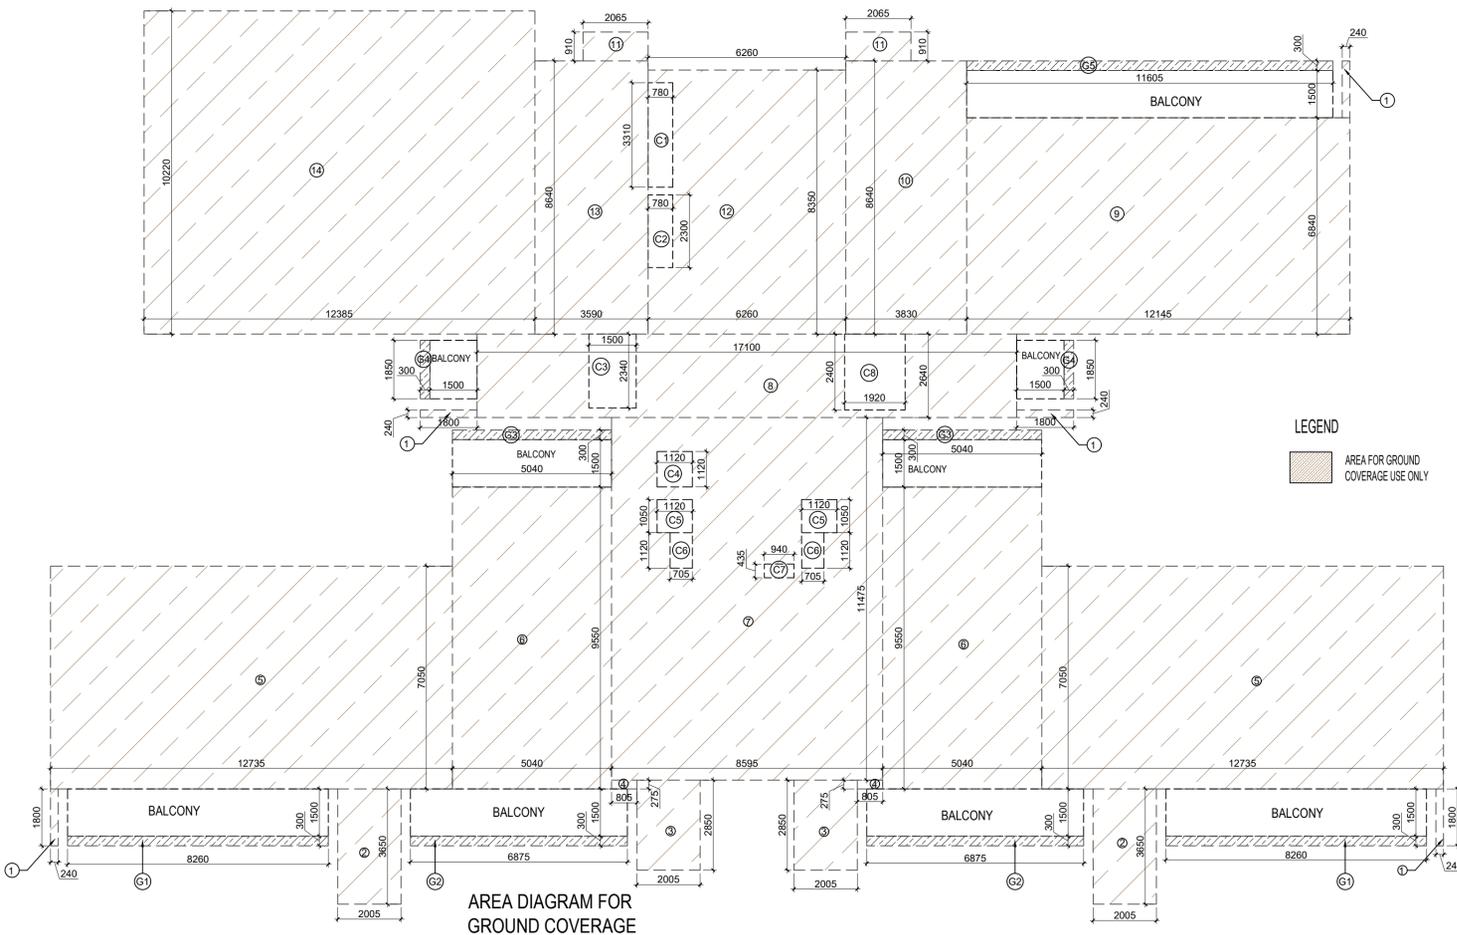

AREA DIAGRAM FOR GROUND COVERAGE

| AREA CALCULATION FOR GROUND COVERAGE | | | | | | |
|--------------------------------------|-------------|---|--------|---|---|----------------|
| S.NO. | PARTICULARS | | | | | AREA (SQMT) |
| 1 | 0.240 | X | 1.800 | X | 5 | = 2.160 |
| 2 | 2.005 | X | 3.650 | X | 2 | = 14.637 |
| 3 | 2.005 | X | 2.850 | X | 2 | = 11.429 |
| 4 | 0.805 | X | 0.275 | X | 2 | = 0.443 |
| 5 | 12.735 | X | 7.050 | X | 2 | = 179.564 |
| 6 | 5.040 | X | 9.550 | X | 2 | = 96.264 |
| 7 | 8.595 | X | 11.475 | | | = 98.628 |
| 8 | 17.100 | X | 2.640 | | | = 45.144 |
| 9 | 12.145 | X | 6.840 | | | = 83.072 |
| 10 | 3.830 | X | 8.640 | | | = 33.091 |
| 11 | 2.065 | X | 0.910 | X | 2 | = 3.758 |
| 12 | 6.260 | X | 8.350 | | | = 52.271 |
| 13 | 3.590 | X | 8.640 | | | = 31.018 |
| 14 | 12.385 | X | 10.220 | | | = 126.575 |
| TOTAL AREA (A) | | | | | | 778.051 |
| Subtraction | | | | | | |
| C1 | 0.780 | X | 3.310 | | | = 2.582 |
| C2 | 0.780 | X | 2.300 | | | = 1.794 |
| C3 | 1.500 | X | 2.340 | | | = 3.510 |
| C4 | 1.120 | X | 1.120 | | | = 1.254 |
| C5 | 1.120 | X | 1.050 | X | 2 | = 2.352 |
| C6 | 0.705 | X | 1.120 | X | 2 | = 1.579 |
| C7 | 0.940 | X | 0.435 | | | = 0.409 |
| C8 | 1.920 | X | 2.400 | | | = 4.608 |
| TOTAL AREA (B) | | | | | | 18.088 |
| TOTAL AREA = C (A-B) | | | | | | 759.963 |

| 1/4 F.A.R AREA OF BALCONY FOR GROUND COVERAGE | | | | | | |
|---|--------|---|-------|---|---|----------------|
| G1 | 8.260 | X | 0.300 | X | 2 | = 4.956 |
| G2 | 6.875 | X | 0.300 | X | 2 | = 4.125 |
| G3 | 5.040 | X | 0.300 | X | 2 | = 3.024 |
| G4 | 0.300 | X | 1.850 | X | 2 | = 1.110 |
| G5 | 11.605 | X | 0.300 | | | = 3.482 |
| TOTAL AREA (D) | | | | | | 16.697 |
| 1/4 BALCONY F.A.R AREA (E) | | | | | | 4.174 |
| TOTAL GROUND COVERAGE AREA F = (C + E) | | | | | | 764.137 |

OWNER SIGN
 Rajat pathak
 2025.01.28 3:12:37:16 +05'30'

ARCHITECT SIGN
 AVANISH SRIVASTAV
 2025.01.23 12:37:24 +05'30'

TOWN PLANNER SIGN

DOOR SCHEDULE

| SL NO | TYPE | OPENING | HEIGHT | WIDTH | LOCATION | DESCRIPTION |
|-------|------|---------|--------|-------|----------|-------------------------------|
| 1 | DOOR | 2100 | 2100 | 2100 | KITCHEN | UPVC FRAME SLIDING GLASS DOOR |
| 2 | DOOR | 2100 | 2100 | 2100 | KITCHEN | UPVC FRAME SLIDING GLASS DOOR |
| 3 | DOOR | 2100 | 2100 | 2100 | KITCHEN | UPVC FRAME SLIDING GLASS DOOR |
| 4 | DOOR | 2100 | 2100 | 2100 | KITCHEN | UPVC FRAME SLIDING GLASS DOOR |
| 5 | DOOR | 2100 | 2100 | 2100 | KITCHEN | UPVC FRAME SLIDING GLASS DOOR |
| 6 | DOOR | 2100 | 2100 | 2100 | KITCHEN | UPVC FRAME SLIDING GLASS DOOR |
| 7 | DOOR | 2100 | 2100 | 2100 | KITCHEN | UPVC FRAME SLIDING GLASS DOOR |
| 8 | DOOR | 2100 | 2100 | 2100 | KITCHEN | UPVC FRAME SLIDING GLASS DOOR |
| 9 | DOOR | 2100 | 2100 | 2100 | KITCHEN | UPVC FRAME SLIDING GLASS DOOR |
| 10 | DOOR | 2100 | 2100 | 2100 | KITCHEN | UPVC FRAME SLIDING GLASS DOOR |
| 11 | DOOR | 2100 | 2100 | 2100 | KITCHEN | UPVC FRAME SLIDING GLASS DOOR |
| 12 | DOOR | 2100 | 2100 | 2100 | KITCHEN | UPVC FRAME SLIDING GLASS DOOR |
| 13 | DOOR | 2100 | 2100 | 2100 | KITCHEN | UPVC FRAME SLIDING GLASS DOOR |
| 14 | DOOR | 2100 | 2100 | 2100 | KITCHEN | UPVC FRAME SLIDING GLASS DOOR |
| 15 | DOOR | 2100 | 2100 | 2100 | KITCHEN | UPVC FRAME SLIDING GLASS DOOR |
| 16 | DOOR | 2100 | 2100 | 2100 | KITCHEN | UPVC FRAME SLIDING GLASS DOOR |
| 17 | DOOR | 2100 | 2100 | 2100 | KITCHEN | UPVC FRAME SLIDING GLASS DOOR |
| 18 | DOOR | 2100 | 2100 | 2100 | KITCHEN | UPVC FRAME SLIDING GLASS DOOR |
| 19 | DOOR | 2100 | 2100 | 2100 | KITCHEN | UPVC FRAME SLIDING GLASS DOOR |
| 20 | DOOR | 2100 | 2100 | 2100 | KITCHEN | UPVC FRAME SLIDING GLASS DOOR |

WINDOW SCHEDULE

| SL NO | TYPE | OPENING | HEIGHT | WIDTH | LOCATION | DESCRIPTION |
|-------|------|---------|--------|-------|----------|---------------------------------|
| 1 | WIN | 1500 | 1500 | 1500 | KITCHEN | UPVC FRAME SLIDING GLASS WINDOW |
| 2 | WIN | 1500 | 1500 | 1500 | KITCHEN | UPVC FRAME SLIDING GLASS WINDOW |
| 3 | WIN | 1500 | 1500 | 1500 | KITCHEN | UPVC FRAME SLIDING GLASS WINDOW |
| 4 | WIN | 1500 | 1500 | 1500 | KITCHEN | UPVC FRAME SLIDING GLASS WINDOW |
| 5 | WIN | 1500 | 1500 | 1500 | KITCHEN | UPVC FRAME SLIDING GLASS WINDOW |
| 6 | WIN | 1500 | 1500 | 1500 | KITCHEN | UPVC FRAME SLIDING GLASS WINDOW |
| 7 | WIN | 1500 | 1500 | 1500 | KITCHEN | UPVC FRAME SLIDING GLASS WINDOW |
| 8 | WIN | 1500 | 1500 | 1500 | KITCHEN | UPVC FRAME SLIDING GLASS WINDOW |
| 9 | WIN | 1500 | 1500 | 1500 | KITCHEN | UPVC FRAME SLIDING GLASS WINDOW |
| 10 | WIN | 1500 | 1500 | 1500 | KITCHEN | UPVC FRAME SLIDING GLASS WINDOW |
| 11 | WIN | 1500 | 1500 | 1500 | KITCHEN | UPVC FRAME SLIDING GLASS WINDOW |
| 12 | WIN | 1500 | 1500 | 1500 | KITCHEN | UPVC FRAME SLIDING GLASS WINDOW |
| 13 | WIN | 1500 | 1500 | 1500 | KITCHEN | UPVC FRAME SLIDING GLASS WINDOW |
| 14 | WIN | 1500 | 1500 | 1500 | KITCHEN | UPVC FRAME SLIDING GLASS WINDOW |
| 15 | WIN | 1500 | 1500 | 1500 | KITCHEN | UPVC FRAME SLIDING GLASS WINDOW |
| 16 | WIN | 1500 | 1500 | 1500 | KITCHEN | UPVC FRAME SLIDING GLASS WINDOW |
| 17 | WIN | 1500 | 1500 | 1500 | KITCHEN | UPVC FRAME SLIDING GLASS WINDOW |
| 18 | WIN | 1500 | 1500 | 1500 | KITCHEN | UPVC FRAME SLIDING GLASS WINDOW |
| 19 | WIN | 1500 | 1500 | 1500 | KITCHEN | UPVC FRAME SLIDING GLASS WINDOW |
| 20 | WIN | 1500 | 1500 | 1500 | KITCHEN | UPVC FRAME SLIDING GLASS WINDOW |

OWNER
 GODREJ PROPERTIES LIMITED

SUBMISSION DRAWING

KEY PLAN

PROJECT
 PROPOSED GROUP HOUSING FOR PLOT NO :- GH-01/B,C,D,E,J & K SECTOR -12, GREATER NOIDA, G.B. NAGAR, (U.P.)

| DATE | PROJECT INCH. | CHECKED BY |
|----------------|---------------|--------------|
| 08 - 01 - 2025 | BALRAJ SINGH | BALRAJ SINGH |

| SCALE | DEALT BY | APPROVED BY |
|-------|-------------|---------------|
| 1:100 | ABDHESH JHA | VISHAL SHARMA |

DRAWING TITLE
 GROUND COVERAGE PLAN

TOWER - 6

ARCHITECTS


GOLDEN INDIA ARCHITECTS
 THE TEAM OF ARCHITECTS
 FF-37, KADAMBA SHOPPING COMPLEX
 GAMMA-IGREATER NOIDA
 CON. +91-94-1585-6777

DESIGN BY:
 Confluence
 NEW DELHI, INDIA

F-1, FIRST FLOOR, MIRA CORPORATE SUITES,
 ISHWAR NAGAR, NEW DELHI 110065

| Ph | +91-11-26925684 | ccs@inconfluence.com | Member of IGBC |
|--------------|-----------------|----------------------|----------------|
| Ph | +91-11-40564768 | www.inconfluence.com | Member of IGBC |
| architecture | urban design | hospitality | interiors |

| DRAWING NO. | S-50 | REVISION |
|-------------|------|----------|
|-------------|------|----------|

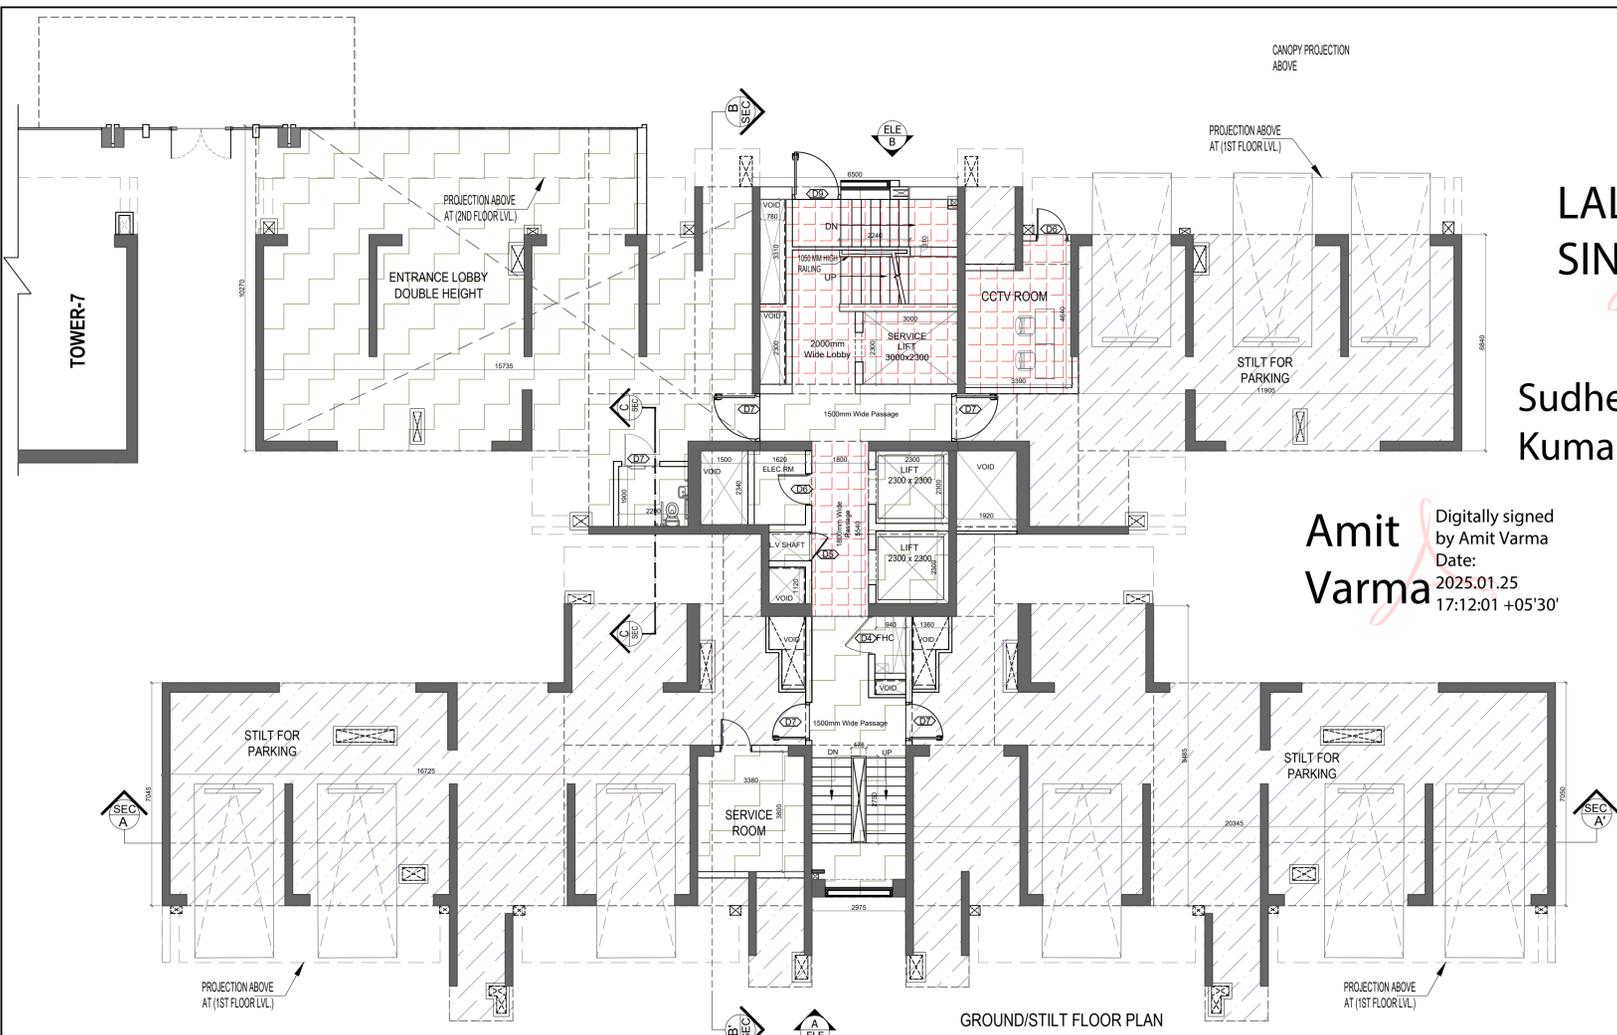


LAL SINGH
Digitally signed by LAL SINGH
Date: 2025.01.27
17:51:45 +05'30'

Sudheer Kumar
Digitally signed by Sudheer Kumar
Date: 2025.01.28
14:30:54 +05'30'

Amit Varma
Digitally signed by Amit Varma
Date: 2025.01.25
17:12:01 +05'30'

GROUND/STILT FLOOR PLAN

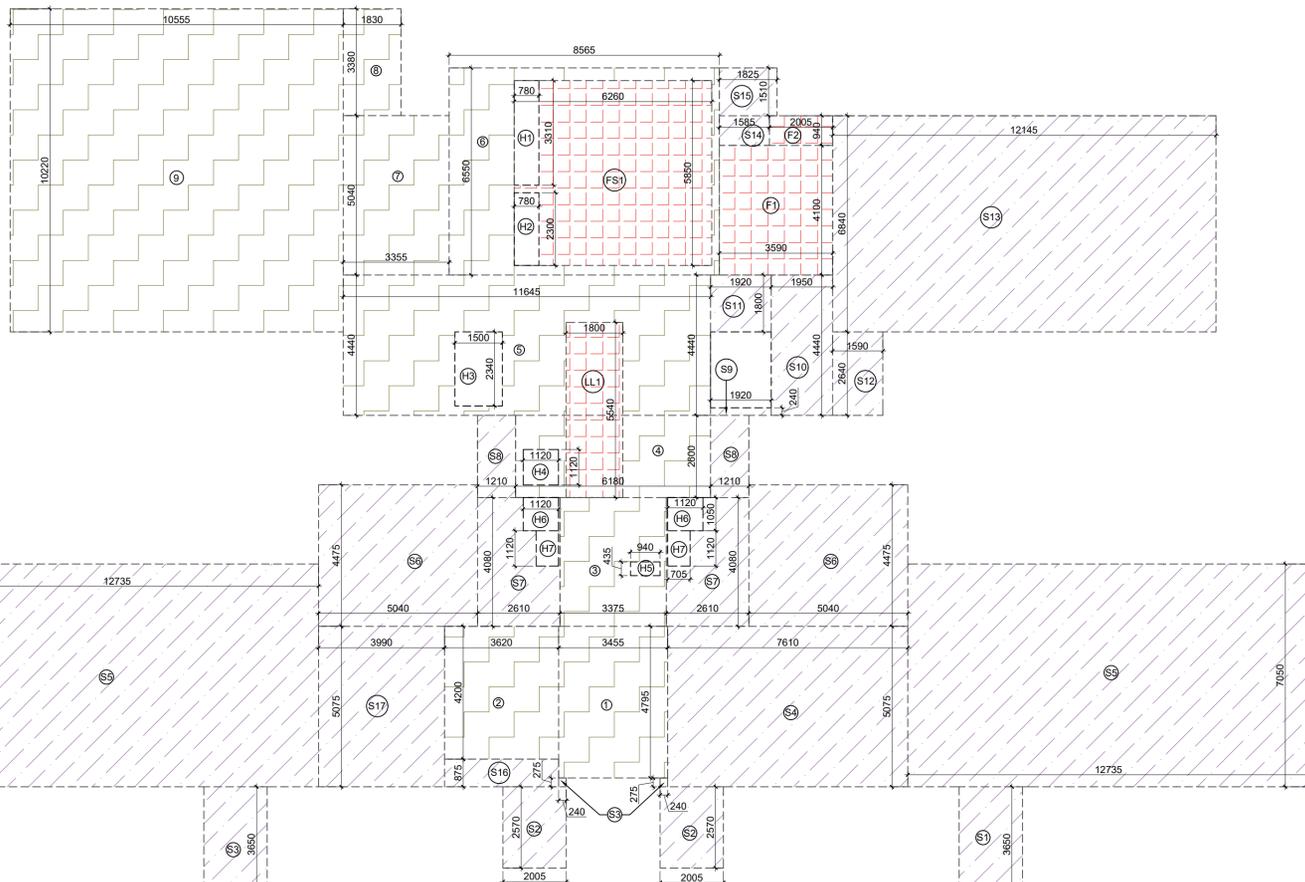

AREA DIAGRAM FOR GROUND FLOOR CIRCULATION & ENTRANCE LOBBY

LEGEND

- F.A.R. AREA
- 15 % SERVICES AREA
- NON F.A.R. AREA
- COUNTED IN 1/4 F.A.R. AREA
- NON F.A.R. AREA STILT
- AREA FOR GROUND COVERAGE USE ONLY

F.A.R. COVERED AREA CALCULATION FOR CIRCULATION AREA AT GROUND FLOOR / STILT LOBBY

| S.NO. | AREA (SQ.M) | AREA (SQ.M) | AREA (SQ.M) | AREA (SQ.M) |
|------------------------------|-------------|-------------|-------------|----------------|
| 1 | 3.455 | X | 4.795 | = 16.567 |
| 2 | 3.620 | X | 4.200 | = 15.204 |
| 3 | 3.375 | X | 4.080 | = 13.770 |
| 4 | 6.180 | X | 2.600 | = 16.068 |
| 5 | 11.645 | X | 4.440 | = 51.704 |
| 6 | 8.565 | X | 6.550 | = 56.101 |
| 7 | 3.355 | X | 5.040 | = 16.909 |
| 8 | 1.830 | X | 3.380 | = 6.185 |
| 9 | 10.555 | X | 10.220 | = 107.872 |
| TOTAL F.A.R. AREA (A) | | | | 300.380 |

AREA SUBTRACTION

| S.NO. | AREA (SQ.M) | AREA (SQ.M) | AREA (SQ.M) | AREA (SQ.M) |
|---|-------------|-------------|-------------|----------------|
| FS1 | 6.260 | X | 5.850 | = 36.621 |
| LL1 | 1.800 | X | 5.540 | = 9.972 |
| H3 | 1.500 | X | 2.340 | = 3.510 |
| H4 | 1.120 | X | 1.120 | = 1.254 |
| H5 | 0.940 | X | 0.435 | = 0.409 |
| TOTAL (B) | | | | 51.766 |
| TOTAL F.A.R. AREA CORRIDOR C = (A - B) | | | | 248.614 |

AREA CALCULATION TOWARDS 15% ADDITIONAL F.A.R. AT GROUND FLOOR / STILT LOBBY

| S.NO. | PARTICULARS | AREA (SQ.M) |
|------------------------|---------------|---------------|
| FIRE TOWER AREA | | |
| FS1 | 6.260 X 5.850 | = 36.621 |
| LIFT LOBBY | | |
| LL1 | 1.800 X 5.540 | = 9.972 |
| CCTV ROOM | | |
| F1 | 3.590 X 4.100 | = 14.719 |
| F2 | 2.005 X 0.940 | = 1.885 |
| TOTAL AREA (D) | | 63.197 |

AREA SUBTRACTION

| S.NO. | AREA (SQ.M) | AREA (SQ.M) | AREA (SQ.M) | AREA (SQ.M) |
|--|-------------|-------------|-------------|---------------|
| H1 | 0.780 | X | 3.310 | = 2.582 |
| H2 | 0.780 | X | 2.300 | = 1.794 |
| TOTAL (E) | | | | 4.376 |
| TOTAL 15% F.A.R. AREA F = (D - E) | | | | 58.821 |

NON F.A.R. AREA CALCULATION FOR GROUND FLOOR / STILT AREA

| S.NO. | AREA (SQ.M) | AREA (SQ.M) | AREA (SQ.M) | AREA (SQ.M) | | |
|-----------------------|-------------|-------------|-------------|----------------|---|-----------|
| S1 | 2.005 | X | 3.650 | X | 2 | = 14.637 |
| S2 | 2.005 | X | 2.570 | X | 2 | = 10.306 |
| S3 | 0.240 | X | 0.275 | X | 2 | = 0.132 |
| S4 | 7.610 | X | 5.075 | X | 2 | = 38.621 |
| S5 | 12.735 | X | 7.050 | X | 2 | = 179.564 |
| S6 | 5.040 | X | 4.475 | X | 2 | = 45.108 |
| S7 | 2.610 | X | 4.080 | X | 2 | = 21.298 |
| S8 | 1.210 | X | 2.600 | X | 2 | = 6.292 |
| S9 | 1.920 | X | 0.240 | X | 2 | = 0.461 |
| S10 | 1.950 | X | 4.440 | X | 2 | = 8.658 |
| S11 | 1.920 | X | 1.800 | X | 2 | = 3.456 |
| S12 | 1.590 | X | 2.640 | X | 2 | = 4.198 |
| S13 | 12.145 | X | 6.840 | X | 2 | = 83.072 |
| S14 | 1.585 | X | 0.940 | X | 2 | = 1.490 |
| S15 | 1.825 | X | 1.510 | X | 2 | = 2.756 |
| S16 | 3.620 | X | 0.875 | X | 2 | = 3.168 |
| S17 | 3.990 | X | 5.075 | X | 2 | = 20.249 |
| TOTAL AREA (G) | | | | 443.463 | | |

AREA SUBTRACTION

| S.NO. | AREA (SQ.M) | AREA (SQ.M) | AREA (SQ.M) | AREA (SQ.M) | | |
|--|-------------|-------------|-------------|----------------|---|---------|
| H6 | 1.120 | X | 1.050 | X | 2 | = 2.352 |
| H7 | 0.705 | X | 1.120 | X | 2 | = 1.579 |
| TOTAL AREA (H) | | | | 3.931 | | |
| TOTAL NON F.A.R. AREA STILT PARKING J = (G - H) | | | | 439.531 | | |

TOTAL F.A.R. AREA AT GROUND FLOOR/STILT LVL.

| S.NO. | PARTICULARS | AREA (SQ.M) |
|--------------------------|---|----------------|
| 1 | F.A.R. AREA OF CIRCULATION & ENTRANCE LOBBY | 248.614 |
| TOTAL F.A.R. AREA | | 248.614 |

TOWER - 6

| | GROUND COVERAGE | F.A.R. AREA | 15 % AREA | STILT NON F.A.R. AREA (PARKING) | NON F.A.R. AREA (BALCONY) |
|---------------------------------|-----------------|------------------|-----------------|---------------------------------|---------------------------|
| GROUND / STILT . FLOOR (F.A.R.) | 764.137 | 248.614 | 58.821 | 439.531 | 0.000 |
| 1ST / PODIUM FLOOR AREA | | 512.518 | 45.369 | | 92.504 |
| 2nd FLOOR AREA | | 630.130 | 46.129 | | 120.441 |
| 3rd FLOOR AREA | | 630.130 | 46.129 | | 120.441 |
| 4th FLOOR AREA | | 630.130 | 46.129 | | 120.441 |
| 5th FLOOR AREA | | 630.130 | 46.129 | | 120.441 |
| 6th FLOOR AREA | | 630.130 | 46.129 | | 120.441 |
| 7th FLOOR AREA | | 630.130 | 46.129 | | 120.441 |
| 8th FLOOR AREA | | 630.130 | 46.129 | | 120.441 |
| 9th FLOOR AREA | | 630.130 | 46.129 | | 120.441 |
| 10th FLOOR AREA | | 630.130 | 46.129 | | 120.441 |
| 11th FLOOR AREA | | 630.130 | 46.129 | | 120.441 |
| 12th FLOOR AREA | | 630.130 | 46.129 | | 120.441 |
| 13th FLOOR AREA | | 630.130 | 46.129 | | 120.441 |
| 14th FLOOR AREA | | 630.130 | 46.129 | | 120.441 |
| 15th FLOOR AREA | | 630.130 | 46.129 | | 120.441 |
| 16th FLOOR AREA | | 630.130 | 46.129 | | 120.441 |
| 17th FLOOR AREA | | 630.130 | 46.129 | | 120.441 |
| 18th FLOOR AREA | | 630.130 | 46.129 | | 120.441 |
| 19th FLOOR AREA (REFUGE FLOOR) | | 592.541 | 89.863 | | 115.387 |
| 20th FLOOR AREA | | 630.130 | 46.129 | | 120.441 |
| 21st FLOOR AREA | | 630.130 | 46.129 | | 120.441 |
| 22nd FLOOR AREA | | 630.130 | 46.129 | | 120.441 |
| 23rd FLOOR AREA | | 630.130 | 46.129 | | 120.441 |
| 24th FLOOR AREA | | 630.130 | 46.129 | | 120.441 |
| TERRACE FLOOR | | 28.375 | 96.517 | | |
| MACHINE ROOM LVL. | | | 58.410 | | |
| O.H TANK LVL. | | | 42.566 | | |
| TOTAL | 764.137 | 15244.903 | 1406.374 | 439.531 | 2857.598 |

OWNER SIGN
Rajat pathak
2025.01.2
3 12:37:44
+05'30'

ARCHITECT SIGN
AVANISH SRIVASTAV
2025.01.23
12:37:53
+05'30'

DOOR SCHEDULE


| SL. NO. | TYPE | OPENING | HEIGHT | W. / L. | LOCATION | DESCRIPTION |
|---------|------|---------|--------|---------|----------|-----------------------|
| 1 | DOOR | 2100 | 2100 | 2100 | LOBBY | UPVC FRAME GLASS DOOR |
| 2 | DOOR | 2100 | 2100 | 2100 | LOBBY | UPVC FRAME GLASS DOOR |
| 3 | DOOR | 2100 | 2100 | 2100 | LOBBY | UPVC FRAME GLASS DOOR |
| 4 | DOOR | 2100 | 2100 | 2100 | LOBBY | UPVC FRAME GLASS DOOR |
| 5 | DOOR | 2100 | 2100 | 2100 | LOBBY | UPVC FRAME GLASS DOOR |
| 6 | DOOR | 2100 | 2100 | 2100 | LOBBY | UPVC FRAME GLASS DOOR |
| 7 | DOOR | 2100 | 2100 | 2100 | LOBBY | UPVC FRAME GLASS DOOR |
| 8 | DOOR | 2100 | 2100 | 2100 | LOBBY | UPVC FRAME GLASS DOOR |
| 9 | DOOR | 2100 | 2100 | 2100 | LOBBY | UPVC FRAME GLASS DOOR |
| 10 | DOOR | 2100 | 2100 | 2100 | LOBBY | UPVC FRAME GLASS DOOR |
| 11 | DOOR | 2100 | 2100 | 2100 | LOBBY | UPVC FRAME GLASS DOOR |
| 12 | DOOR | 2100 | 2100 | 2100 | LOBBY | UPVC FRAME GLASS DOOR |
| 13 | DOOR | 2100 | 2100 | 2100 | LOBBY | UPVC FRAME GLASS DOOR |
| 14 | DOOR | 2100 | 2100 | 2100 | LOBBY | UPVC FRAME GLASS DOOR |
| 15 | DOOR | 2100 | 2100 | 2100 | LOBBY | UPVC FRAME GLASS DOOR |
| 16 | DOOR | 2100 | 2100 | 2100 | LOBBY | UPVC FRAME GLASS DOOR |
| 17 | DOOR | 2100 | 2100 | 2100 | LOBBY | UPVC FRAME GLASS DOOR |
| 18 | DOOR | 2100 | 2100 | 2100 | LOBBY | UPVC FRAME GLASS DOOR |
| 19 | DOOR | 2100 | 2100 | 2100 | LOBBY | UPVC FRAME GLASS DOOR |
| 20 | DOOR | 2100 | 2100 | 2100 | LOBBY | UPVC FRAME GLASS DOOR |

WINDOW SCHEDULE

| SL. NO. | TYPE | OPENING | HEIGHT | W. / L. | LOCATION | DESCRIPTION |
|---------|------|---------|--------|---------|----------|--------------------------------------|
| 1 | WIN | 1500 | 1500 | 1500 | LOBBY | ALUMINIUM UPVC FRAME OPERABLE WINDOW |
| 2 | WIN | 1500 | 1500 | 1500 | LOBBY | ALUMINIUM UPVC FRAME OPERABLE WINDOW |
| 3 | WIN | 1500 | 1500 | 1500 | LOBBY | ALUMINIUM UPVC FRAME OPERABLE WINDOW |
| 4 | WIN | 1500 | 1500 | 1500 | LOBBY | ALUMINIUM UPVC FRAME OPERABLE WINDOW |
| 5 | WIN | 1500 | 1500 | 1500 | LOBBY | ALUMINIUM UPVC FRAME OPERABLE WINDOW |
| 6 | WIN | 1500 | 1500 | 1500 | LOBBY | ALUMINIUM UPVC FRAME OPERABLE WINDOW |
| 7 | WIN | 1500 | 1500 | 1500 | LOBBY | ALUMINIUM UPVC FRAME OPERABLE WINDOW |
| 8 | WIN | 1500 | 1500 | 1500 | LOBBY | ALUMINIUM UPVC FRAME OPERABLE WINDOW |
| 9 | WIN | 1500 | 1500 | 1500 | LOBBY | ALUMINIUM UPVC FRAME OPERABLE WINDOW |
| 10 | WIN | 1500 | 1500 | 1500 | LOBBY | ALUMINIUM UPVC FRAME OPERABLE WINDOW |
| 11 | WIN | 1500 | 1500 | 1500 | LOBBY | ALUMINIUM UPVC FRAME OPERABLE WINDOW |
| 12 | WIN | 1500 | 1500 | 1500 | LOBBY | ALUMINIUM UPVC FRAME OPERABLE WINDOW |
| 13 | WIN | 1500 | 1500 | 1500 | LOBBY | ALUMINIUM UPVC FRAME OPERABLE WINDOW |
| 14 | WIN | 1500 | 1500 | 1500 | LOBBY | ALUMINIUM UPVC FRAME OPERABLE WINDOW |
| 15 | WIN | 1500 | 1500 | 1500 | LOBBY | ALUMINIUM UPVC FRAME OPERABLE WINDOW |
| 16 | WIN | 1500 | 1500 | 1500 | LOBBY | ALUMINIUM UPVC FRAME OPERABLE WINDOW |
| 17 | WIN | 1500 | 1500 | 1500 | LOBBY | ALUMINIUM UPVC FRAME OPERABLE WINDOW |
| 18 | WIN | 1500 | 1500 | 1500 | LOBBY | ALUMINIUM UPVC FRAME OPERABLE WINDOW |
| 19 | WIN | 1500 | 1500 | 1500 | LOBBY | ALUMINIUM UPVC FRAME OPERABLE WINDOW |
| 20 | WIN | 1500 | 1500 | 1500 | LOBBY | ALUMINIUM UPVC FRAME OPERABLE WINDOW |

OWNER
GODREJ PROPERTIES LIMITED

SUBMISSION DRAWING

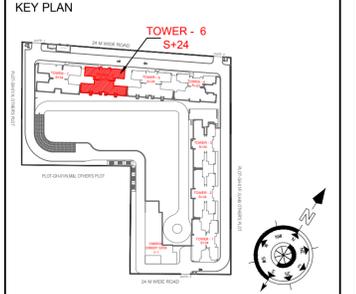

PROJECT
PROPOSED GROUP HOUSING FOR PLOT NO :- GH-01/B,C,D,E,J & K SECTOR -12, GREATER NOIDA, G.B. NAGAR, (U.P.)

| DATE | PROJECT INCH. | CHECKED BY |
|----------------|---------------|---------------|
| 08 - 01 - 2025 | BALRAJ SINGH | BALRAJ SINGH |
| SCALE | DEALT BY | APPROVED BY |
| 1:100 | ABDHESH JHA | VISHAL SHARMA |

DRAWING TITLE
GROUND/STILT FLOOR PLAN

TOWER - 6

ARCHITECTS
GIA
GOLDEN INDIA ARCHITECTS
THE TEAM OF ARCHITECTS
FF-37, KADAMBA SHOPPING COMPLEX
GAMMA-IGREATER NOIDA
CON. + 91-94-1585-6777

DESIGN BY:
Confluence
NEW DELHI, INDIA
F-1, FIRST FLOOR, MIRA CORPORATE SUITES,
ISHWAR NAGAR, NEW DELHI 110065
Ph- +91-11-28925684 ccs@inconfluence.com Member of IGBC
Ph- +91-11-40564768 www.inconfluence.com ISO - 9001:2000
architecture urban design hospitality interiors
DRAWING NO. S-51 **REVISION**


LAL SINGH
Digitally signed by LAL SINGH
Date: 2025.01.27
17:52:06 +05'30'

Sudheer Kumar
Digitally signed by Sudheer Kumar
Date: 2025.01.28
14:31:49 +05'30'

Amit Varma
Digitally signed by Amit Varma
Date: 2025.01.25
17:12:22 +05'30'

OWNER SIGN
Rajat pathak
Rajat pathak
2025.01.23
12:49:11
+05'30'

ARCHITECT SIGN
AVANISH SRIVASTAV
AVANISH SRIVASTAV
2025.01.23
12:49:03
+05'30'

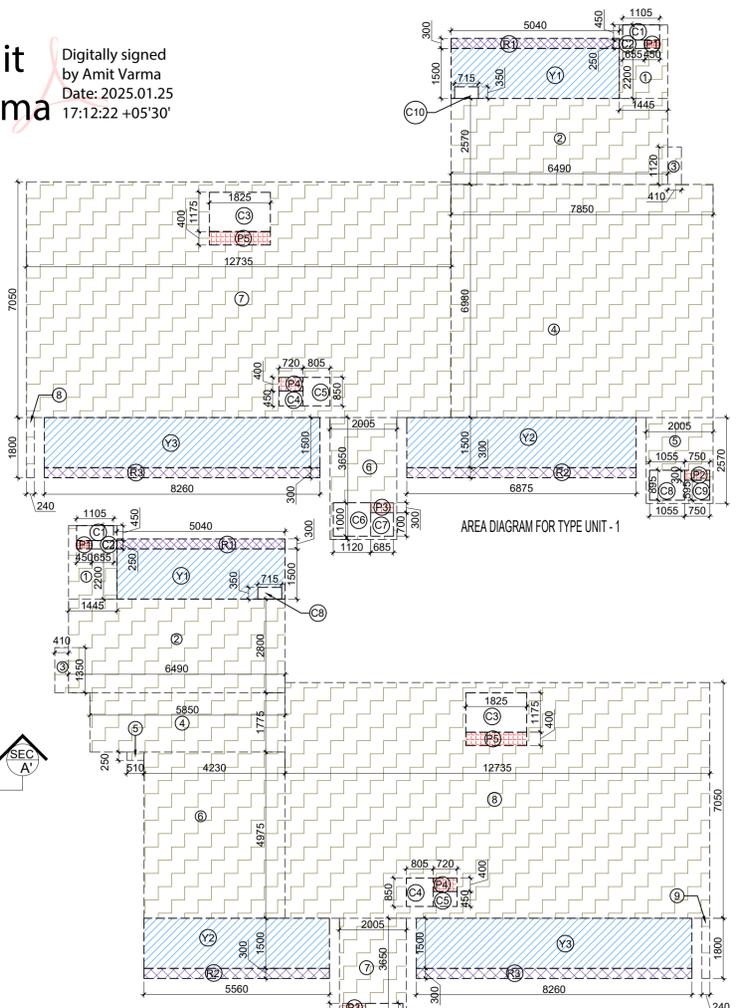

DOOR SCHEDULE

| S.NO. | TYPE | OPENING | HEIGHT | W.C. | LOCATION | DESCRIPTION |
|-------|------|---------|--------|------|----------|-----------------------|
| 1 | DOOR | 2100 | 2100 | 2100 | LIVING | UPVC FRAME GLASS DOOR |
| 2 | DOOR | 2100 | 2100 | 2100 | LIVING | UPVC FRAME GLASS DOOR |
| 3 | DOOR | 2100 | 2100 | 2100 | LIVING | UPVC FRAME GLASS DOOR |
| 4 | DOOR | 2100 | 2100 | 2100 | LIVING | UPVC FRAME GLASS DOOR |
| 5 | DOOR | 2100 | 2100 | 2100 | LIVING | UPVC FRAME GLASS DOOR |
| 6 | DOOR | 2100 | 2100 | 2100 | LIVING | UPVC FRAME GLASS DOOR |
| 7 | DOOR | 2100 | 2100 | 2100 | LIVING | UPVC FRAME GLASS DOOR |
| 8 | DOOR | 2100 | 2100 | 2100 | LIVING | UPVC FRAME GLASS DOOR |
| 9 | DOOR | 2100 | 2100 | 2100 | LIVING | UPVC FRAME GLASS DOOR |
| 10 | DOOR | 2100 | 2100 | 2100 | LIVING | UPVC FRAME GLASS DOOR |
| 11 | DOOR | 2100 | 2100 | 2100 | LIVING | UPVC FRAME GLASS DOOR |
| 12 | DOOR | 2100 | 2100 | 2100 | LIVING | UPVC FRAME GLASS DOOR |
| 13 | DOOR | 2100 | 2100 | 2100 | LIVING | UPVC FRAME GLASS DOOR |
| 14 | DOOR | 2100 | 2100 | 2100 | LIVING | UPVC FRAME GLASS DOOR |
| 15 | DOOR | 2100 | 2100 | 2100 | LIVING | UPVC FRAME GLASS DOOR |
| 16 | DOOR | 2100 | 2100 | 2100 | LIVING | UPVC FRAME GLASS DOOR |
| 17 | DOOR | 2100 | 2100 | 2100 | LIVING | UPVC FRAME GLASS DOOR |
| 18 | DOOR | 2100 | 2100 | 2100 | LIVING | UPVC FRAME GLASS DOOR |
| 19 | DOOR | 2100 | 2100 | 2100 | LIVING | UPVC FRAME GLASS DOOR |
| 20 | DOOR | 2100 | 2100 | 2100 | LIVING | UPVC FRAME GLASS DOOR |

WINDOW SCHEDULE


| S.NO. | TYPE | OPENING | HEIGHT | W.C. | LOCATION | DESCRIPTION |
|-------|--------|---------|--------|------|----------|-------------------------|
| 1 | WINDOW | 1500 | 1500 | 1500 | LIVING | UPVC FRAME GLASS WINDOW |
| 2 | WINDOW | 1500 | 1500 | 1500 | LIVING | UPVC FRAME GLASS WINDOW |
| 3 | WINDOW | 1500 | 1500 | 1500 | LIVING | UPVC FRAME GLASS WINDOW |
| 4 | WINDOW | 1500 | 1500 | 1500 | LIVING | UPVC FRAME GLASS WINDOW |
| 5 | WINDOW | 1500 | 1500 | 1500 | LIVING | UPVC FRAME GLASS WINDOW |
| 6 | WINDOW | 1500 | 1500 | 1500 | LIVING | UPVC FRAME GLASS WINDOW |
| 7 | WINDOW | 1500 | 1500 | 1500 | LIVING | UPVC FRAME GLASS WINDOW |
| 8 | WINDOW | 1500 | 1500 | 1500 | LIVING | UPVC FRAME GLASS WINDOW |
| 9 | WINDOW | 1500 | 1500 | 1500 | LIVING | UPVC FRAME GLASS WINDOW |
| 10 | WINDOW | 1500 | 1500 | 1500 | LIVING | UPVC FRAME GLASS WINDOW |
| 11 | WINDOW | 1500 | 1500 | 1500 | LIVING | UPVC FRAME GLASS WINDOW |
| 12 | WINDOW | 1500 | 1500 | 1500 | LIVING | UPVC FRAME GLASS WINDOW |
| 13 | WINDOW | 1500 | 1500 | 1500 | LIVING | UPVC FRAME GLASS WINDOW |
| 14 | WINDOW | 1500 | 1500 | 1500 | LIVING | UPVC FRAME GLASS WINDOW |
| 15 | WINDOW | 1500 | 1500 | 1500 | LIVING | UPVC FRAME GLASS WINDOW |
| 16 | WINDOW | 1500 | 1500 | 1500 | LIVING | UPVC FRAME GLASS WINDOW |
| 17 | WINDOW | 1500 | 1500 | 1500 | LIVING | UPVC FRAME GLASS WINDOW |
| 18 | WINDOW | 1500 | 1500 | 1500 | LIVING | UPVC FRAME GLASS WINDOW |
| 19 | WINDOW | 1500 | 1500 | 1500 | LIVING | UPVC FRAME GLASS WINDOW |
| 20 | WINDOW | 1500 | 1500 | 1500 | LIVING | UPVC FRAME GLASS WINDOW |

F.A.R. COVERED AREA CALCULATION FOR CIRCULATION AREA

| S.NO. | PARTICULARS | AREA (SQM) |
|-----------------------|---------------|----------------|
| 1 | 6.500 X 8.500 | = 55.250 |
| 2 | 8.500 X 2.540 | = 21.390 |
| 3 | 1.920 X 0.240 | = 0.461 |
| 4 | 5.700 X 2.600 | = 14.820 |
| 5 | 3.460 X 2.175 | = 7.526 |
| 6 | 2.975 X 6.700 | = 19.933 |
| 7 | 0.950 X 2.255 | = 2.142 |
| 8 | 1.050 X 2.025 | = 2.126 |
| 9 | 1.110 X 0.250 | = 0.278 |
| 10 | 3.620 X 4.725 | = 17.105 |
| 11 | 2.005 X 2.575 | = 5.163 |
| TOTAL AREA (A) | | 146.887 |

TOTAL F.A.R. AREA AT FIRST FLOOR/PODIUM LVL

| S.NO. | PARTICULARS | AREA (SQM) |
|--------------------------|----------------------------|----------------|
| 1 | F.A.R. AREA OF UNIT - 1 | 170.944 |
| 2 | F.A.R. AREA OF UNIT - 2 | 121.183 |
| 3 | F.A.R. AREA OF UNIT - 4 | 145.657 |
| 4 | F.A.R. AREA OF CIRCULATION | 74.734 |
| TOTAL F.A.R. AREA | | 512.518 |

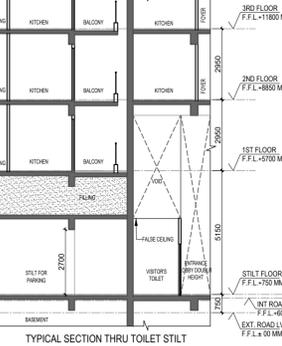

F.A.R. COVERED AREA CALCULATION FOR TYPE UNIT - 1

| S.NO. | PARTICULARS | AREA (SQM) |
|----------------------------|----------------|----------------|
| 1 | 1.445 X 2.200 | = 3.179 |
| 2 | 0.490 X 2.570 | = 1.260 |
| 3 | 0.410 X 1.120 | = 0.459 |
| 4 | 7.800 X 0.980 | = 7.644 |
| 5 | 2.005 X 2.570 | = 5.163 |
| 6 | 3.660 X 3.660 | = 13.396 |
| 7 | 12.735 X 7.650 | = 97.412 |
| 8 | 0.240 X 1.800 | = 0.432 |
| UNIT FAR AREA = (A) | | 177.795 |

F.A.R. COVERED AREA CALCULATION FOR TYPE UNIT - 2


| S.NO. | PARTICULARS | AREA (SQM) |
|----------------------------|----------------|----------------|
| 1 | 1.800 X 0.240 | = 0.432 |
| 2 | 3.540 X 2.640 | = 9.346 |
| 3 | 15.975 X 0.940 | = 15.019 |
| 4 | 2.065 X 2.710 | = 5.606 |
| 5 | 0.240 X 1.800 | = 0.432 |
| UNIT FAR AREA = (A) | | 125.075 |

F.A.R. COVERED AREA CALCULATION FOR TYPE UNIT - 4

| S.NO. | PARTICULARS | AREA (SQM) |
|----------------------------|----------------|----------------|
| 1 | 1.445 X 2.200 | = 3.179 |
| 2 | 0.490 X 2.570 | = 1.260 |
| 3 | 0.410 X 1.120 | = 0.459 |
| 4 | 5.800 X 1.775 | = 10.286 |
| 5 | 0.910 X 0.250 | = 0.228 |
| 6 | 4.230 X 4.975 | = 21.044 |
| 7 | 2.065 X 3.360 | = 6.939 |
| 8 | 12.735 X 7.650 | = 97.412 |
| 9 | 0.240 X 1.800 | = 0.432 |
| UNIT FAR AREA = (A) | | 150.992 |

CORRIDOR AREA CALCULATION TOWARDS 15% ADDITIONAL F.A.R.

| S.NO. | PARTICULARS | AREA (SQM) |
|--|------------------|---------------|
| 1 | FIRE TOWER AREA | 36.621 |
| 2 | LIFT LOBBY | 1.008 |
| 3 | LV SHAFT | 1.008 |
| 4 | F.A.C. SHAFT | 1.692 |
| 5 | ELECTRICAL SHAFT | 4.165 |
| 6 | PLUMBING SHAFT | 0.225 |
| TOTAL CORRIDOR AREA CALCULATION TOWARDS 15% ADDITIONAL F.A.R. (A) | | 53.883 |

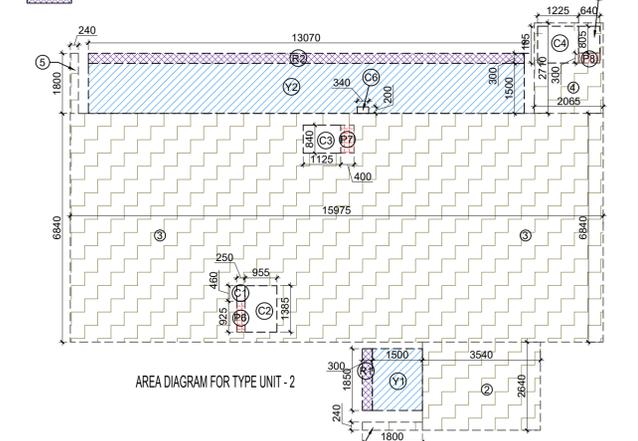

1/4 F.A.R. AREA OF BALCONY


| S.NO. | PARTICULARS | AREA (SQM) |
|-----------------------|---------------|--------------|
| B1 | 0.940 X 0.300 | = 0.282 |
| B2 | 0.875 X 0.300 | = 0.263 |
| B3 | 0.260 X 0.300 | = 0.078 |
| TOTAL AREA (D) | | 0.623 |

1/4 F.A.R. AREA OF BALCONY

| S.NO. | PARTICULARS | AREA (SQM) |
|-----------------------|---------------|--------------|
| B1 | 0.940 X 0.300 | = 0.282 |
| B2 | 0.875 X 0.300 | = 0.263 |
| B3 | 0.260 X 0.300 | = 0.078 |
| TOTAL AREA (D) | | 0.623 |

1/4 F.A.R. AREA OF BALCONY

| S.NO. | PARTICULARS | AREA (SQM) |
|-----------------------|---------------|--------------|
| B1 | 0.940 X 0.300 | = 0.282 |
| B2 | 0.875 X 0.300 | = 0.263 |
| B3 | 0.260 X 0.300 | = 0.078 |
| TOTAL AREA (D) | | 0.623 |

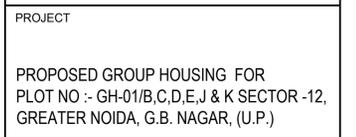

PROPOSED GROUP HOUSING FOR PLOT NO. - GH-01/B.C.D.E.J & K SECTOR-12, GREATER NOIDA, G.B. NAGAR, (U.P.)

DATE 08-01-2025
PROJECT INCH. BALRAJ SINGH
CHECKED BY BALRAJ SINGH

SCALE 1:100
DEALT BY ABDESH JHA
APPROVED BY VISHAL SHARMA

DRAWING TITLE FIRST FLOOR PLAN
TOWER - 6

ARCHITECTS GOLDEN INDIA ARCHITECTS
THE TEAM OF ARCHITECTS
FF-37, KADAMBA SHOPPING COMPLEX
GOMTA-IGREATER NOIDA
CON. +91-94-1585-6777

DESIGN BY: Confluence
NEW DELHI, INDIA
F-1, FIRST FLOOR, MIRA CORPORATE SUITES,
ISHWAR NAGAR, NEW DELHI 110065

DRAWING NO. S-52
REVISION




Sudheer Kumar
Digitally signed by Sudheer Kumar
Date: 2025.01.28
14:32:46 +05'30'

LAL SINGH
Digitally signed by LAL SINGH
Date: 2025.01.27
17:52:19
+05'30'


Amit Varma
Digitally signed by Amit Varma
Date: 2025.01.25
17:12:48 +05'30'

OWNER SIGN
Rajat pathak
2025.01.23
12:38:15
+05'30'

ARCHITECT SIGN
AVANISH SRIVASTAV
H SRIVASTAV
2025.01.23
12:38:07
+05'30'

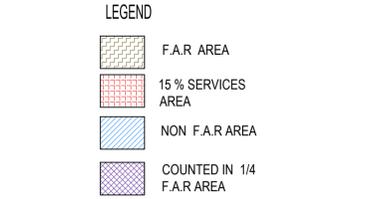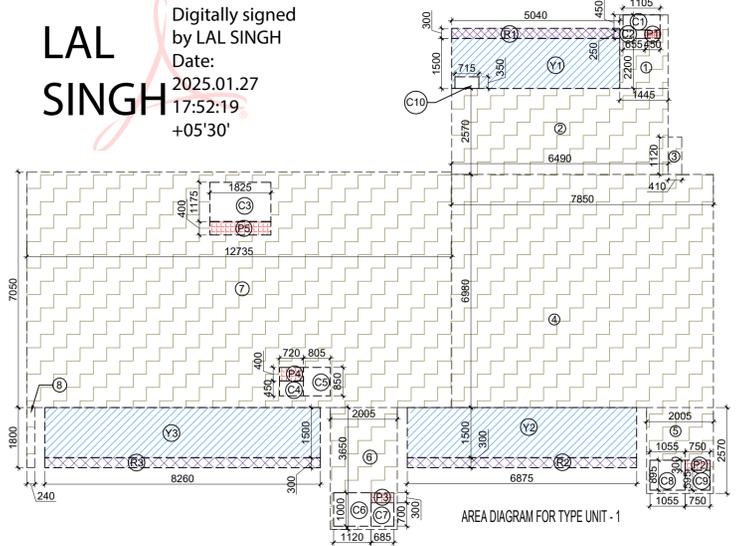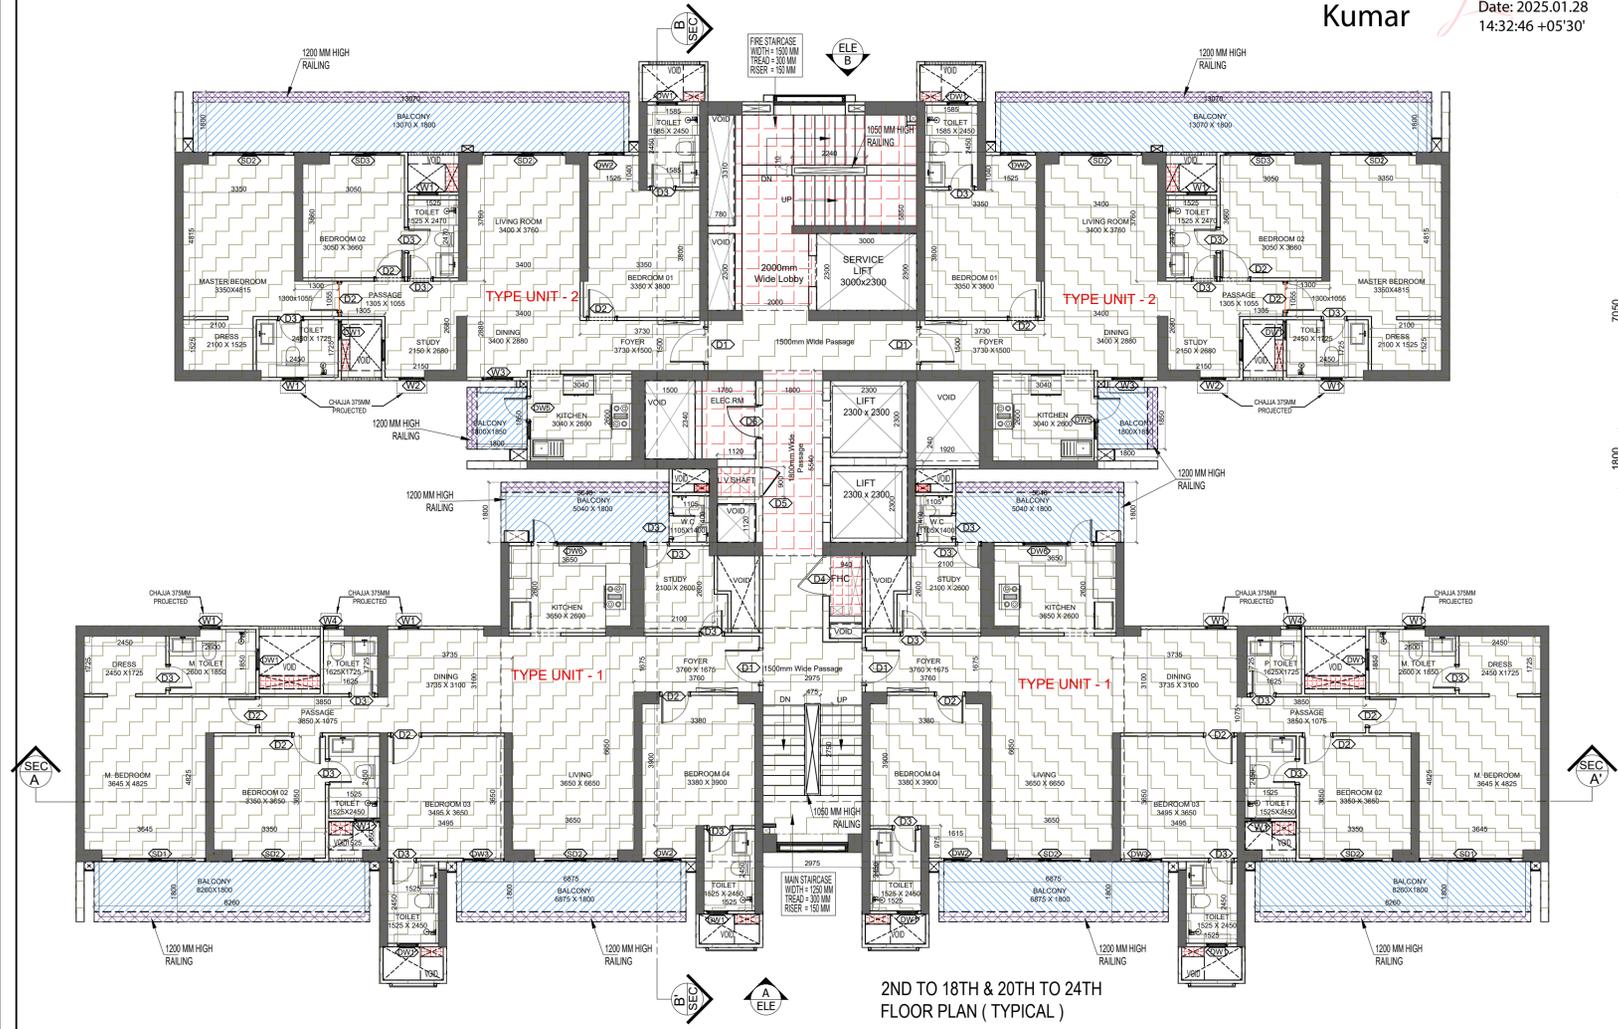

2ND TO 18TH & 20TH TO 24TH FLOOR PLAN (TYPICAL)

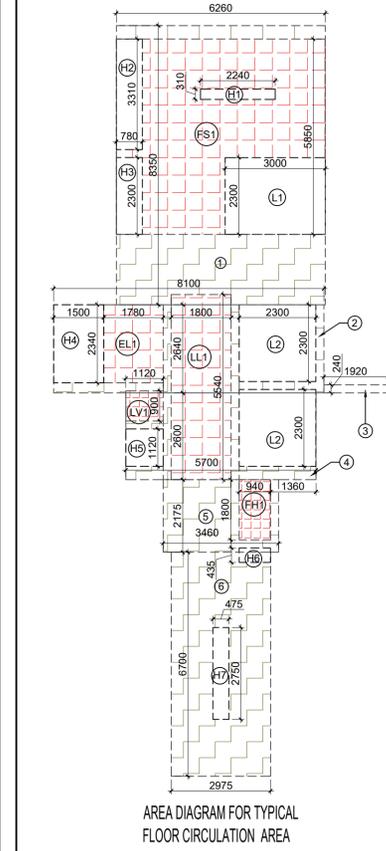


| S.NO. | PARTICULARS | AREA (SQM) |
|---|-------------------|------------------|
| 1 | 6.260 X 8.350 | = 52.271 |
| 2 | 8.100 X 2.540 | = 21.364 |
| 3 | 1.920 X 0.240 | = 0.461 |
| 4 | 5.700 X 2.800 | = 16.820 |
| 5 | 3.460 X 2.175 | = 7.528 |
| 6 | 2.975 X 6.700 | = 19.933 |
| TOTAL AREA (A) | | = 116.394 |
| AREA SUBTRACTION | | |
| FS1 | 6.260 X 5.850 | = 36.821 |
| LL1 | 1.800 X 5.540 | = 9.972 |
| EL1 | 1.780 X 2.340 | = 4.165 |
| LV1 | 1.120 X 0.900 | = 1.008 |
| FH1 | 0.940 X 1.800 | = 1.692 |
| L2 | 2.300 X 2.300 X 2 | = 10.580 |
| H4 | 1.500 X 2.340 | = 3.510 |
| HS | 1.120 X 1.120 | = 1.254 |
| HB | 0.940 X 0.435 | = 0.409 |
| H7 | 0.475 X 2.750 | = 1.308 |
| TOTAL (B) | | = 76.518 |
| TOTAL F.A.R. AREA CORRIDOR C = (A - B) | | = 45.876 |

| S.NO. | PARTICULARS | AREA (SQM) |
|--|-------------------|-----------------|
| FS1 | 6.260 X 5.850 | = 36.821 |
| LL1 | 1.800 X 5.540 | = 9.972 |
| LV1 | 1.120 X 0.900 | = 1.008 |
| FH1 | 0.940 X 1.800 | = 1.692 |
| EL1 | 1.780 X 2.340 | = 4.165 |
| TOTAL CORRIDOR AREA CALCULATION TOWARDS 15% ADDITIONAL F.A.R (A) | | = 53.458 |
| UNIT AREA CALCULATION TOWARDS 15% ADDITIONAL F.A.R | | |
| PLUMBING SHAFT | | |
| P1 | 0.450 X 0.250 X 2 | = 0.225 |
| P2 | 0.750 X 0.300 X 2 | = 0.450 |
| P3 | 0.685 X 0.300 X 2 | = 0.411 |
| P4 | 0.720 X 0.400 X 2 | = 0.576 |
| P5 | 1.825 X 0.400 X 2 | = 1.460 |
| P6 | 0.250 X 0.925 X 2 | = 0.463 |
| P7 | 0.400 X 0.840 X 2 | = 0.672 |
| P8 | 0.640 X 0.300 X 2 | = 0.384 |
| TOTAL UNIT AREA CALCULATION TOWARDS 15% ADDITIONAL F.A.R (B) | | = 4.641 |
| TOTAL 15% ADDITIONAL F.A.R AREA (CORRIDOR AREA+UNIT AREA) = C (A+B) | | = 58.099 |
| AREA SUBTRACTION | | |
| H1 | 2.240 X 0.310 | = 0.694 |
| H2 | 0.780 X 3.310 | = 2.582 |
| H3 | 0.780 X 2.300 | = 1.794 |
| LL1 | 3.000 X 2.300 | = 6.900 |
| TOTAL AREA (D) | | = 11.970 |
| TOTAL 15% ADDITIONAL F.A.R AREA E = (C - D) | | = 46.129 |

| S.NO. | PARTICULARS | AREA (SQM) |
|----------------------------|-------------|------------------|
| F.A.R. AREA OF UNIT - 1 | 2 X 170.944 | = 341.888 |
| F.A.R. AREA OF UNIT - 2 | 2 X 121.183 | = 242.366 |
| F.A.R. AREA OF CIRCULATION | 1 X 45.876 | = 45.876 |
| TOTAL F.A.R. AREA | | = 630.130 |

| S.NO. | PARTICULARS | AREA (SQM) |
|---------------------------|-------------|------------------|
| UNIT - 1 | 34.552 X 2 | = 69.103 |
| UNIT - 2 | 25.669 X 2 | = 51.338 |
| TOTAL BALCONY AREA | | = 120.441 |

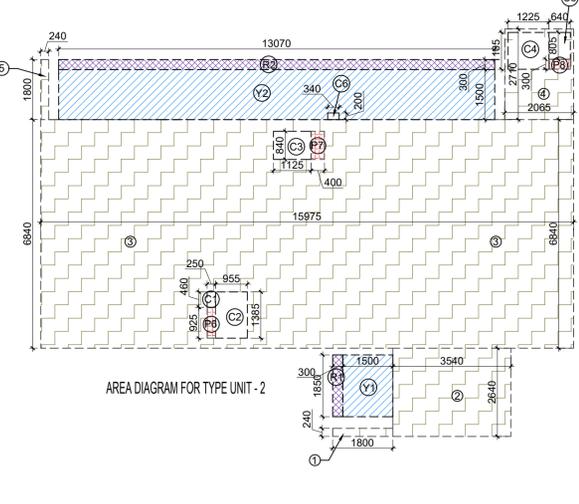

| S.NO. | PARTICULARS | AREA (SQM) |
|---|----------------|------------------|
| 1 | 1.800 X 0.240 | = 0.432 |
| 2 | 3.540 X 2.640 | = 9.348 |
| 3 | 15.975 X 6.840 | = 109.269 |
| 4 | 2.065 X 2.710 | = 5.596 |
| 5 | 0.240 X 1.800 | = 0.432 |
| UNIT FAR AREA = (A) | | = 125.075 |
| AREA SUBTRACTION PLUMBING CUTOUT | | |
| P6 | 0.250 X 0.925 | = 0.231 |
| P7 | 0.400 X 0.840 | = 0.336 |
| P8 | 0.640 X 0.300 | = 0.192 |
| C1 | 0.250 X 0.450 | = 0.112 |
| C2 | 0.955 X 1.385 | = 1.323 |
| C3 | 1.125 X 0.840 | = 0.945 |
| C4 | 1.225 X 1.105 | = 1.354 |
| C5 | 0.640 X 0.805 | = 0.515 |
| TOTAL (B) | | = 5.011 |
| TOTAL F.A.R. AREA C = (A - B) | | = 120.064 |

| S.NO. | PARTICULARS | AREA (SQM) |
|---|----------------|------------------|
| R1 | 0.300 X 1.850 | = 0.555 |
| R2 | 13.070 X 0.300 | = 3.921 |
| TOTAL AREA (D) | | = 4.476 |
| 1/4 BALCONY F.A.R. AREA (E) | | = 1.119 |
| TOTAL UNIT F.A.R. AREA F = (C+E) | | = 121.183 |

| S.NO. | PARTICULARS | AREA (SQM) |
|---------------------------------------|----------------|-----------------|
| Y1 | 1.500 X 1.850 | = 2.775 |
| Y2 | 13.070 X 1.500 | = 19.605 |
| 3/4 AREA OF BALCONY (D - E) | | = 3.357 |
| TOTAL AREA (G) | | = 25.737 |
| AREA SUBTRACTION | | |
| C6 | 0.340 X 0.200 | = 0.068 |
| TOTAL AREA (H) | | = 0.068 |
| TOTAL BALCONY AREA J = (G - H) | | = 25.669 |

| S.NO. | PARTICULARS | AREA (SQM) |
|---|-------------------------------|----------------|
| P6 | 0.250 X 0.925 | = 0.231 |
| P7 | 0.400 X 0.840 | = 0.336 |
| P8 | 0.640 X 0.300 | = 0.192 |
| P4 | 0.720 X 0.400 | = 0.288 |
| P5 | 1.825 X 0.400 | = 0.730 |
| TOTAL 15% SERVICES AREA OF UNIT (PLUMBING SHAFT) (K) | | = 0.759 |
| COVERAGE AREA FOR UNIT = (F+J+K) | | |
| 1 | TOTAL UNIT F.A.R. AREA (F) | = 121.183 |
| 2 | NON FAR AREA OF UNIT (J) | = 25.669 |
| 3 | 15% SERVICES AREA OF UNIT (K) | = 0.759 |
| TOTAL UNIT COVERAGE AREA | | 147.611 |

| S.NO. | PARTICULARS | AREA (SQM) |
|---|----------------|------------------|
| 1 | 1.445 X 2.200 | = 3.179 |
| 2 | 5.490 X 2.570 | = 16.679 |
| 3 | 0.410 X 1.120 | = 0.459 |
| 4 | 7.850 X 6.980 | = 54.793 |
| 5 | 2.005 X 2.570 | = 5.153 |
| 6 | 2.005 X 3.650 | = 7.318 |
| 7 | 12.735 X 7.050 | = 89.782 |
| 8 | 0.240 X 1.800 | = 0.432 |
| UNIT FAR AREA = (A) | | = 177.795 |
| AREA SUBTRACTION PLUMBING CUTOUT | | |
| P1 | 0.450 X 0.250 | = 0.113 |
| P2 | 0.750 X 0.300 | = 0.225 |
| P3 | 0.685 X 0.300 | = 0.206 |
| P4 | 0.720 X 0.400 | = 0.288 |
| P5 | 1.825 X 0.400 | = 0.730 |
| C1 | 1.105 X 0.450 | = 0.497 |
| C2 | 0.655 X 0.250 | = 0.164 |
| C3 | 1.825 X 1.175 | = 2.144 |
| C4 | 0.720 X 0.450 | = 0.324 |
| C5 | 0.805 X 0.650 | = 0.524 |
| C8 | 1.120 X 1.000 | = 1.120 |
| C7 | 0.885 X 0.700 | = 0.619 |
| C8 | 1.055 X 0.895 | = 0.944 |
| C9 | 0.750 X 0.595 | = 0.446 |
| TOTAL (B) | | = 8.365 |
| TOTAL F.A.R. AREA C = (A - B) | | = 169.431 |

| S.NO. | PARTICULARS | AREA (SQM) |
|---|---------------|------------------|
| R1 | 5.040 X 0.300 | = 1.512 |
| R2 | 6.875 X 0.300 | = 2.063 |
| R3 | 8.260 X 0.300 | = 2.478 |
| TOTAL AREA (D) | | = 6.853 |
| 1/4 BALCONY F.A.R. AREA (E) | | = 1.513 |
| TOTAL UNIT F.A.R. AREA F = (C+E) | | = 170.944 |

| S.NO. | PARTICULARS | AREA (SQM) |
|---------------------------------------|---------------|-----------------|
| Y1 | 5.040 X 1.500 | = 7.560 |
| Y2 | 6.875 X 1.500 | = 10.313 |
| Y3 | 8.260 X 1.500 | = 12.390 |
| 3/4 AREA OF BALCONY (D - E) | | = 4.539 |
| TOTAL AREA (G) | | = 34.802 |
| AREA SUBTRACTION | | |
| C10 | 0.715 X 0.350 | = 0.250 |
| TOTAL AREA (H) | | = 0.250 |
| TOTAL BALCONY AREA J = (G - H) | | = 34.552 |


| S.NO. | PARTICULARS | AREA (SQM) |
|---|-------------------------------|----------------|
| P1 | 0.450 X 0.250 | = 0.113 |
| P2 | 0.750 X 0.300 | = 0.225 |
| P3 | 0.685 X 0.300 | = 0.206 |
| P4 | 0.720 X 0.400 | = 0.288 |
| P5 | 1.825 X 0.400 | = 0.730 |
| TOTAL 15% SERVICES AREA OF UNIT (PLUMBING SHAFT) (K) | | = 1.561 |
| COVERAGE AREA FOR UNIT = (F+J+K) | | |
| 1 | TOTAL UNIT F.A.R. AREA (F) | = 170.944 |
| 2 | NON FAR AREA OF UNIT (J) | = 34.552 |
| 3 | 15% SERVICES AREA OF UNIT (K) | = 1.561 |
| TOTAL UNIT COVERAGE AREA | | 207.057 |

| DOOR SCHEDULE | NO. | TYPE | OPENING | LEVEL | LOCATION | DESCRIPTION |
|---------------|-----|------|---------|-------|----------|-----------------------|
| 1 | D01 | 2100 | 2100 | 2100 | LIVING | UPVC FRAME GLASS DOOR |
| 2 | D02 | 1500 | 2100 | 2100 | LIVING | UPVC FRAME GLASS DOOR |
| 3 | D03 | 1100 | 2100 | 2100 | LIVING | UPVC FRAME GLASS DOOR |
| 4 | D04 | 1100 | 2100 | 2100 | LIVING | UPVC FRAME GLASS DOOR |
| 5 | D05 | 1100 | 2100 | 2100 | LIVING | UPVC FRAME GLASS DOOR |
| 6 | D06 | 1100 | 2100 | 2100 | LIVING | UPVC FRAME GLASS DOOR |
| 7 | D07 | 1100 | 2100 | 2100 | LIVING | UPVC FRAME GLASS DOOR |
| 8 | D08 | 1100 | 2100 | 2100 | LIVING | UPVC FRAME GLASS DOOR |
| 9 | D09 | 1100 | 2100 | 2100 | LIVING | UPVC FRAME GLASS DOOR |
| 10 | D10 | 1100 | 2100 | 2100 | LIVING | UPVC FRAME GLASS DOOR |
| 11 | D11 | 1100 | 2100 | 2100 | LIVING | UPVC FRAME GLASS DOOR |
| 12 | D12 | 1100 | 2100 | 2100 | LIVING | UPVC FRAME GLASS DOOR |
| 13 | D13 | 1100 | 2100 | 2100 | LIVING | UPVC FRAME GLASS DOOR |
| 14 | D14 | 1100 | 2100 | 2100 | LIVING | UPVC FRAME GLASS DOOR |
| 15 | D15 | 1100 | 2100 | 2100 | LIVING | UPVC FRAME GLASS DOOR |
| 16 | D16 | 1100 | 2100 | 2100 | LIVING | UPVC FRAME GLASS DOOR |
| 17 | D17 | 1100 | 2100 | 2100 | LIVING | UPVC FRAME GLASS DOOR |
| 18 | D18 | 1100 | 2100 | 2100 | LIVING | UPVC FRAME GLASS DOOR |
| 19 | D19 | 1100 | 2100 | 2100 | LIVING | UPVC FRAME GLASS DOOR |
| 20 | D20 | 1100 | 2100 | 2100 | LIVING | UPVC FRAME GLASS DOOR |

| WINDOW SCHEDULE | NO. | TYPE | OPENING | LEVEL | LOCATION | DESCRIPTION |
|-----------------|-----|------|---------|-------|----------|-------------------------|
| 1 | W01 | 1500 | 1500 | 1500 | TOILET | UPVC FRAME GLASS WINDOW |
| 2 | W02 | 1500 | 1500 | 1500 | TOILET | UPVC FRAME GLASS WINDOW |
| 3 | W03 | 1500 | 1500 | 1500 | TOILET | UPVC FRAME GLASS WINDOW |
| 4 | W04 | 1500 | 1500 | 1500 | TOILET | UPVC FRAME GLASS WINDOW |
| 5 | W05 | 1500 | 1500 | 1500 | TOILET | UPVC FRAME GLASS WINDOW |
| 6 | W06 | 1500 | 1500 | 1500 | TOILET | UPVC FRAME GLASS WINDOW |
| 7 | W07 | 1500 | 1500 | 1500 | TOILET | UPVC FRAME GLASS WINDOW |
| 8 | W08 | 1500 | 1500 | 1500 | TOILET | UPVC FRAME GLASS WINDOW |
| 9 | W09 | 1500 | 1500 | 1500 | TOILET | UPVC FRAME GLASS WINDOW |
| 10 | W10 | 1500 | 1500 | 1500 | TOILET | UPVC FRAME GLASS WINDOW |
| 11 | W11 | 1500 | 1500 | 1500 | TOILET | UPVC FRAME GLASS WINDOW |
| 12 | W12 | 1500 | 1500 | 1500 | TOILET | UPVC FRAME GLASS WINDOW |
| 13 | W13 | 1500 | 1500 | 1500 | TOILET | UPVC FRAME GLASS WINDOW |
| 14 | W14 | 1500 | 1500 | 1500 | TOILET | UPVC FRAME GLASS WINDOW |
| 15 | W15 | 1500 | 1500 | 1500 | TOILET | UPVC FRAME GLASS WINDOW |
| 16 | W16 | 1500 | 1500 | 1500 | TOILET | UPVC FRAME GLASS WINDOW |
| 17 | W17 | 1500 | 1500 | 1500 | TOILET | UPVC FRAME GLASS WINDOW |
| 18 | W18 | 1500 | 1500 | 1500 | TOILET | UPVC FRAME GLASS WINDOW |
| 19 | W19 | 1500 | 1500 | 1500 | TOILET | UPVC FRAME GLASS WINDOW |
| 20 | W20 | 1500 | 1500 | 1500 | TOILET | UPVC FRAME GLASS WINDOW |

OWNER
GODREJ PROPERTIES LIMITED

SUBMISSION DRAWING

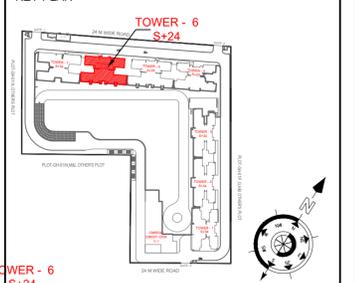

PROPOSED GROUP HOUSING FOR PLOT NO. :- GH-01/B,C,D,E,J & K SECTOR -12, GREATER NOIDA, G.B. NAGAR, (U.P.)

| DATE | PROJECT INCH. | CHECKED BY |
|----------------|---------------|---------------|
| 08 - 01 - 2025 | BALRAJ SINGH | BALRAJ SINGH |
| SCALE | DEALT BY | APPROVED BY |
| 1:100 | ADRESH JHA | VISHAL SHARMA |

DRAWING TITLE
2ND TO 18TH & 20TH TO 24TH FLOOR PLAN (TYPICAL)

TOWER - 6


ARCHITECTS
GOLDEN INDIA ARCHITECTS
THE TEAM OF ARCHITECTS
FF-37, KADAMBA SHOPPING COMPLEX
GAMMA-IGREATER NOIDA
CON. +91-94-1585-6777

DESIGN BY:
Confluence
NEW DELHI, INDIA
F-1, FIRST FLOOR, MIRA CORPORATE SUITES,
ISHWAR NAGAR, NEW DELHI 110065
Ph: +91-11-26925684 cs@confluence.com Member of IGBC
P: +91-11-40564768 www.confluence.com ISO: 9001:2000
architecture urban design hospitality interiors
DRAWING NO. S-53 REVISION

Sudheer Kumar Digitally signed by Sudheer Kumar
Date: 2025.01.28 14:33:48 +05'30'

LAL SINGH Digitally signed by LAL SINGH
Date: 2025.01.27 17:52:31 +05'30'

Amit Varma Digitally signed by Amit Varma
Date: 2025.01.25 17:13:14 +05'30'

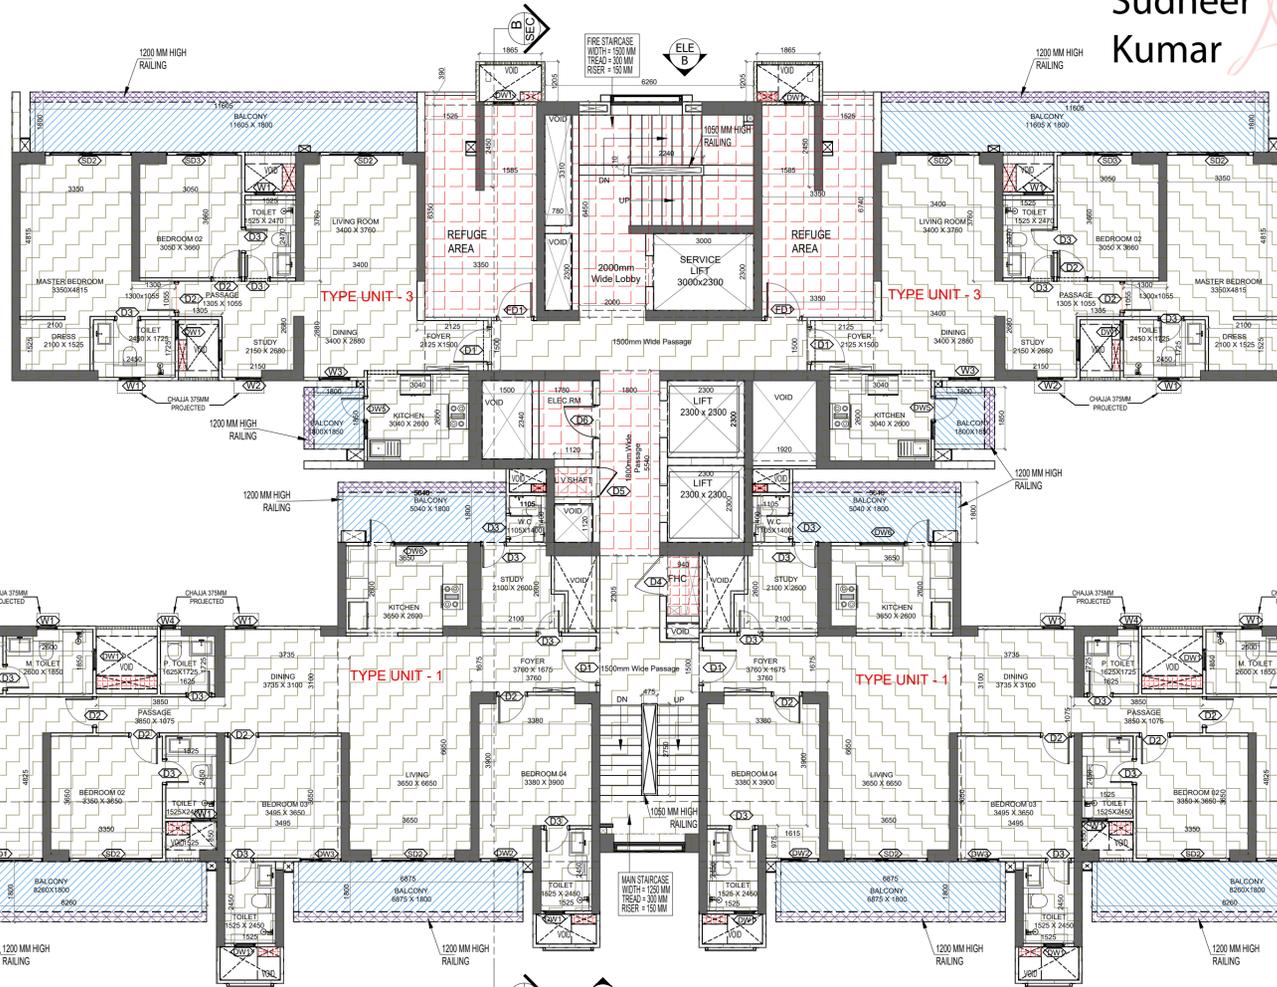

19TH FLOOR PLAN (REFUGE)


REFUGUE AREA REQUIRED -
796.700 SQMTR (BLDG. PLATE) X 2 FLOORS X 0.3
= 478.020 /12.5 + 0.8 SQM (for spec.able)
= 39.142 SQM. SAY. 40.00 SQM.
REFUGUE AREA PROPOSED = 43.735 SQM

LEGEND

- F.A.R. AREA
- 15% SERVICES AREA
- NON F.A.R. AREA
- COUNTED IN 1/4 F.A.R. AREA

| S.NO. | PARTICULARS | AREA (SQMT) |
|--------------------------|----------------------------|----------------|
| 1 | F.A.R. AREA OF UNIT - 1 | 170.944 |
| 2 | F.A.R. AREA OF UNIT - 3 | 97.188 |
| 3 | F.A.R. AREA OF CIRCULATION | 56.282 |
| TOTAL F.A.R. AREA | | 592.541 |

| S.NO. | PARTICULARS | AREA (SQMT) |
|---------------------------|-------------|----------------|
| 1 | UNIT - 1 | 34.552 |
| 2 | UNIT - 3 | 23.142 |
| TOTAL BALCONY AREA | | 115.387 |

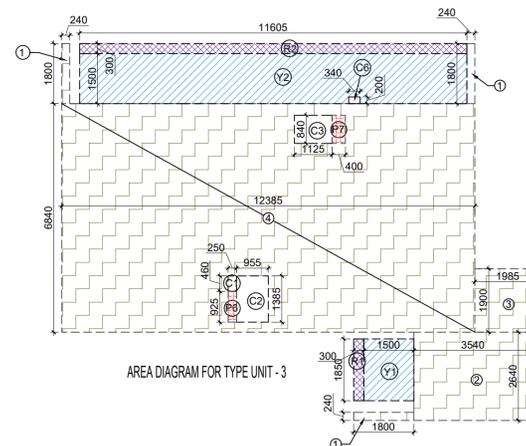

AREA DIAGRAM FOR TYPE UNIT - 3

| S.NO. | PARTICULARS | AREA (SQMT) |
|---|-------------------|---------------|
| 1 | 1.800 X 0.240 X 3 | 1.296 |
| 2 | 3.540 X 2.640 | 9.348 |
| 3 | 1.985 X 1.900 | 3.772 |
| 4 | 12.385 X 6.840 | 84.713 |
| UNIT FAR AREA = (A) | | 99.127 |
| AREA SUBTRACTION PLUMBING CUTOFF | | |
| P6 | 0.250 X 0.925 | 0.231 |
| P7 | 0.400 X 0.840 | 0.336 |
| C1 | 0.250 X 0.450 | 0.113 |
| C2 | 0.955 X 1.385 | 1.323 |
| C3 | 1.125 X 0.840 | 0.945 |
| TOTAL (B) | | 2.950 |
| TOTAL F.A.R. AREA C = (A - B) | | 96.177 |
| 1/4 F.A.R. AREA OF BALCONY | | |
| R1 | 0.300 X 1.850 | 0.555 |
| R2 | 11.805 X 0.300 | 3.542 |
| TOTAL AREA (D) | | 4.037 |
| 1/4 BALCONY F.A.R. AREA (E) | | 1.009 |
| TOTAL UNIT F.A.R. AREA F = (C + E) | | 97.188 |


| S.NO. | PARTICULARS | AREA (SQMT) |
|---|-------------------------------|----------------|
| 1 | 1.500 X 1.850 | 2.775 |
| 2 | 11.805 X 1.500 | 17.408 |
| TOTAL AREA (G) | | 23.210 |
| AREA SUBTRACTION | | |
| C4 | 0.340 X 0.200 | 0.068 |
| TOTAL AREA (H) | | 23.142 |
| TOTAL BALCONY AREA J = (G - H) | | 23.142 |
| 15% SERVICES AREA OF UNIT (PLUMBING SHAFT) | | |
| P8 | 0.250 X 0.925 | 0.231 |
| P9 | 0.400 X 0.840 | 0.336 |
| P4 | 0.720 X 0.400 | 0.288 |
| P5 | 1.825 X 0.400 | 0.730 |
| TOTAL 15% SERVICES AREA OF UNIT (K) | | 0.567 |
| COVERAGE AREA FOR UNIT = (F + J + K) | | |
| 1 | TOTAL UNIT F.A.R. AREA (F) | 97.188 |
| 2 | NON FAR AREA OF UNIT (J) | 23.142 |
| 3 | 15% SERVICES AREA OF UNIT (K) | 0.567 |
| TOTAL UNIT COVERAGE AREA | | 120.895 |

| S.NO. | PARTICULARS | AREA (SQMT) |
|---|-------------------------------|----------------|
| 1 | 1.445 X 2.200 | 3.179 |
| 2 | 6.490 X 2.570 | 16.679 |
| 3 | 0.410 X 1.120 | 0.459 |
| 4 | 7.850 X 6.980 | 54.793 |
| 5 | 2.205 X 2.570 | 5.653 |
| 6 | 2.205 X 3.650 | 7.318 |
| 7 | 12.735 X 7.050 | 89.782 |
| 8 | 0.240 X 1.800 | 0.432 |
| UNIT FAR AREA = (A) | | 177.795 |
| AREA SUBTRACTION PLUMBING CUTOFF | | |
| P1 | 0.450 X 0.250 | 0.113 |
| P2 | 0.750 X 0.300 | 0.225 |
| P3 | 0.685 X 0.300 | 0.206 |
| P4 | 0.720 X 0.400 | 0.288 |
| P5 | 1.825 X 0.400 | 0.730 |
| C1 | 1.105 X 0.450 | 0.497 |
| C2 | 0.655 X 0.250 | 0.164 |
| C3 | 1.825 X 1.175 | 2.144 |
| C4 | 0.720 X 0.450 | 0.324 |
| C5 | 0.805 X 0.850 | 0.684 |
| C6 | 1.120 X 1.000 | 1.120 |
| C7 | 0.685 X 0.700 | 0.480 |
| C8 | 1.055 X 0.895 | 0.944 |
| C9 | 0.750 X 0.555 | 0.416 |
| TOTAL (B) | | 8.365 |
| TOTAL F.A.R. AREA C = (A - B) | | 169.431 |
| 1/4 F.A.R. AREA OF BALCONY | | |
| R1 | 5.040 X 0.300 | 1.512 |
| R2 | 6.875 X 0.300 | 2.063 |
| R3 | 8.260 X 0.300 | 2.478 |
| TOTAL AREA (D) | | 6.053 |
| 1/4 BALCONY F.A.R. AREA (E) | | 1.513 |
| TOTAL UNIT F.A.R. AREA F = (C + E) | | 170.944 |
| NON F.A.R. AREA OF BALCONY | | |
| Y1 | 5.040 X 1.500 | 7.560 |
| Y2 | 6.875 X 1.500 | 10.313 |
| Y3 | 8.260 X 1.500 | 12.390 |
| 3/4 AREA OF BALCONY (D - E) | | 4.539 |
| TOTAL AREA (G) | | 34.802 |
| AREA SUBTRACTION | | |
| C10 | 0.715 X 0.350 | 0.250 |
| TOTAL AREA (H) | | 34.552 |
| TOTAL BALCONY AREA J = (G - H) | | 34.552 |
| 15% SERVICES AREA OF UNIT (PLUMBING SHAFT) | | |
| P1 | 0.450 X 0.250 | 0.113 |
| P2 | 0.750 X 0.300 | 0.225 |
| P3 | 0.685 X 0.300 | 0.206 |
| P4 | 0.720 X 0.400 | 0.288 |
| P5 | 1.825 X 0.400 | 0.730 |
| TOTAL 15% SERVICES AREA OF UNIT (K) | | 1.561 |
| COVERAGE AREA FOR UNIT = (F + J + K) | | |
| 1 | TOTAL UNIT F.A.R. AREA (F) | 170.944 |
| 2 | NON FAR AREA OF UNIT (J) | 34.552 |
| 3 | 15% SERVICES AREA OF UNIT (K) | 1.561 |
| TOTAL UNIT COVERAGE AREA | | 207.057 |

| S.NO. | PARTICULARS | AREA (SQMT) |
|---|-------------------|---------------|
| 1 | 1.800 X 0.240 X 3 | 1.296 |
| 2 | 3.540 X 2.640 | 9.348 |
| 3 | 1.985 X 1.900 | 3.772 |
| 4 | 12.385 X 6.840 | 84.713 |
| UNIT FAR AREA = (A) | | 99.127 |
| AREA SUBTRACTION PLUMBING CUTOFF | | |
| P6 | 0.250 X 0.925 | 0.231 |
| P7 | 0.400 X 0.840 | 0.336 |
| C1 | 0.250 X 0.450 | 0.113 |
| C2 | 0.955 X 1.385 | 1.323 |
| C3 | 1.125 X 0.840 | 0.945 |
| TOTAL (B) | | 2.950 |
| TOTAL F.A.R. AREA C = (A - B) | | 96.177 |
| 1/4 F.A.R. AREA OF BALCONY | | |
| R1 | 0.300 X 1.850 | 0.555 |
| R2 | 11.805 X 0.300 | 3.542 |
| TOTAL AREA (D) | | 4.037 |
| 1/4 BALCONY F.A.R. AREA (E) | | 1.009 |
| TOTAL UNIT F.A.R. AREA F = (C + E) | | 97.188 |

| S.NO. | PARTICULARS | AREA (SQMT) |
|---|-------------------------------|----------------|
| 1 | 1.500 X 1.850 | 2.775 |
| 2 | 11.805 X 1.500 | 17.408 |
| TOTAL AREA (G) | | 23.210 |
| AREA SUBTRACTION | | |
| C4 | 0.340 X 0.200 | 0.068 |
| TOTAL AREA (H) | | 23.142 |
| TOTAL BALCONY AREA J = (G - H) | | 23.142 |
| 15% SERVICES AREA OF UNIT (PLUMBING SHAFT) | | |
| P8 | 0.250 X 0.925 | 0.231 |
| P9 | 0.400 X 0.840 | 0.336 |
| P4 | 0.720 X 0.400 | 0.288 |
| P5 | 1.825 X 0.400 | 0.730 |
| TOTAL 15% SERVICES AREA OF UNIT (K) | | 0.567 |
| COVERAGE AREA FOR UNIT = (F + J + K) | | |
| 1 | TOTAL UNIT F.A.R. AREA (F) | 97.188 |
| 2 | NON FAR AREA OF UNIT (J) | 23.142 |
| 3 | 15% SERVICES AREA OF UNIT (K) | 0.567 |
| TOTAL UNIT COVERAGE AREA | | 120.895 |

| S.NO. | PARTICULARS | AREA (SQMT) |
|---|-------------------------------|----------------|
| 1 | 1.445 X 2.200 | 3.179 |
| 2 | 6.490 X 2.570 | 16.679 |
| 3 | 0.410 X 1.120 | 0.459 |
| 4 | 7.850 X 6.980 | 54.793 |
| 5 | 2.205 X 2.570 | 5.653 |
| 6 | 2.205 X 3.650 | 7.318 |
| 7 | 12.735 X 7.050 | 89.782 |
| 8 | 0.240 X 1.800 | 0.432 |
| UNIT FAR AREA = (A) | | 177.795 |
| AREA SUBTRACTION PLUMBING CUTOFF | | |
| P1 | 0.450 X 0.250 | 0.113 |
| P2 | 0.750 X 0.300 | 0.225 |
| P3 | 0.685 X 0.300 | 0.206 |
| P4 | 0.720 X 0.400 | 0.288 |
| P5 | 1.825 X 0.400 | 0.730 |
| C1 | 1.105 X 0.450 | 0.497 |
| C2 | 0.655 X 0.250 | 0.164 |
| C3 | 1.825 X 1.175 | 2.144 |
| C4 | 0.720 X 0.450 | 0.324 |
| C5 | 0.805 X 0.850 | 0.684 |
| C6 | 1.120 X 1.000 | 1.120 |
| C7 | 0.685 X 0.700 | 0.480 |
| C8 | 1.055 X 0.895 | 0.944 |
| C9 | 0.750 X 0.555 | 0.416 |
| TOTAL (B) | | 8.365 |
| TOTAL F.A.R. AREA C = (A - B) | | 169.431 |
| 1/4 F.A.R. AREA OF BALCONY | | |
| R1 | 5.040 X 0.300 | 1.512 |
| R2 | 6.875 X 0.300 | 2.063 |
| R3 | 8.260 X 0.300 | 2.478 |
| TOTAL AREA (D) | | 6.053 |
| 1/4 BALCONY F.A.R. AREA (E) | | 1.513 |
| TOTAL UNIT F.A.R. AREA F = (C + E) | | 170.944 |
| NON F.A.R. AREA OF BALCONY | | |
| Y1 | 5.040 X 1.500 | 7.560 |
| Y2 | 6.875 X 1.500 | 10.313 |
| Y3 | 8.260 X 1.500 | 12.390 |
| 3/4 AREA OF BALCONY (D - E) | | 4.539 |
| TOTAL AREA (G) | | 34.802 |
| AREA SUBTRACTION | | |
| C10 | 0.715 X 0.350 | 0.250 |
| TOTAL AREA (H) | | 34.552 |
| TOTAL BALCONY AREA J = (G - H) | | 34.552 |
| 15% SERVICES AREA OF UNIT (PLUMBING SHAFT) | | |
| P1 | 0.450 X 0.250 | 0.113 |
| P2 | 0.750 X 0.300 | 0.225 |
| P3 | 0.685 X 0.300 | 0.206 |
| P4 | 0.720 X 0.400 | 0.288 |
| P5 | 1.825 X 0.400 | 0.730 |
| TOTAL 15% SERVICES AREA OF UNIT (K) | | 1.561 |
| COVERAGE AREA FOR UNIT = (F + J + K) | | |
| 1 | TOTAL UNIT F.A.R. AREA (F) | 170.944 |
| 2 | NON FAR AREA OF UNIT (J) | 34.552 |
| 3 | 15% SERVICES AREA OF UNIT (K) | 1.561 |
| TOTAL UNIT COVERAGE AREA | | 207.057 |

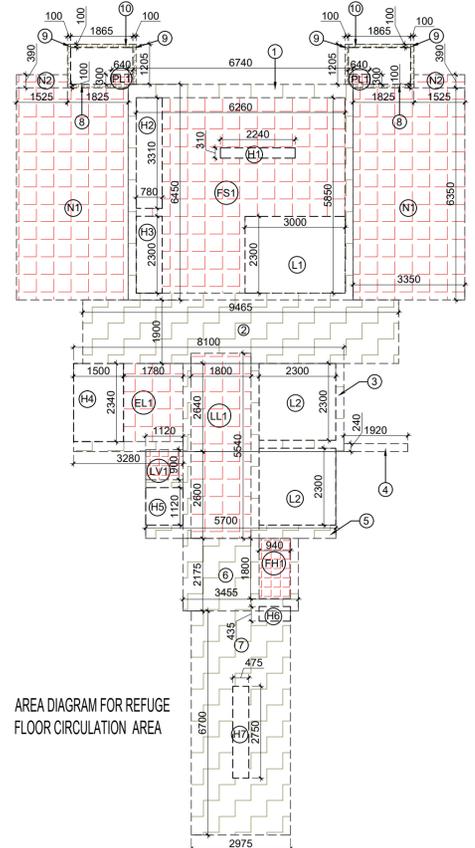

AREA DIAGRAM FOR REFUGE FLOOR CIRCULATION AREA

| S.NO. | PARTICULARS | AREA (SQMT) |
|---|-------------------|----------------|
| 1 | 6.740 X 8.450 | 56.817 |
| 2 | 5.465 X 1.500 | 8.198 |
| 3 | 8.100 X 2.640 | 21.384 |
| 4 | 1.520 X 0.240 | 0.365 |
| 5 | 5.700 X 2.650 | 15.008 |
| 6 | 3.450 X 2.175 | 7.508 |
| 7 | 2.975 X 6.700 | 19.933 |
| 8 | 1.825 X 0.100 X 2 | 0.365 |
| 9 | 0.100 X 1.205 X 4 | 0.482 |
| 10 | 1.855 X 0.100 X 2 | 0.371 |
| TOTAL AREA (A) | | 128.799 |
| AREA SUBTRACTION | | |
| FS1 | 6.250 X 5.850 | 36.521 |
| LL1 | 1.800 X 5.540 | 9.972 |
| EL1 | 1.780 X 2.340 | 4.165 |
| LV1 | 1.120 X 1.950 | 2.184 |
| FH1 | 0.940 X 1.800 | 1.692 |
| L2 | 2.300 X 2.300 X 2 | 10.580 |
| IH | 1.500 X 2.340 | 3.510 |
| HS | 0.120 X 1.250 | 0.150 |
| HE | 0.540 X 0.435 | 0.233 |
| H7 | 0.475 X 2.750 | 1.306 |
| TOTAL (B) | | 78.518 |
| TOTAL F.A.R. AREA CORRIDOR C = (A - B) | | 50.282 |

| S.NO. | PARTICULARS | AREA (SQMT) |
|---|-------------------|---------------|
| 1 | 6.250 X 5.850 | 36.521 |
| 2 | 1.800 X 5.540 | 9.972 |
| 3 | 1.780 X 2.340 | 4.165 |
| 4 | 1.120 X 1.950 | 2.184 |
| 5 | 0.940 X 1.800 | 1.692 |
| 6 | 2.300 X 2.300 X 2 | 10.580 |
| 7 | 1.500 X 2.340 | 3.510 |
| 8 | 0.120 X 1.250 | 0.150 |
| 9 | 0.540 X 0.435 | 0.233 |
| 10 | 0.475 X 2.750 | 1.306 |
| TOTAL (B) | | 78.518 |
| TOTAL F.A.R. AREA CORRIDOR C = (A - B) | | 50.282 |
| UNIT AREA CALCULATION TOWARDS 15% ADDITIONAL F.A.R. | | |
| PLUMBING SHAFT | | |
| P1 | 0.450 X 0.250 X 2 | 0.225 |
| P2 | 0.750 X 0.300 X 2 | 0.450 |
| P3 | 0.685 X 0.300 X 2 | 0.412 |
| P4 | 0.720 X 0.400 X 2 | 0.576 |
| P5 | 1.825 X 0.400 X 2 | 1.460 |
| P6 | 0.250 X 0.925 X 2 | 0.462 |
| P7 | 0.400 X 0.840 X 2 | 0.672 |
| TOTAL UNIT AREA CALCULATION TOWARDS 15% ADDITIONAL F.A.R. (B) | | 4.297 |
| TOTAL 15% ADDITIONAL F.A.R. AREA (CORRIDOR AREA + UNIT AREA) = (A + B) | | 54.579 |
| AREA SUBTRACTION | | |
| H1 | 2.240 X 0.310 | 0.694 |
| H2 | 0.780 X 3.310 | 2.582 |
| H3 | 0.780 X 2.300 | 1.794 |
| LT | 3.000 X 2.500 | 7.500 |
| TOTAL AREA (D) | | 11.970 |
| TOTAL 15% ADDITIONAL F.A.R. AREA E = (C - D) | | 42.609 |

OWNER SIGN: **Rajat pathak** 2025.01.2 3 12:38:31 +05'30'

ARCHITECT SIGN: **AVANI SRIVASTAV** 2025.01.23 12:38:40 +05'30'

OWNER: **GODREJ PROPERTIES LIMITED**

SUBMISSION DRAWING: **TOWER - 6**

KEY PLAN: **TOWER - 6 S+24**

PROPOSED GROUP HOUSING FOR PLOT NO. :- GH-01/B,C,D,E,J & K SECTOR -12

M.R.M & O.H.T TOP TERRACE
T.O.S. LVL.+83700 MM

MUMTY TERRACE LVL
T.O.S. LVL.+79300 MM

TERRACE
T.O.S. LVL.+76650 MM

24TH FLOOR FFL.
+73750 MM

23RD FLOOR FFL.
+70800 MM

22ND FLOOR FFL.
+67850 MM

21ST FLOOR FFL.
+64900MM

20TH FLOOR FFL.
+61950 MM

19TH FLOOR FFL.
REFUGE FLOOR
+59000 MM

18TH FLOOR FFL.
+56050 MM

17TH FLOOR FFL.
+53100 MM

16TH FLOOR FFL.
+50150 MM

15TH FLOOR FFL.
+47200 MM

14TH FLOOR FFL.
+44250 MM

13TH FLOOR FFL.
+41300 MM

12TH FLOOR FFL.
+38350 MM

11TH FLOOR FFL.
+35400 MM

10TH FLOOR FFL.
+32450 MM

9TH FLOOR FFL.
+29500 MM

8TH FLOOR FFL.
+26550 MM

7TH FLOOR FFL.
+23600 MM

6TH FLOOR FFL.
+20650 MM

5TH FLOOR FFL.
+17700 MM

4TH FLOOR FFL.
+14750 MM

3RD FLOOR FFL.
+11800 MM

2ND FLOOR FFL.
+8850 MM

1ST FLOOR FFL.
+5900 MM

PODIUM SLAB
F.F.L.+4400 MM

TOWER LOBBY FL.
+900 MM

STILT FLOOR FFL.(PARKING)
+750 MM

EXT. ROAD LVL
F.L.± 00 MM

INT. ROAD LVL
F.L.+ 600 MM

BASEMENT FFL.(PARKING)
F.L.-5000 MM

LAL SINGH

Digitally signed by LAL SINGH
Date: 2025.01.27
17:54:15
+05'30'

Sudheer Kumar

Digitally signed by Sudheer Kumar
Date: 2025.01.28
14:39:04 +05'30'

Amit Varma
Digitally signed by Amit Varma
Date: 2025.01.25
17:16:23 +05'30'



SECTION - B-B'

| | | | |
|---|-------------------------------|--|--|
| OWNER SIGN Rajat pathak Rajat pathak 2025.01.23 12:40:48 +05'30' | | ARCHITECT SIGN AVANISH SRIVASTAV AVANISH SRIVASTAV 2025.01.23 12:40:56 +05'30' | |
| TOWN PLANNER SIGN | | | |
| OWNER GODREJ PROPERTIES LIMITED | | | |
| SUBMISSION DRAWING | | | |
| KEY PLAN TOWER - 5&6 S+24 | | | |
| PROJECT PROPOSED GROUP HOUSING FOR PLOT NO :- GH-01/B,C,D,E,J & K SECTOR -12, GREATER NOIDA, G.B. NAGAR, (U.P.) | | | |
| DATE 08 - 01 - 2025 | PROJECT INCH. BALRAJ SINGH | CHECKED BY BALRAJ SINGH | |
| SCALE 1:100 | DEALT BY ABDRESH JHA | APPROVED BY VISHAL SHARMA | |
| DRAWING TITLE SECTION - B-B' | | | |
| TOWER - 5 & 6 | | | |
| ARCHITECTS GOLDEN INDIA ARCHITECTS THE TEAM OF ARCHITECTS FF-37, KADAMBA SHOPPING COMPLEX GAMMA-IGREATER NOIDA CON...+91-94-1585-6777 | | | |
| DESIGN BY: Confluence NEW DELHI, INDIA F-1, FIRST FLOOR, MIRA CORPORATE SUITES, ISHWAR NAGAR, NEW DELHI 110055 Ph: +91-11-26925684 ccs@confluence.com Member of IGBC Ph: +91-11-40564768 www.confluence.com ISO - 9001 : 2000 architecture urban design hospitality interiors | | | |
| DRAWING NO. S-59 | | REVISION | |

TOWN PLANNER SIGN

DOOR SCHEDULE


| S.NO. | TYPE | OPENING | HEIGHT | W.DTH | LEVEL | LOCATION | DESCRIPTION |
|-------|------|---------|--------|-------|-------|----------|-----------------------|
| 1 | DOOR | 2000 | 2000 | 2000 | 2000 | ENTRANCE | UPVC FRAME GLASS DOOR |
| 2 | DOOR | 2000 | 2000 | 2000 | 2000 | ENTRANCE | UPVC FRAME GLASS DOOR |
| 3 | DOOR | 2000 | 2000 | 2000 | 2000 | ENTRANCE | UPVC FRAME GLASS DOOR |
| 4 | DOOR | 2000 | 2000 | 2000 | 2000 | ENTRANCE | UPVC FRAME GLASS DOOR |
| 5 | DOOR | 2000 | 2000 | 2000 | 2000 | ENTRANCE | UPVC FRAME GLASS DOOR |
| 6 | DOOR | 2000 | 2000 | 2000 | 2000 | ENTRANCE | UPVC FRAME GLASS DOOR |
| 7 | DOOR | 2000 | 2000 | 2000 | 2000 | ENTRANCE | UPVC FRAME GLASS DOOR |
| 8 | DOOR | 2000 | 2000 | 2000 | 2000 | ENTRANCE | UPVC FRAME GLASS DOOR |
| 9 | DOOR | 2000 | 2000 | 2000 | 2000 | ENTRANCE | UPVC FRAME GLASS DOOR |
| 10 | DOOR | 2000 | 2000 | 2000 | 2000 | ENTRANCE | UPVC FRAME GLASS DOOR |
| 11 | DOOR | 2000 | 2000 | 2000 | 2000 | ENTRANCE | UPVC FRAME GLASS DOOR |
| 12 | DOOR | 2000 | 2000 | 2000 | 2000 | ENTRANCE | UPVC FRAME GLASS DOOR |

WINDOW SCHEDULE

| S.NO. | TYPE | OPENING | HEIGHT | W.DTH | LEVEL | LOCATION | DESCRIPTION |
|-------|--------|---------|--------|-------|-------|----------|-------------------------|
| 1 | WINDOW | 1500 | 1500 | 1500 | 1500 | ENTRANCE | UPVC FRAME GLASS WINDOW |
| 2 | WINDOW | 1500 | 1500 | 1500 | 1500 | ENTRANCE | UPVC FRAME GLASS WINDOW |
| 3 | WINDOW | 1500 | 1500 | 1500 | 1500 | ENTRANCE | UPVC FRAME GLASS WINDOW |
| 4 | WINDOW | 1500 | 1500 | 1500 | 1500 | ENTRANCE | UPVC FRAME GLASS WINDOW |
| 5 | WINDOW | 1500 | 1500 | 1500 | 1500 | ENTRANCE | UPVC FRAME GLASS WINDOW |
| 6 | WINDOW | 1500 | 1500 | 1500 | 1500 | ENTRANCE | UPVC FRAME GLASS WINDOW |
| 7 | WINDOW | 1500 | 1500 | 1500 | 1500 | ENTRANCE | UPVC FRAME GLASS WINDOW |
| 8 | WINDOW | 1500 | 1500 | 1500 | 1500 | ENTRANCE | UPVC FRAME GLASS WINDOW |
| 9 | WINDOW | 1500 | 1500 | 1500 | 1500 | ENTRANCE | UPVC FRAME GLASS WINDOW |
| 10 | WINDOW | 1500 | 1500 | 1500 | 1500 | ENTRANCE | UPVC FRAME GLASS WINDOW |
| 11 | WINDOW | 1500 | 1500 | 1500 | 1500 | ENTRANCE | UPVC FRAME GLASS WINDOW |
| 12 | WINDOW | 1500 | 1500 | 1500 | 1500 | ENTRANCE | UPVC FRAME GLASS WINDOW |

OWNER: GODREJ PROPERTIES LIMITED

SUBMISSION DRAWING

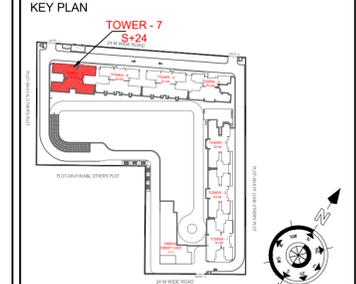

PROJECT: PROPOSED GROUP HOUSING FOR PLOT NO :- GH-01/B,C,D,E,J & K SECTOR -12, GREATER NOIDA, G.B. NAGAR, (U.P.)

| DATE | PROJECT INCH. | CHECKED BY |
|------------|---------------|---------------|
| 08-01-2025 | BALRAJ SINGH | BALRAJ SINGH |
| SCALE | DEALT BY | APPROVED BY |
| 1:100 | ABDHESH JHA | VISHAL SHARMA |

DRAWING TITLE: GROUND/STILT FLOOR PLAN

TOWER - 7

ARCHITECTS: GOLDEN INDIA ARCHITECTS

THE TEAM OF ARCHITECTS
 FF-37, KADAMBIA SHOPPING COMPLEX
 GAMMA-IGREATER NOIDA
 CON. +91-94-1585-6777

DESIGN BY: Confluence
 NEW DELHI, INDIA

F-1, FIRST FLOOR, MIRA CORPORATE SUITES,
 ISHWAR NAGAR, NEW DELHI 110065

Ph: +91-11-26925684 Member of IGBC
 Ph: +91-11-40564768 www.inconfluence.com ISO: 9001:2000
 architecture urban design hospitality interiors

DRAWING NO. S-61 REVISION

F.A.R. COVERED AREA CALCULATION FOR CIRCULATION AREA AT GROUND FLOOR / STILT LOBBY

| S.NO. | 1 | 2 | 3 | 4 | 5 | 6 | 7 | 8 | 9 | 10 | 11 | 12 | TOTAL (A) |
|---------------------------------------|--------|---|--------|---|---|---|---|---|---|----|----|----|-----------|
| 1 | 1.000 | X | 3.900 | | | | | | | | | | 3.900 |
| 2 | 2.750 | X | 3.900 | | | | | | | | | | 10.725 |
| 3 | 13.645 | X | 10.800 | | | | | | | | | | 144.837 |
| 4 | 3.715 | X | 7.225 | | | | | | | | | | 26.841 |
| 5 | 6.620 | X | 7.225 | | | | | | | | | | 47.830 |
| 6 | 5.575 | X | 2.755 | | | | | | | | | | 15.359 |
| 7 | 6.165 | X | 2.500 | | | | | | | | | | 15.463 |
| 8 | 6.620 | X | 6.775 | | | | | | | | | | 44.851 |
| 9 | 4.815 | X | 2.755 | | | | | | | | | | 13.295 |
| 10 | 6.620 | X | 3.440 | | | | | | | | | | 22.773 |
| 11 | 4.055 | X | 1.115 | | | | | | | | | | 4.521 |
| 12 | 4.295 | X | 1.985 | | | | | | | | | | 8.526 |
| TOTAL (A) | | | | | | | | | | | | | 358.690 |
| AREA SUBTRACTION | | | | | | | | | | | | | |
| FS1 | 6.140 | X | 6.585 | | | | | | | | | | 40.432 |
| LL1 | 1.800 | X | 5.480 | | | | | | | | | | 9.864 |
| H3 | 1.380 | X | 1.015 | X | 2 | | | | | | | | 2.801 |
| H4 | 0.860 | X | 1.015 | X | 2 | | | | | | | | 1.340 |
| H5 | 1.570 | X | 0.670 | | | | | | | | | | 1.052 |
| H6 | 0.510 | X | 3.100 | | | | | | | | | | 1.581 |
| H7 | 2.260 | X | 0.895 | | | | | | | | | | 2.050 |
| H8 | 0.700 | X | 2.800 | | | | | | | | | | 1.960 |
| TOTAL (B) | | | | | | | | | | | | | 61.880 |
| TOTAL F.A.R AREA CORRIDOR C = (A - B) | | | | | | | | | | | | | 297.610 |

AREA CALCULATION TOWARDS 15% ADDITIONAL F.A.R AT GROUND FLOOR / STILT LOBBY

| S.NO. | PARTICULARS | AREA (SQMT) |
|----------------------------------|---------------|-------------|
| FS1 | 6.140 X 6.585 | 40.432 |
| LL1 | 1.800 X 5.480 | 9.864 |
| CANOPY AREA | | 35.000 |
| TOTAL AREA (D) | | 85.296 |
| AREA SUBTRACTION | | |
| H1 | 0.960 X 4.045 | 2.670 |
| H2 | 0.960 X 2.300 | 1.516 |
| TOTAL (E) | | 4.188 |
| TOTAL 15% F.A.R AREA F = (D - E) | | 81.108 |

NON F.A.R. AREA CALCULATION FOR GROUND FLOOR / STILT AREA



| S.NO. | 1 | 2 | 3 | 4 | 5 | 6 | 7 | 8 | 9 | 10 | 11 | 12 | 13 | 14 | 15 | 16 | TOTAL (G) |
|--|--------|---|-------|---|---|---|---|---|---|----|----|----|----|----|----|----|-----------|
| S1 | 11.170 | X | 7.225 | | | | | | | | | | | | | | 80.703 |
| S2 | 2.125 | X | 5.425 | | | | | | | | | | | | | | 11.528 |
| S3 | 4.055 | X | 2.325 | | | | | | | | | | | | | | 9.426 |
| S4 | 7.065 | X | 2.755 | | | | | | | | | | | | | | 19.505 |
| S5 | 3.810 | X | 1.545 | | | | | | | | | | | | | | 5.886 |
| S6 | 2.370 | X | 5.225 | | | | | | | | | | | | | | 12.383 |
| S7 | 2.610 | X | 1.985 | | | | | | | | | | | | | | 5.181 |
| S8 | 2.370 | X | 3.440 | | | | | | | | | | | | | | 8.153 |
| S9 | 3.275 | X | 2.755 | | | | | | | | | | | | | | 9.023 |
| S10 | 14.980 | X | 7.225 | | | | | | | | | | | | | | 108.231 |
| S11 | 3.810 | X | 2.500 | | | | | | | | | | | | | | 9.525 |
| S12 | 2.370 | X | 6.775 | | | | | | | | | | | | | | 16.057 |
| S13 | 3.810 | X | 1.545 | | | | | | | | | | | | | | 5.886 |
| S14 | 7.225 | X | 2.755 | | | | | | | | | | | | | | 19.905 |
| S15 | 6.160 | X | 5.425 | | | | | | | | | | | | | | 33.527 |
| S16 | 11.170 | X | 7.225 | | | | | | | | | | | | | | 80.703 |
| TOTAL NON F.A.R AREA STILT PARKING = (G) | | | | | | | | | | | | | | | | | 435.624 |

TOTAL F.A.R. AREA AT GROUND FLOOR / STILT LVL.

| S.NO. | PARTICULARS | AREA (SQMT) |
|-------|--|-------------|
| 1 | F.A.R AREA OF CIRCULATION & ENTRANCE LOBBY | 297.610 |
| 2 | TOTAL F.A.R AREA | 297.610 |


TOWER - 7

| FLOOR | GROUND COVERAGE | F.A.R. AREA | 15% AREA | STILT NON F.A.R AREA (PARKING) | NON F.A.R AREA (BALCONY) |
|--------------------------------|-----------------|-------------|----------|--------------------------------|--------------------------|
| GROUND/STILT FLOOR (F.A.R.) | 835.761 | 297.610 | 81.108 | 435.624 | 0.000 |
| 1st / PODIUM FLOOR AREA | | 506.050 | 45.799 | | 99.172 |
| 2nd FLOOR AREA | | 652.078 | 46.850 | | 132.229 |
| 3rd FLOOR AREA | | 652.078 | 46.850 | | 132.229 |
| 4th FLOOR AREA | | 652.078 | 46.850 | | 132.229 |
| 5th FLOOR AREA | | 652.078 | 46.850 | | 132.229 |
| 6th FLOOR AREA | | 652.078 | 46.850 | | 132.229 |
| 7th FLOOR AREA | | 652.078 | 46.850 | | 132.229 |
| 8th FLOOR AREA | | 652.078 | 46.850 | | 132.229 |
| 9th FLOOR AREA | | 652.078 | 46.850 | | 132.229 |
| 10th FLOOR AREA | | 652.078 | 46.850 | | 132.229 |
| 11th FLOOR AREA | | 652.078 | 46.850 | | 132.229 |
| 12th FLOOR AREA | | 652.078 | 46.850 | | 132.229 |
| 13th FLOOR AREA | | 652.078 | 46.850 | | 132.229 |
| 14th FLOOR AREA | | 652.078 | 46.850 | | 132.229 |
| 15th FLOOR AREA | | 652.078 | 46.850 | | 132.229 |
| 16th FLOOR AREA | | 652.078 | 46.850 | | 132.229 |
| 17th FLOOR AREA | | 652.078 | 46.850 | | 132.229 |
| 18th FLOOR AREA | | 652.078 | 46.850 | | 132.229 |
| 19th FLOOR AREA (REFUGE FLOOR) | | 618.908 | 92.943 | | 119.274 |
| 20th FLOOR AREA | | 652.078 | 46.850 | | 132.229 |
| 21st FLOOR AREA | | 652.078 | 46.850 | | 132.229 |
| 22nd FLOOR AREA | | 652.078 | 46.850 | | 132.229 |
| 23rd FLOOR AREA | | 652.078 | 46.850 | | 132.229 |
| 24th FLOOR AREA | | 652.078 | 46.850 | | 132.229 |
| TERRACE FLOOR | | 28.308 | 116.294 | | |
| MACHINE ROOM LVL. | | | 67.012 | | |
| D.H TANK LVL. | | | 49.158 | | |
| TOTAL | 835.761 | 15796.600 | 1483.022 | 435.624 | 3127.484 |

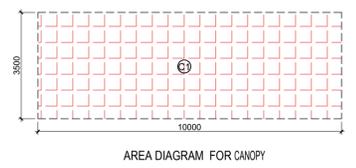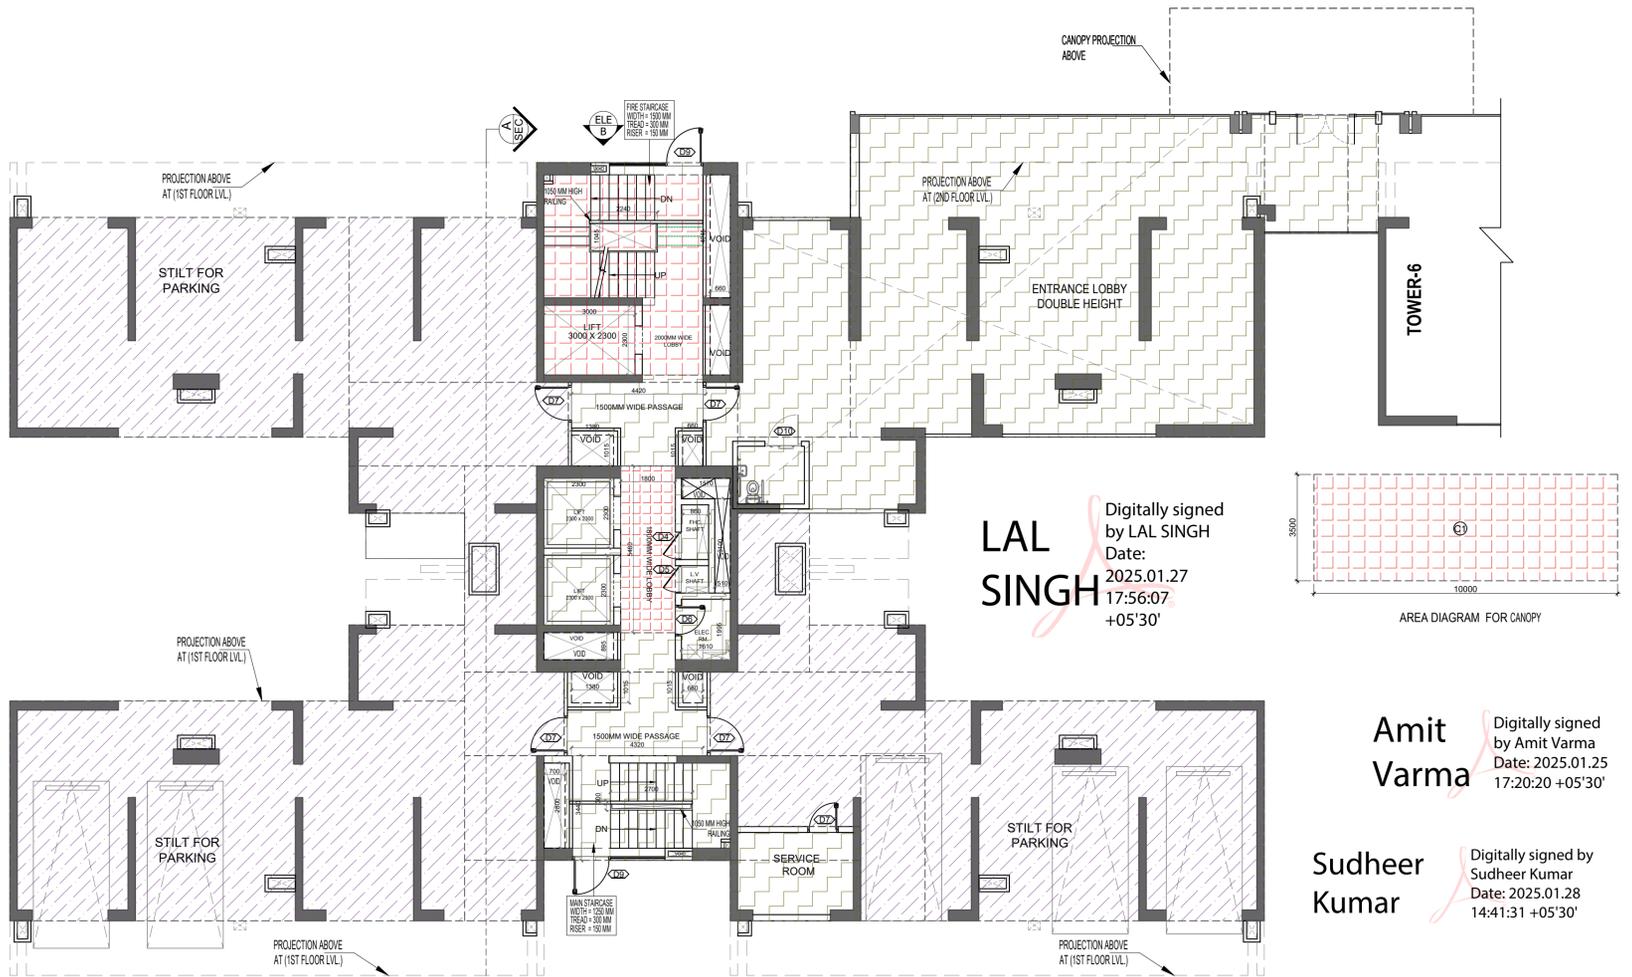


Amit Varma Digitally signed by Amit Varma Date: 2025.01.25 17:20:20 +05'30'

Sudheer Kumar Digitally signed by Sudheer Kumar Date: 2025.01.28 14:41:31 +05'30'

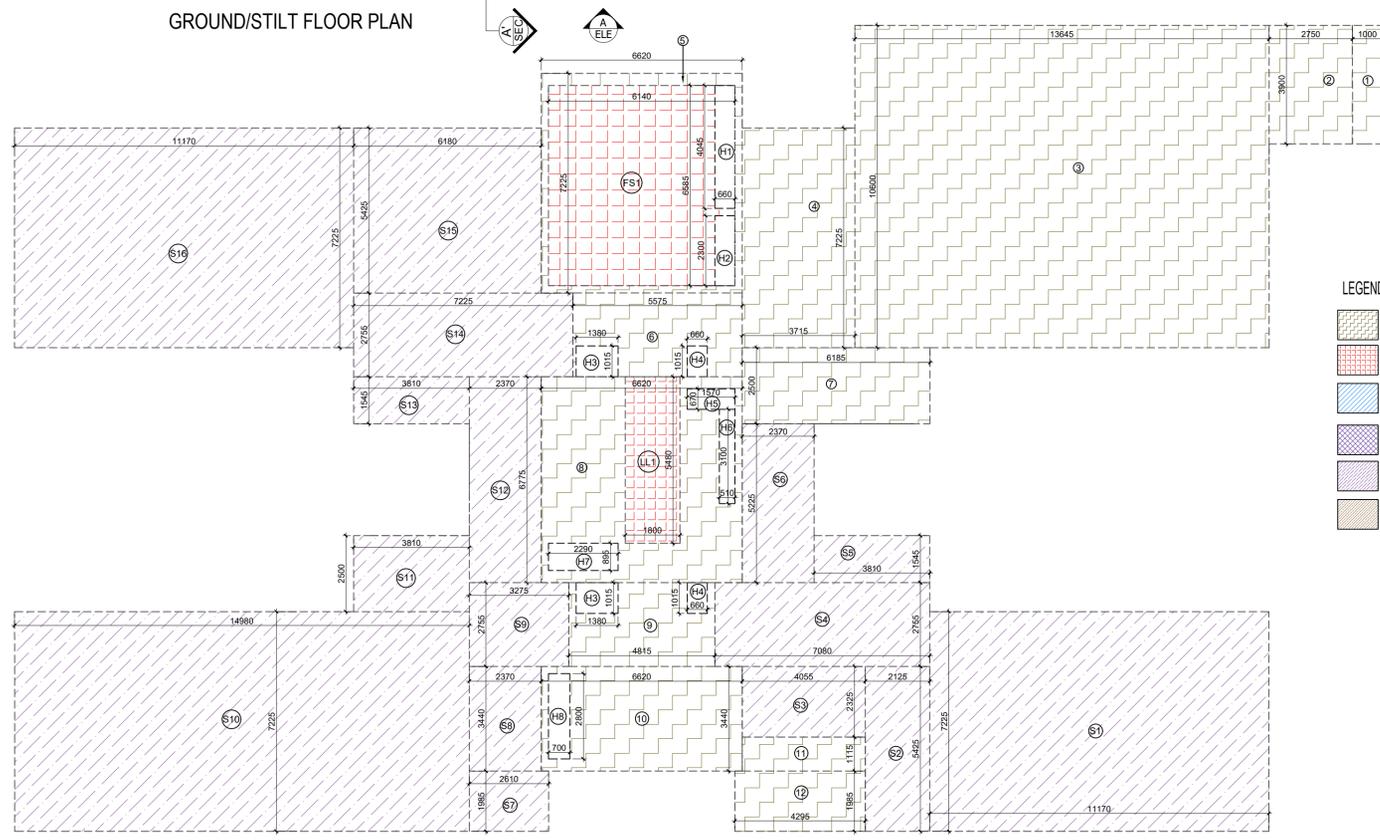


- LEGEND
- F.A.R. AREA
 - 15% SERVICES AREA
 - NON F.A.R. AREA
 - COUNTED IN 1/4 F.A.R. AREA
 - NON F.A.R. AREA STILT
 - AREA FOR GROUND COVERAGE USE ONLY

AREA DIAGRAM FOR GROUND FLOOR CIRCULATION & ENTRANCE LOBBY

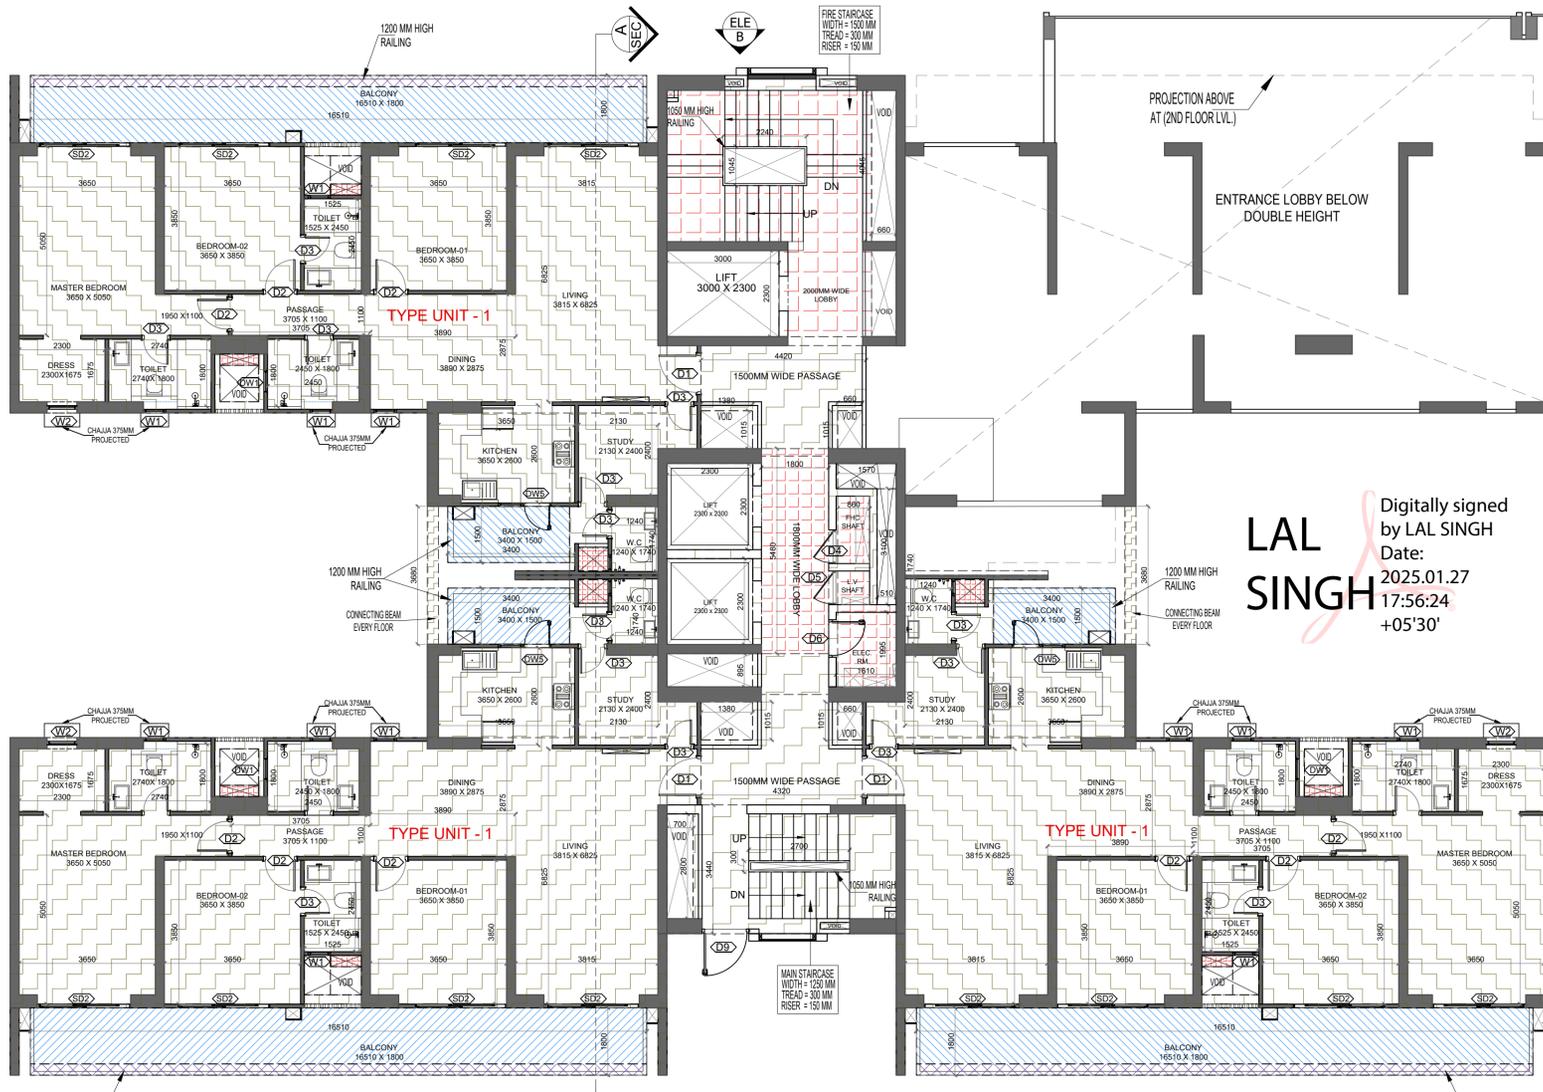



FIRST FLOOR PLAN

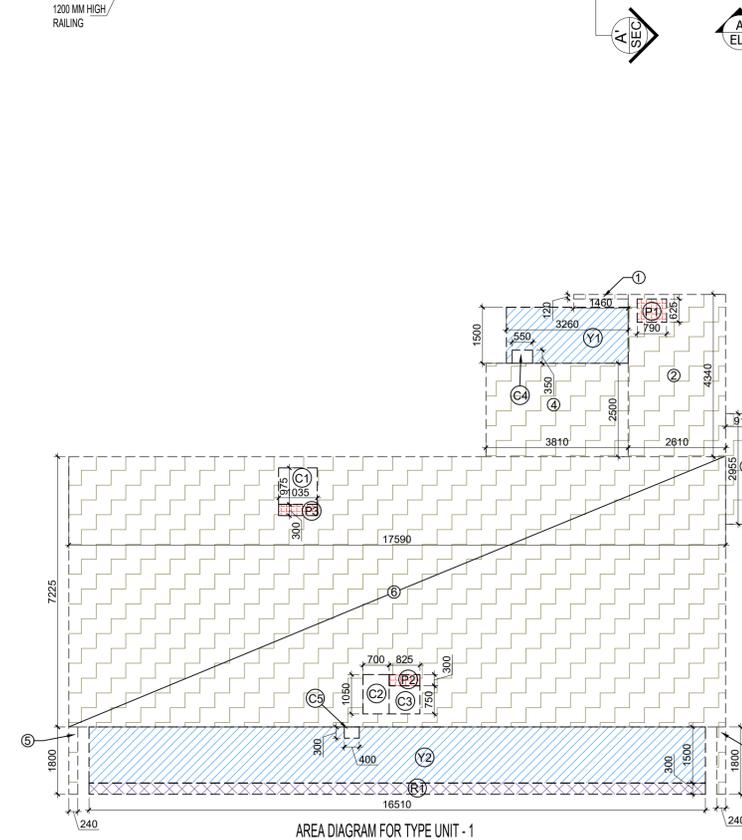


AREA DIAGRAM FOR TYPE UNIT - 1

| S.NO. | PARTICULARS | AREA (SQMT) |
|---|-------------------------------|----------------|
| 1 | COVERED AREA | |
| 2 | 1.460 X 0.120 = 0.175 | |
| 3 | 2.810 X 4.340 = 11.327 | |
| 4 | 0.910 X 2.955 = 2.689 | |
| 5 | 3.810 X 2.500 = 9.525 | |
| 6 | 0.240 X 1.800 X 2 = 0.864 | |
| 7 | 17.590 X 7.225 = 127.088 | |
| UNIT F.A.R. AREA (A) | | 151.668 |
| AREA SUBTRACTION PLUMBING CUTOUT | | |
| P1 | 0.790 X 0.625 = 0.494 | |
| P2 | 0.825 X 0.300 = 0.248 | |
| P3 | 1.035 X 0.300 = 0.311 | |
| C1 | 1.035 X 0.975 = 1.009 | |
| C2 | 0.700 X 1.050 = 0.735 | |
| C3 | 0.825 X 0.750 = 0.619 | |
| TOTAL (B) | | 3.415 |
| TOTAL F.A.R. AREA C = (A - B) | | 148.254 |
| 1/4 F.A.R. AREA OF BALCONY | | |
| R1 | 16.510 X 0.300 = 4.953 | |
| TOTAL AREA (D) | | 4.953 |
| 1/4 BALCONY F.A.R. AREA (E) | | 1.238 |
| TOTAL UNIT F.A.R. AREA F = (C + E) | | 149.492 |
| NON F.A.R. AREA OF BALCONY | | |
| Y1 | 3.260 X 1.500 = 4.890 | |
| Y3 | 16.510 X 1.500 = 24.765 | |
| 3/4 AREA OF BALCONY (D - E) | | 3.715 |
| TOTAL (G) | | 33.370 |
| AREA SUBTRACTION | | |
| C4 | 0.550 X 0.350 = 0.193 | |
| C5 | 0.400 X 0.300 = 0.120 | |
| TOTAL AREA (H) | | 0.313 |
| TOTAL BALCONY AREA J = (G - H) | | 33.057 |
| 15% SERVICES AREA OF UNIT (PLUMBING SHAFT) | | |
| P1 | 0.790 X 0.625 = 0.494 | |
| P2 | 0.825 X 0.300 = 0.248 | |
| P3 | 1.035 X 0.300 = 0.311 | |
| TOTAL 15% SERVICES AREA OF UNIT (K) | | 1.052 |
| COVERED AREA FOR UNIT = (F + J + K) | | |
| 1 | TOTAL UNIT F.A.R. AREA (F) | 149.492 |
| 2 | NON F.A.R. AREA OF UNIT (J) | 33.057 |
| 3 | 15% SERVICES AREA OF UNIT (K) | 1.052 |
| TOTAL UNIT COVERED AREA | | 183.601 |


| S.NO. | PARTICULARS | AREA (SQMT) |
|---|-------------------|----------------|
| TOTAL F.A.R. AREA AT FIRST FLOOR / PODIUM LVL. | | |
| F.A.R. AREA OF UNIT - 1 | 3 X 149.492 | 448.476 |
| F.A.R. AREA OF CIRCULATION | 1 X 55.366 | 55.366 |
| F.A.R. AREA OF CONNECTING BEAM | | 2.208 |
| TOTAL F.A.R. AREA | | 506.050 |
| TOTAL NON F.A.R. AREA AT FIRST FLOOR / PODIUM | | |
| UNIT - 1 | 33.057 X 3 | 99.172 |
| TOTAL BALCONY AREA | | 99.172 |
| F.A.R. AREA AT CONNECTING BEAM (EVERY FLOOR) | | |
| S.NO. | PARTICULARS | AREA (SQMT) |
| 1 | 0.300 X 3.660 X 2 | 2.208 |
| TOTAL F.A.R. AREA | | 2.208 |

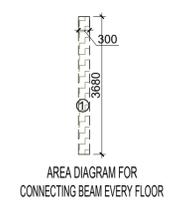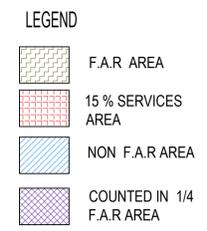

AREA DIAGRAM FOR CONNECTING BEAM EVERY FLOOR

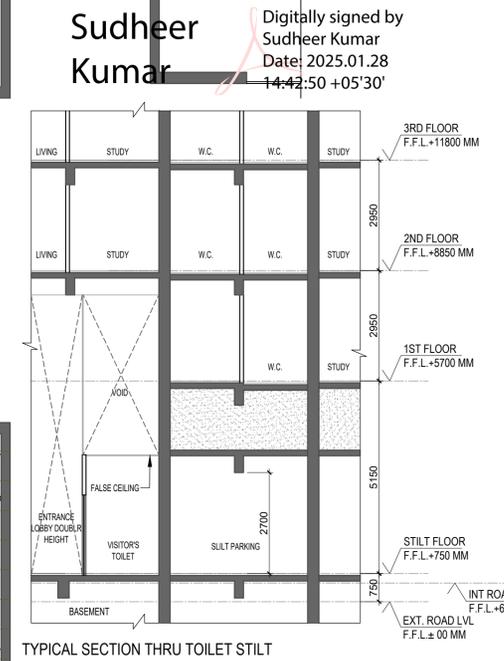

TYPICAL SECTION THRU TOILET STILT

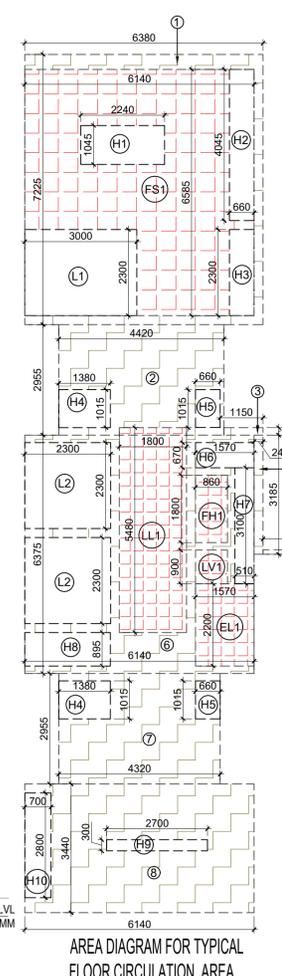

AREA DIAGRAM FOR TYPICAL FLOOR CIRCULATION AREA

| S.NO. | PARTICULARS | AREA (SQMT) |
|---|-------------------|----------------|
| 1 | 6.380 X 7.225 | 46.096 |
| 2 | 4.420 X 2.955 | 13.061 |
| 3 | 1.050 X 0.200 | 0.210 |
| 4 | 0.240 X 3.185 | 0.764 |
| 5 | 3.830 X 0.120 | 0.460 |
| 6 | 6.140 X 6.375 | 39.143 |
| 7 | 4.320 X 2.955 | 12.766 |
| 8 | 6.140 X 3.440 | 21.122 |
| TOTAL AREA (A) | | 133.820 |
| AREA SUBTRACTION | | |
| FS1 | 6.140 X 6.585 | 40.432 |
| LL1 | 1.800 X 5.480 | 9.864 |
| LV1 | 0.860 X 0.900 | 0.774 |
| FH1 | 0.860 X 1.800 | 1.548 |
| EL1 | 1.570 X 2.200 | 3.454 |
| L2 | 2.300 X 2.300 X 2 | 10.580 |
| H4 | 1.380 X 1.015 X 2 | 2.801 |
| H5 | 0.660 X 1.015 X 2 | 1.340 |
| H6 | 1.570 X 0.670 | 1.052 |
| H7 | 0.510 X 3.100 | 1.581 |
| H8 | 2.300 X 0.895 | 2.059 |
| H9 | 2.700 X 0.300 | 0.810 |
| H10 | 0.700 X 2.800 | 1.960 |
| TOTAL (B) | | 78.255 |
| TOTAL F.A.R. AREA CORRIDOR C = (A - B) | | 55.366 |

| S.NO. | PARTICULARS | AREA (SQMT) |
|---|-------------------|---------------|
| CORRIDOR AREA CALCULATION TOWARDS 15% ADDITIONAL F.A.R. | | |
| FIRE TOWER AREA | | |
| FS1 | 6.140 X 6.585 | 40.432 |
| LIFT LOBBY | | |
| LL1 | 1.800 X 5.480 | 9.864 |
| LV.SHAFT | | |
| LV1 | 0.860 X 0.900 | 0.774 |
| F.H.C. SHAFT | | |
| FH1 | 0.860 X 1.800 | 1.548 |
| ELECTRICAL SHAFT | | |
| EL1 | 1.570 X 2.200 | 3.454 |
| TOTAL CORRIDOR AREA CALCULATION TOWARDS 15% ADDITIONAL F.A.R. (A) | | 56.072 |
| UNIT AREA CALCULATION TOWARDS 15% ADDITIONAL F.A.R. | | |
| PLUMBING SHAFT | | |
| P1 | 0.790 X 0.625 X 3 | 1.481 |
| P2 | 0.825 X 0.300 X 3 | 0.743 |
| P3 | 1.035 X 0.300 X 3 | 0.932 |
| TOTAL UNIT AREA CALCULATION TOWARDS 15% ADDITIONAL F.A.R. (B) | | 3.155 |
| TOTAL 15% ADDITIONAL F.A.R. AREA (CORRIDOR AREA + UNIT AREA) = C (A + B) | | 59.227 |
| AREA SUBTRACTION | | |
| H1 | 2.240 X 1.045 | 2.341 |
| H2 | 0.660 X 4.045 | 2.670 |
| H3 | 0.660 X 2.300 | 1.518 |
| L1 | 3.000 X 2.300 | 6.900 |
| TOTAL AREA (D) | | 13.429 |
| TOTAL 15% ADDITIONAL F.A.R. AREA E = (C - D) | | 45.799 |

OWNER SIGN
Rajat pathak
2025.01.2
3 12:42:14
+05'30'

ARCHITECT SIGN
AVANI SRIVASTAV
2025.01.23
12:42:05
+05'30'

TOWN PLANNER SIGN

DOOR SCHEDULE

| S.NO. | TYPE | OPENING | DOOR | LEVEL | LOCATION | DESCRIPTION |
|-------|------|---------|------|-------|----------|-----------------------|
| 1 | DOOR | 2300 | 2300 | 2300 | LIVING | UPVC FRAME GLASS DOOR |
| 2 | DOOR | 2300 | 2300 | 2300 | LIVING | UPVC FRAME GLASS DOOR |
| 3 | DOOR | 1500 | 1500 | 1500 | LIVING | UPVC FRAME GLASS DOOR |
| 4 | DOOR | 1500 | 1500 | 1500 | LIVING | UPVC FRAME GLASS DOOR |
| 5 | DOOR | 1500 | 1500 | 1500 | LIVING | UPVC FRAME GLASS DOOR |
| 6 | DOOR | 1500 | 1500 | 1500 | LIVING | UPVC FRAME GLASS DOOR |
| 7 | DOOR | 1500 | 1500 | 1500 | LIVING | UPVC FRAME GLASS DOOR |
| 8 | DOOR | 1500 | 1500 | 1500 | LIVING | UPVC FRAME GLASS DOOR |
| 9 | DOOR | 1500 | 1500 | 1500 | LIVING | UPVC FRAME GLASS DOOR |
| 10 | DOOR | 1500 | 1500 | 1500 | LIVING | UPVC FRAME GLASS DOOR |
| 11 | DOOR | 1500 | 1500 | 1500 | LIVING | UPVC FRAME GLASS DOOR |
| 12 | DOOR | 1500 | 1500 | 1500 | LIVING | UPVC FRAME GLASS DOOR |
| 13 | DOOR | 1500 | 1500 | 1500 | LIVING | UPVC FRAME GLASS DOOR |
| 14 | DOOR | 1500 | 1500 | 1500 | LIVING | UPVC FRAME GLASS DOOR |
| 15 | DOOR | 1500 | 1500 | 1500 | LIVING | UPVC FRAME GLASS DOOR |
| 16 | DOOR | 1500 | 1500 | 1500 | LIVING | UPVC FRAME GLASS DOOR |
| 17 | DOOR | 1500 | 1500 | 1500 | LIVING | UPVC FRAME GLASS DOOR |
| 18 | DOOR | 1500 | 1500 | 1500 | LIVING | UPVC FRAME GLASS DOOR |
| 19 | DOOR | 1500 | 1500 | 1500 | LIVING | UPVC FRAME GLASS DOOR |
| 20 | DOOR | 1500 | 1500 | 1500 | LIVING | UPVC FRAME GLASS DOOR |

WINDOW SCHEDULE

| S.NO. | TYPE | OPENING | DOOR | LEVEL | LOCATION | DESCRIPTION |
|-------|--------|---------|------|-------|----------|-------------------------|
| 1 | WINDOW | 1500 | 1500 | 1500 | LIVING | UPVC FRAME GLASS WINDOW |
| 2 | WINDOW | 1500 | 1500 | 1500 | LIVING | UPVC FRAME GLASS WINDOW |
| 3 | WINDOW | 1500 | 1500 | 1500 | LIVING | UPVC FRAME GLASS WINDOW |
| 4 | WINDOW | 1500 | 1500 | 1500 | LIVING | UPVC FRAME GLASS WINDOW |
| 5 | WINDOW | 1500 | 1500 | 1500 | LIVING | UPVC FRAME GLASS WINDOW |
| 6 | WINDOW | 1500 | 1500 | 1500 | LIVING | UPVC FRAME GLASS WINDOW |
| 7 | WINDOW | 1500 | 1500 | 1500 | LIVING | UPVC FRAME GLASS WINDOW |
| 8 | WINDOW | 1500 | 1500 | 1500 | LIVING | UPVC FRAME GLASS WINDOW |
| 9 | WINDOW | 1500 | 1500 | 1500 | LIVING | UPVC FRAME GLASS WINDOW |
| 10 | WINDOW | 1500 | 1500 | 1500 | LIVING | UPVC FRAME GLASS WINDOW |
| 11 | WINDOW | 1500 | 1500 | 1500 | LIVING | UPVC FRAME GLASS WINDOW |
| 12 | WINDOW | 1500 | 1500 | 1500 | LIVING | UPVC FRAME GLASS WINDOW |
| 13 | WINDOW | 1500 | 1500 | 1500 | LIVING | UPVC FRAME GLASS WINDOW |
| 14 | WINDOW | 1500 | 1500 | 1500 | LIVING | UPVC FRAME GLASS WINDOW |
| 15 | WINDOW | 1500 | 1500 | 1500 | LIVING | UPVC FRAME GLASS WINDOW |
| 16 | WINDOW | 1500 | 1500 | 1500 | LIVING | UPVC FRAME GLASS WINDOW |
| 17 | WINDOW | 1500 | 1500 | 1500 | LIVING | UPVC FRAME GLASS WINDOW |
| 18 | WINDOW | 1500 | 1500 | 1500 | LIVING | UPVC FRAME GLASS WINDOW |
| 19 | WINDOW | 1500 | 1500 | 1500 | LIVING | UPVC FRAME GLASS WINDOW |
| 20 | WINDOW | 1500 | 1500 | 1500 | LIVING | UPVC FRAME GLASS WINDOW |

OWNER
GODREJ PROPERTIES LIMITED

SUBMISSION DRAWING

KEY PLAN
TOWER - 7
S+24

PROJECT
PROPOSED GROUP HOUSING FOR PLOT NO. :- GH-01/B,C,D,E,J & K SECTOR -12, GREATER NOIDA, G.B. NAGAR, (U.P.)

| DATE | PROJECT INCH. | CHECKED BY |
|----------------|---------------|--------------|
| 08 - 01 - 2025 | BALRAJ SINGH | BALRAJ SINGH |

| SCALE | DEALT BY | APPROVED BY |
|-------|-------------|---------------|
| 1:100 | ABDRESH JHA | VISHAL SHARMA |

DRAWING TITLE
FIRST FLOOR PLAN
TOWER - 7

ARCHITECTS
GOLDEN INDIA ARCHITECTS
THE TEAM OF ARCHITECTS
FF-37, KADAMBA SHOPPING COMPLEX
GAMMA-IGREATER NOIDA
CON. +91-94-1585-6777

DESIGN BY:
Confluence
NEW DELHI, INDIA
F-1, FIRST FLOOR, MIRA CORPORATE SUITES,
ISHWAR NAGAR, NEW DELHI 110065


Ph: +91-11-26925684 ccs@inconfluence.com Member of IGBC
Ph: +91-11-40564768 www.inconfluence.com ISO: 9001:2000
architecture urban design hospitality interiors

DRAWING NO. S-62 **REVISION**

Sudheer Kumar
Digitally signed by Sudheer Kumar
Date: 2025.01.28
14:42:50 +05'30'

LAL SINGH
Digitally signed by LAL SINGH
Date: 2025.01.27
17:56:24
+05'30'

Amit Varma
Digitally signed by Amit Varma
Date: 2025.01.25
17:20:43 +05'30'

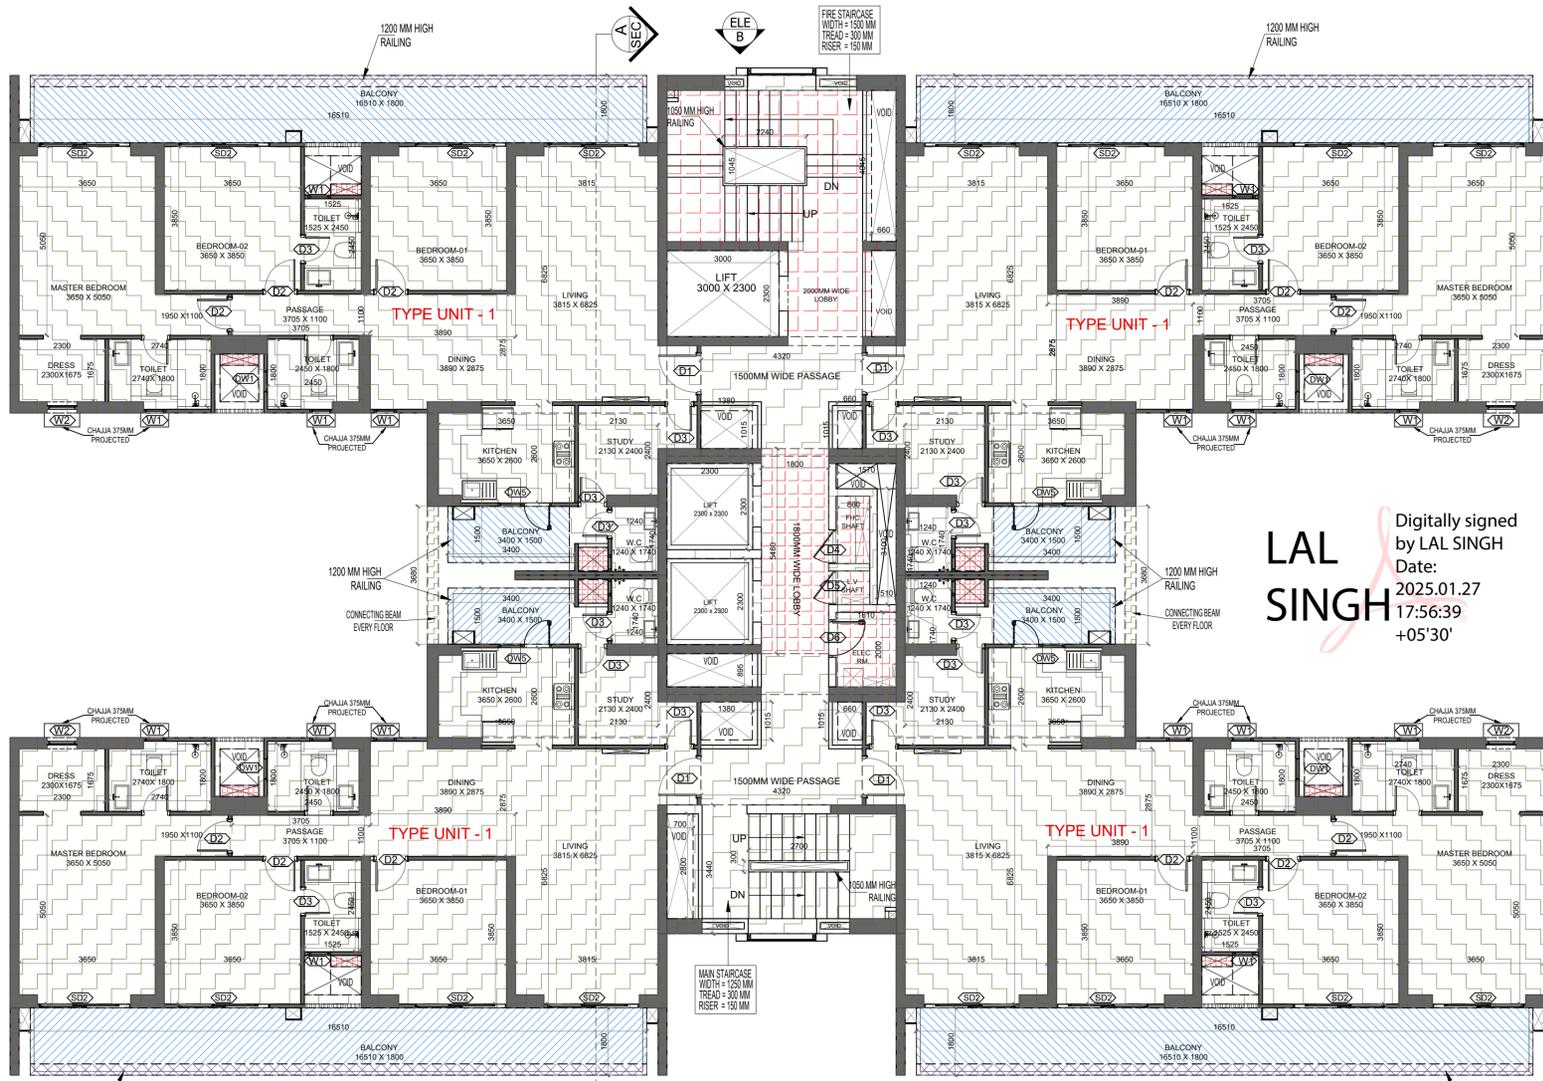

2ND TO 18TH & 20TH TO 24TH FLOOR PLAN (TYPICAL)

| TOTAL F.A.R. AREA AT 2ND TO 18TH, 20TH TO 24TH FLOOR PLAN (TYPICAL) | | | | |
|---|-------------|---|---------|----------------|
| S.NO. | PARTICULARS | | | AREA (SQMT) |
| F.A.R. AREA OF UNIT - 1 | 4 | X | 149.492 | = 597.968 |
| F.A.R. AREA OF CIRCULATION | 1 | X | 51.902 | = 51.902 |
| F.A.R. AREA OF CONNECTING BEAM | | | | = 2.208 |
| TOTAL F.A.R. AREA | | | | 652.078 |

| TOTAL NON F.A.R. AREA AT 2ND TO 18TH, 20TH TO 24TH FLOOR PLAN (TYPICAL) | | | | |
|---|---|---|--|----------------|
| UNIT - 1 | | | | |
| 33.057 | X | 4 | | = 132.229 |
| TOTAL BALCONY AREA | | | | 132.229 |

| F.A.R. COVERED AREA CALCULATION FOR CIRCULATION AREA | | | | |
|--|-------------|---|-------|----------------|
| S.NO. | PARTICULARS | | | AREA (SQMT) |
| 1 | 6.140 | X | 7.225 | = 44.362 |
| 2 | 4.320 | X | 2.955 | X 2 = 25.531 |
| 3 | 6.140 | X | 6.375 | = 39.143 |
| 4 | 6.140 | X | 3.440 | = 21.122 |
| TOTAL AREA (A) | | | | 130.157 |
| AREA SUBTRACTION | | | | |
| FS1 | 6.140 | X | 6.585 | = 40.432 |
| LL1 | 1.800 | X | 5.480 | = 9.864 |
| LV1 | 0.860 | X | 0.900 | = 0.774 |
| FH1 | 0.860 | X | 1.800 | = 1.548 |
| EL1 | 1.570 | X | 2.200 | = 3.454 |
| L2 | 2.300 | X | 2.300 | X 2 = 10.580 |
| H4 | 1.380 | X | 1.015 | X 2 = 2.801 |
| H5 | 0.860 | X | 1.015 | X 2 = 1.740 |
| H6 | 1.570 | X | 0.670 | = 1.052 |
| H7 | 0.510 | X | 3.100 | = 1.581 |
| H8 | 2.300 | X | 0.895 | = 2.059 |
| H9 | 2.700 | X | 0.300 | = 0.810 |
| H10 | 0.700 | X | 2.800 | = 1.960 |
| TOTAL (B) | | | | 78.255 |
| TOTAL F.A.R. AREA CORRIDOR C = (A - B) | | | | 51.902 |


| CORRIDOR AREA CALCULATION TOWARDS 15% ADDITIONAL F.A.R | | | | |
|---|-------------|---|-------|---------------|
| S.NO. | PARTICULARS | | | AREA (SQMT) |
| FIRE TOWER AREA | | | | |
| FS1 | 6.140 | X | 6.585 | = 40.432 |
| LIFT LOBBY | | | | |
| LL1 | 1.800 | X | 5.480 | = 9.864 |
| LV SHAFT | | | | |
| LV1 | 0.860 | X | 0.900 | = 0.774 |
| F.H.C SHAFT | | | | |
| FH1 | 0.860 | X | 1.800 | = 1.548 |
| ELECTRICAL SHAFT | | | | |
| EL1 | 1.570 | X | 2.200 | = 3.454 |
| TOTAL CORRIDOR AREA CALCULATION TOWARDS 15% ADDITIONAL F.A.R (A) | | | | 56.072 |
| UNIT AREA CALCULATION TOWARDS 15% ADDITIONAL F.A.R | | | | |
| P1 | 0.790 | X | 0.625 | X 4 = 1.975 |
| P2 | 0.825 | X | 0.300 | X 4 = 0.990 |
| P3 | 1.035 | X | 0.300 | X 4 = 1.242 |
| TOTAL UNIT AREA CALCULATION TOWARDS 15% ADDITIONAL F.A.R (B) | | | | 4.207 |
| TOTAL 15% ADDITIONAL F.A.R. AREA (CORRIDOR AREA + UNIT AREA) = C = (A + B) | | | | 60.279 |
| AREA SUBTRACTION | | | | |
| H1 | 2.240 | X | 1.045 | = 2.341 |
| H2 | 0.660 | X | 4.045 | = 2.670 |
| H3 | 0.660 | X | 2.300 | = 1.518 |
| L1 | 3.000 | X | 2.300 | = 6.900 |
| TOTAL AREA (D) | | | | 13.429 |
| TOTAL 15% ADDITIONAL F.A.R. AREA E = (C - D) | | | | 46.850 |

| F.A.R. AREA AT CONNECTING BEAM (EVERY FLOOR) | | | | |
|--|-------------|---|-------|---------------|
| S.NO. | PARTICULARS | | | AREA (SQMT) |
| 1 | 0.300 | X | 3.680 | X 2 = 2.208 |
| TOTAL F.A.R. AREA | | | | 2.208 |

LAL SINGH
Digitally signed by LAL SINGH
Date: 2025.01.27
17:56:39
+05'30'

Sudheer Kumar
Digitally signed by Sudheer Kumar
Date: 2025.01.28
6:14:44.07 +05'30'

Amit Varma
Digitally signed by Amit Varma
Date: 2025.01.25
17:20:57 +05'30'

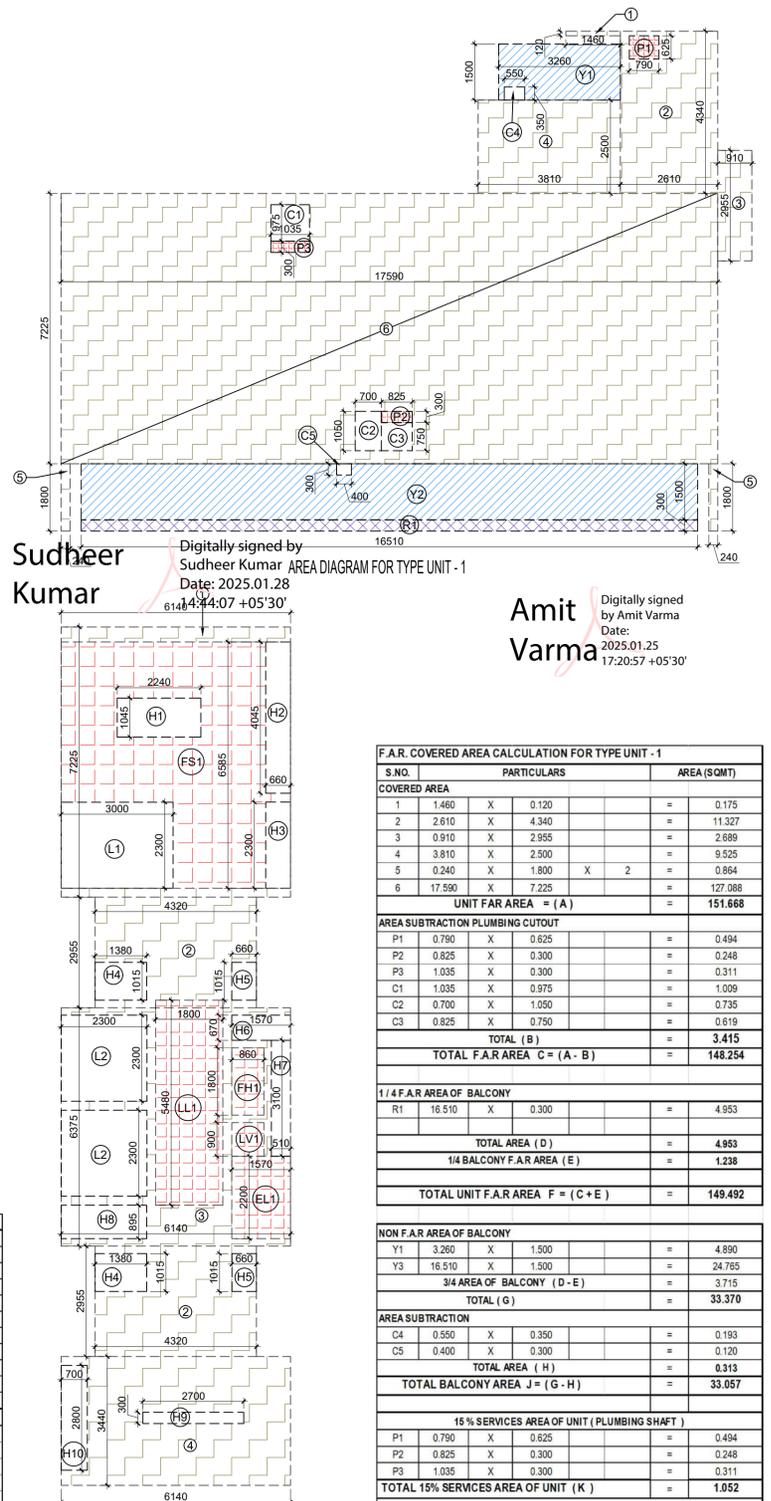

AREA DIAGRAM FOR TYPICAL FLOOR CIRCULATION AREA



AREA DIAGRAM FOR CONNECTING BEAM EVERY FLOOR

| F.A.R. COVERED AREA CALCULATION FOR TYPE UNIT - 1 | | | | |
|---|-------------|---|-------|----------------|
| S.NO. | PARTICULARS | | | AREA (SQMT) |
| COVERED AREA | | | | |
| 1 | 1.460 | X | 0.120 | = 0.175 |
| 2 | 2.610 | X | 4.340 | = 11.327 |
| 3 | 0.910 | X | 2.955 | = 2.689 |
| 4 | 3.810 | X | 2.500 | = 9.525 |
| 5 | 0.240 | X | 1.800 | X 2 = 0.864 |
| 6 | 17.590 | X | 7.225 | = 127.088 |
| UNIT FAR AREA = (A) | | | | 151.668 |
| AREA SUBTRACTION PLUMBING CUTOUT | | | | |
| P1 | 0.790 | X | 0.625 | = 0.494 |
| P2 | 0.825 | X | 0.300 | = 0.248 |
| P3 | 1.035 | X | 0.300 | = 0.311 |
| C1 | 1.035 | X | 0.975 | = 1.009 |
| C2 | 0.700 | X | 1.050 | = 0.735 |
| C3 | 0.825 | X | 0.750 | = 0.619 |
| TOTAL (B) | | | | 3.415 |
| TOTAL F.A.R. AREA C = (A - B) | | | | 148.254 |
| 1/4 F.A.R. AREA OF BALCONY | | | | |
| R1 | 16.510 | X | 0.300 | = 4.953 |
| TOTAL AREA (D) | | | | 4.953 |
| 1/4 BALCONY F.A.R. AREA (E) | | | | 1.238 |
| TOTAL UNIT F.A.R. AREA F = (C + E) | | | | 149.492 |

| NON F.A.R. AREA OF BALCONY | | | | |
|---|-------------------------------|---|-------|----------------|
| S.NO. | PARTICULARS | | | AREA (SQMT) |
| Y1 | 3.260 | X | 1.500 | = 4.890 |
| Y3 | 16.510 | X | 1.500 | = 24.765 |
| 3/4 AREA OF BALCONY (D - E) | | | | 3.715 |
| TOTAL (G) | | | | 33.370 |
| AREA SUBTRACTION | | | | |
| C4 | 0.550 | X | 0.350 | = 0.193 |
| C5 | 0.400 | X | 0.300 | = 0.120 |
| TOTAL AREA (H) | | | | 0.313 |
| TOTAL BALCONY AREA J = (G - H) | | | | 33.057 |
| 15% SERVICES AREA OF UNIT (PLUMBING SHAFT) | | | | |
| P1 | 0.790 | X | 0.625 | = 0.494 |
| P2 | 0.825 | X | 0.300 | = 0.248 |
| P3 | 1.035 | X | 0.300 | = 0.311 |
| TOTAL 15% SERVICES AREA OF UNIT (K) | | | | 1.052 |
| COVERED AREA FOR UNIT = (F + J + K) | | | | |
| 1 | TOTAL UNIT F.A.R. AREA (F) | | | = 149.492 |
| 2 | NON FAR AREA OF UNIT (J) | | | = 33.057 |
| 3 | 15% SERVICES AREA OF UNIT (K) | | | = 1.052 |
| TOTAL UNIT COVERAGE AREA | | | | 183.601 |

- LEGEND**
- [Pattern] F.A.R. AREA
 - [Pattern] 15% SERVICES AREA
 - [Pattern] NON F.A.R. AREA
 - [Pattern] COUNTED IN 1/4 F.A.R. AREA

| OWNER SIGN Rajat pathak Rajat pathak 2025.01.2 3 12:42:29 +05'30' | ARCHITECT SIGN AVANISH SRIVASTAV AVANISH SRIVASTAV 2025.01.23 12:42:41 +05'30' | |
|---|
| TOWN PLANNER SIGN | |
| <table border="1"> <thead> <tr> <th>SL. NO.</th> <th>TYPE</th> <th>OPENING</th> <th>HEIGHT</th> <th>LEVEL</th> <th>LOCATION</th> <th>DESCRIPTION</th> </tr> </thead> <tbody> <tr><td>1</td><td>DOOR</td><td>2000</td><td>2000</td><td>2000</td><td>LIVING</td><td>UPVC FRAME GLASS DOOR</td></tr> <tr><td>2</td><td>DOOR</td><td>2000</td><td>2000</td><td>2000</td><td>LIVING</td><td>UPVC FRAME GLASS DOOR</td></tr> <tr><td>3</td><td>DOOR</td><td>1500</td><td>2000</td><td>2000</td><td>LIVING</td><td>UPVC FRAME GLASS DOOR</td></tr> <tr><td>4</td><td>DOOR</td><td>1500</td><td>2000</td><td>2000</td><td>LIVING</td><td>UPVC FRAME GLASS DOOR</td></tr> <tr><td>5</td><td>DOOR</td><td>1500</td><td>2000</td><td>2000</td><td>LIVING</td><td>UPVC FRAME GLASS DOOR</td></tr> <tr><td>6</td><td>DOOR</td><td>1500</td><td>2000</td><td>2000</td><td>LIVING</td><td>UPVC FRAME GLASS DOOR</td></tr> <tr><td>7</td><td>DOOR</td><td>1500</td><td>2000</td><td>2000</td><td>LIVING</td><td>UPVC FRAME GLASS DOOR</td></tr> <tr><td>8</td><td>DOOR</td><td>1500</td><td>2000</td><td>2000</td><td>LIVING</td><td>UPVC FRAME GLASS DOOR</td></tr> <tr><td>9</td><td>DOOR</td><td>1500</td><td>2000</td><td>2000</td><td>LIVING</td><td>UPVC FRAME GLASS DOOR</td></tr> <tr><td>10</td><td>DOOR</td><td>1500</td><td>2000</td><td>2000</td><td>LIVING</td><td>UPVC FRAME GLASS DOOR</td></tr> <tr><td>11</td><td>DOOR</td><td>1500</td><td>2000</td><td>2000</td><td>LIVING</td><td>UPVC FRAME GLASS DOOR</td></tr> <tr><td>12</td><td>DOOR</td><td>1500</td><td>2000</td><td>2000</td><td>LIVING</td><td>UPVC FRAME GLASS DOOR</td></tr> <tr><td>13</td><td>DOOR</td><td>1500</td><td>2000</td><td>2000</td><td>LIVING</td><td>UPVC FRAME GLASS DOOR</td></tr> <tr><td>14</td><td>DOOR</td><td>1500</td><td>2000</td><td>2000</td><td>LIVING</td><td>UPVC FRAME GLASS DOOR</td></tr> <tr><td>15</td><td>DOOR</td><td>1500</td><td>2000</td><td>2000</td><td>LIVING</td><td>UPVC FRAME GLASS DOOR</td></tr> <tr><td>16</td><td>DOOR</td><td>1500</td><td>2000</td><td>2000</td><td>LIVING</td><td>UPVC FRAME GLASS DOOR</td></tr> <tr><td>17</td><td>DOOR</td><td>1500</td><td>2000</td><td>2000</td><td>LIVING</td><td>UPVC FRAME GLASS DOOR</td></tr> <tr><td>18</td><td>DOOR</td><td>1500</td><td>2000</td><td>2000</td><td>LIVING</td><td>UPVC FRAME GLASS DOOR</td></tr> <tr><td>19</td><td>DOOR</td><td>1500</td><td>2000</td><td>2000</td><td>LIVING</td><td>UPVC FRAME GLASS DOOR</td></tr> <tr><td>20</td><td>DOOR</td><td>1500</td><td>2000</td><td>2000</td><td>LIVING</td><td>UPVC FRAME GLASS DOOR</td></tr> <tr><td>21</td><td>DOOR</td><td>1500</td><td>2000</td><td>2000</td><td>LIVING</td><td>UPVC FRAME GLASS DOOR</td></tr> <tr><td>22</td><td>DOOR</td><td>1500</td><td>2000</td><td>2000</td><td>LIVING</td><td>UPVC FRAME GLASS DOOR</td></tr> <tr><td>23</td><td>DOOR</td><td>1500</td><td>2000</td><td>2000</td><td>LIVING</td><td>UPVC FRAME GLASS DOOR</td></tr> <tr><td>24</td><td>DOOR</td><td>1500</td><td>2000</td><td>2000</td><td>LIVING</td><td>UPVC FRAME GLASS DOOR</td></tr> <tr><td>25</td><td>DOOR</td><td>1500</td><td>2000</td><td>2000</td><td>LIVING</td><td>UPVC FRAME GLASS DOOR</td></tr> <tr><td>26</td><td>DOOR</td><td>1500</td><td>2000</td><td>2000</td><td>LIVING</td><td>UPVC FRAME GLASS DOOR</td></tr> <tr><td>27</td><td>DOOR</td><td>1500</td><td>2000</td><td>2000</td><td>LIVING</td><td>UPVC FRAME GLASS DOOR</td></tr> <tr><td>28</td><td>DOOR</td><td>1500</td><td>2000</td><td>2000</td><td>LIVING</td><td>UPVC FRAME GLASS DOOR</td></tr> <tr><td>29</td><td>DOOR</td><td>1500</td><td>2000</td><td>2000</td><td>LIVING</td><td>UPVC FRAME GLASS DOOR</td></tr> <tr><td>30</td><td>DOOR</td><td>1500</td><td>2000</td><td>2000</td><td>LIVING</td><td>UPVC FRAME GLASS DOOR</td></tr> </tbody> </table> | | SL. NO. | TYPE | OPENING | HEIGHT | LEVEL | LOCATION | DESCRIPTION | 1 | DOOR | 2000 | 2000 | 2000 | LIVING | UPVC FRAME GLASS DOOR | 2 | DOOR | 2000 | 2000 | 2000 | LIVING | UPVC FRAME GLASS DOOR | 3 | DOOR | 1500 | 2000 | 2000 | LIVING | UPVC FRAME GLASS DOOR | 4 | DOOR | 1500 | 2000 | 2000 | LIVING | UPVC FRAME GLASS DOOR | 5 | DOOR | 1500 | 2000 | 2000 | LIVING | UPVC FRAME GLASS DOOR | 6 | DOOR | 1500 | 2000 | 2000 | LIVING | UPVC FRAME GLASS DOOR | 7 | DOOR | 1500 | 2000 | 2000 | LIVING | UPVC FRAME GLASS DOOR | 8 | DOOR | 1500 | 2000 | 2000 | LIVING | UPVC FRAME GLASS DOOR | 9 | DOOR | 1500 | 2000 | 2000 | LIVING | UPVC FRAME GLASS DOOR | 10 | DOOR | 1500 | 2000 | 2000 | LIVING | UPVC FRAME GLASS DOOR | 11 | DOOR | 1500 | 2000 | 2000 | LIVING | UPVC FRAME GLASS DOOR | 12 | DOOR | 1500 | 2000 | 2000 | LIVING | UPVC FRAME GLASS DOOR | 13 | DOOR | 1500 | 2000 | 2000 | LIVING | UPVC FRAME GLASS DOOR | 14 | DOOR | 1500 | 2000 | 2000 | LIVING | UPVC FRAME GLASS DOOR | 15 | DOOR | 1500 | 2000 | 2000 | LIVING | UPVC FRAME GLASS DOOR | 16 | DOOR | 1500 | 2000 | 2000 | LIVING | UPVC FRAME GLASS DOOR | 17 | DOOR | 1500 | 2000 | 2000 | LIVING | UPVC FRAME GLASS DOOR | 18 | DOOR | 1500 | 2000 | 2000 | LIVING | UPVC FRAME GLASS DOOR | 19 | DOOR | 1500 | 2000 | 2000 | LIVING | UPVC FRAME GLASS DOOR | 20 | DOOR | 1500 | 2000 | 2000 | LIVING | UPVC FRAME GLASS DOOR | 21 | DOOR | 1500 | 2000 | 2000 | LIVING | UPVC FRAME GLASS DOOR | 22 | DOOR | 1500 | 2000 | 2000 | LIVING | UPVC FRAME GLASS DOOR | 23 | DOOR | 1500 | 2000 | 2000 | LIVING | UPVC FRAME GLASS DOOR | 24 | DOOR | 1500 | 2000 | 2000 | LIVING | UPVC FRAME GLASS DOOR | 25 | DOOR | 1500 | 2000 | 2000 | LIVING | UPVC FRAME GLASS DOOR | 26 | DOOR | 1500 | 2000 | 2000 | LIVING | UPVC FRAME GLASS DOOR | 27 | DOOR | 1500 | 2000 | 2000 | LIVING | UPVC FRAME GLASS DOOR | 28 | DOOR | 1500 | 2000 | 2000 | LIVING | UPVC FRAME GLASS DOOR | 29 | DOOR | 1500 | 2000 | 2000 | LIVING | UPVC FRAME GLASS DOOR | 30 | DOOR | 1500 | 2000 | 2000 | LIVING | UPVC FRAME GLASS DOOR |
| SL. NO. | TYPE | OPENING | HEIGHT | LEVEL | LOCATION | DESCRIPTION | |
| 1 | DOOR | 2000 | 2000 | 2000 | LIVING | UPVC FRAME GLASS DOOR | |
| 2 | DOOR | 2000 | 2000 | 2000 | LIVING | UPVC FRAME GLASS DOOR | |
| 3 | DOOR | 1500 | 2000 | 2000 | LIVING | UPVC FRAME GLASS DOOR | |
| 4 | DOOR | 1500 | 2000 | 2000 | LIVING | UPVC FRAME GLASS DOOR | |
| 5 | DOOR | 1500 | 2000 | 2000 | LIVING | UPVC FRAME GLASS DOOR | |
| 6 | DOOR | 1500 | 2000 | 2000 | LIVING | UPVC FRAME GLASS DOOR | |
| 7 | DOOR | 1500 | 2000 | 2000 | LIVING | UPVC FRAME GLASS DOOR | |
| 8 | DOOR | 1500 | 2000 | 2000 | LIVING | UPVC FRAME GLASS DOOR | |
| 9 | DOOR | 1500 | 2000 | 2000 | LIVING | UPVC FRAME GLASS DOOR | |
| 10 | DOOR | 1500 | 2000 | 2000 | LIVING | UPVC FRAME GLASS DOOR | |
| 11 | DOOR | 1500 | 2000 | 2000 | LIVING | UPVC FRAME GLASS DOOR | |
| 12 | DOOR | 1500 | 2000 | 2000 | LIVING | UPVC FRAME GLASS DOOR | |
| 13 | DOOR | 1500 | 2000 | 2000 | LIVING | UPVC FRAME GLASS DOOR | |
| 14 | DOOR | 1500 | 2000 | 2000 | LIVING | UPVC FRAME GLASS DOOR | |
| 15 | DOOR | 1500 | 2000 | 2000 | LIVING | UPVC FRAME GLASS DOOR | |
| 16 | DOOR | 1500 | 2000 | 2000 | LIVING | UPVC FRAME GLASS DOOR | |
| 17 | DOOR | 1500 | 2000 | 2000 | LIVING | UPVC FRAME GLASS DOOR | |
| 18 | DOOR | 1500 | 2000 | 2000 | LIVING | UPVC FRAME GLASS DOOR | |
| 19 | DOOR | 1500 | 2000 | 2000 | LIVING | UPVC FRAME GLASS DOOR | |
| 20 | DOOR | 1500 | 2000 | 2000 | LIVING | UPVC FRAME GLASS DOOR | |
| 21 | DOOR | 1500 | 2000 | 2000 | LIVING | UPVC FRAME GLASS DOOR | |
| 22 | DOOR | 1500 | 2000 | 2000 | LIVING | UPVC FRAME GLASS DOOR | |
| 23 | DOOR | 1500 | 2000 | 2000 | LIVING | UPVC FRAME GLASS DOOR | |
| 24 | DOOR | 1500 | 2000 | 2000 | LIVING | UPVC FRAME GLASS DOOR | |
| 25 | DOOR | 1500 | 2000 | 2000 | LIVING | UPVC FRAME GLASS DOOR | |
| 26 | DOOR | 1500 | 2000 | 2000 | LIVING | UPVC FRAME GLASS DOOR | |
| 27 | DOOR | 1500 | 2000 | 2000 | LIVING | UPVC FRAME GLASS DOOR | |
| 28 | DOOR | 1500 | 2000 | 2000 | LIVING | UPVC FRAME GLASS DOOR | |
| 29 | DOOR | 1500 | 2000 | 2000 | LIVING | UPVC FRAME GLASS DOOR | |
| 30 | DOOR | 1500 | 2000 | 2000 | LIVING | UPVC FRAME GLASS DOOR | |
| OWNER GODREJ PROPERTIES LIMITED | |
| SUBMISSION DRAWING | |
| KEY PLAN TOWER - 7 S-24 | |
| PROJECT PROPOSED GROUP HOUSING FOR PLOT NO. :- GH-01/B,C,D,E,J & K SECTOR -12, GREATER NOIDA, G.B. NAGAR, (U.P.) | |
| DATE 08 - 01 - 2025 | PROJECT INCH. BALRAJ SINGH | CHECKED BY BALRAJ SINGH | |
| SCALE 1:100 | DEALT BY ABDHESH JHA | APPROVED BY VISHAL SHARMA | |
| DRAWING TITLE 2ND TO 18TH & 20TH TO 24TH FLOOR PLAN (TYPICAL) | |
| TOWER - 7 | |
| ARCHITECTS GIA GOLDEN INDIA ARCHITECTS THE TEAM OF ARCHITECTS FF-37, KADAMBA SHOPPING COMPLEX GAMMA-IGREATER NOIDA CON. +91-94-1585-6777 | |
| DESIGN BY: Confluence NEW DELHI, INDIA F-1, FIRST FLOOR, MIRA CORPORATE SUITES, ISHWAR NAGAR, NEW DELHI 110065 Ph- +91-11-26925684 ccs@inconfluence.com Member of IGBC Ph- +91-11-40564768 www.inconfluence.com ISO - 9001 - 2000 architecture urban design hospitality interiors | |
| DRAWING NO. S-63 | REVISION | |

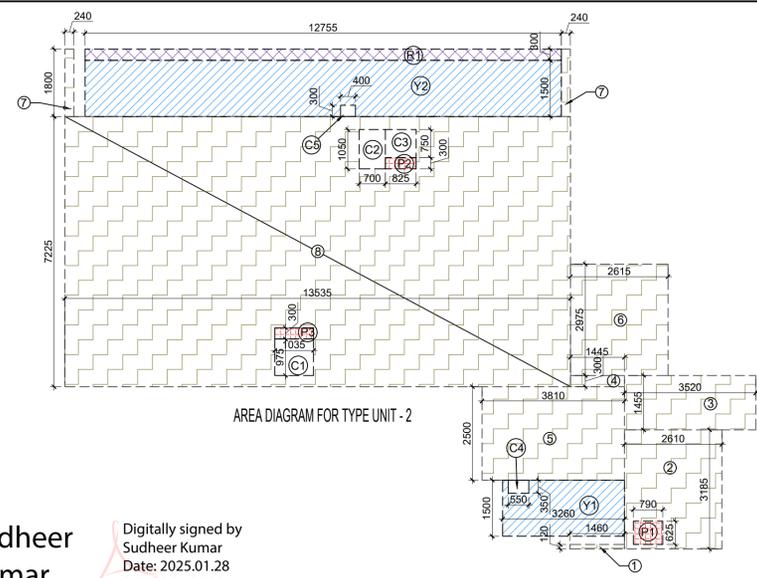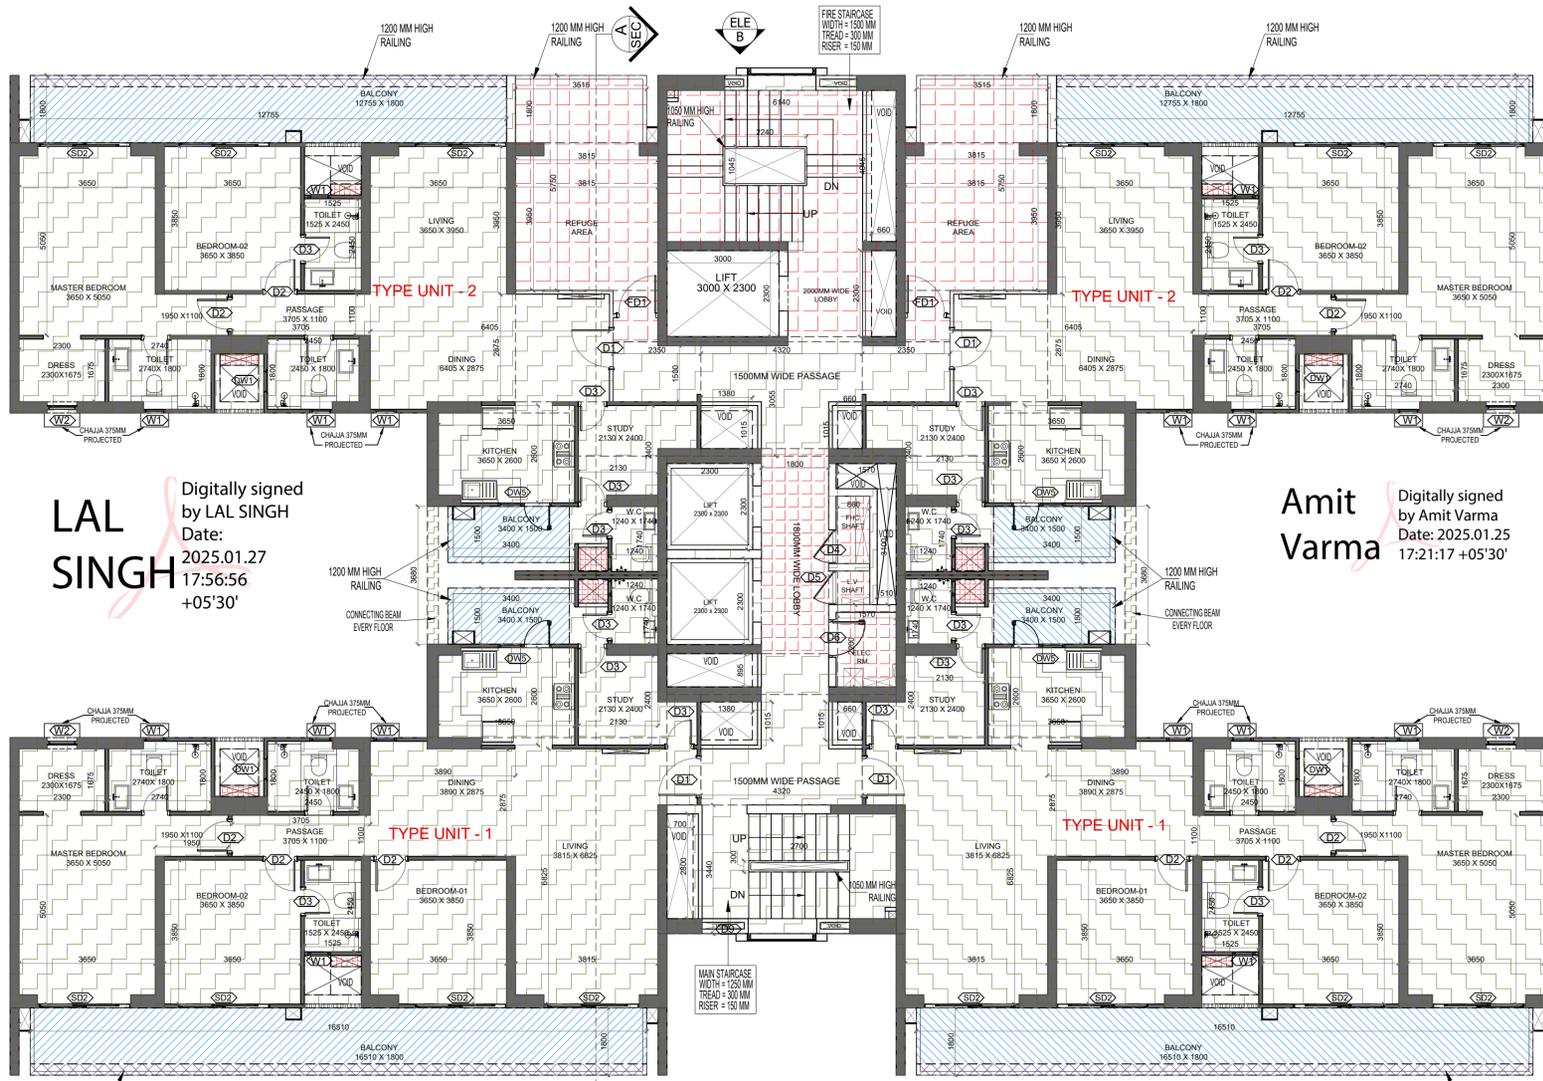

LAL SINGH
Digitally signed by LAL SINGH
Date: 2025.01.27
17:56:56
+05'30'

Amit Varma
Digitally signed by Amit Varma
Date: 2025.01.25
17:21:17 +05'30'

Sudheer Kumar
Digitally signed by Sudheer Kumar
Date: 2025.01.28
14:45:27 +05'30'

LEGEND

- F.A.R. AREA
- 15 % SERVICES AREA
- NON F.A.R. AREA
- COUNTED IN 1/4 F.A.R. AREA

REFUGE AREA REQUIRED -
- 831.158 SQMTR (BLDG. PLATE) X 2 FLOORS X 0.3
= 498.695 / 12.5 + 0.9 SQM (for spec. abled)
= 40.795 SQM. SAY - 41.00 SQM.
REFUGE AREA PROPOSED = 46.093 SQM

| TOTAL F.A.R. AREA AT 19TH FLOOR PLAN (REFUGE LVL.) | | | |
|--|--------------------------------|----------------|---|
| S.NO. | PARTICULARS | AREA (SQM) | |
| 1 | F.A.R. AREA OF UNIT - 1 | 149.492 | = |
| 2 | F.A.R. AREA OF UNIT - 2 | 127.544 | = |
| 3 | F.A.R. AREA OF CIRCULATION | 62.627 | = |
| 4 | F.A.R. AREA OF CONNECTING BEAM | 2.208 | = |
| TOTAL F.A.R. AREA | | 341.871 | |

| TOTAL NON F.A.R. AREA AT 19TH FLOOR PLAN (REFUGE LVL.) | | | |
|--|-------------|----------------|---|
| S.NO. | PARTICULARS | AREA (SQM) | |
| 1 | UNIT - 1 | 33.057 | X |
| 2 | UNIT - 2 | 26.580 | X |
| TOTAL BALCONY AREA | | 119.274 | |

| F.A.R. AREA AT CONNECTING BEAM (EVERY FLOOR) | | | |
|--|-------------|--------------|---|
| S.NO. | PARTICULARS | AREA (SQM) | |
| 1 | | 3.680 | X |
| TOTAL F.A.R. AREA | | 2.208 | |


| F.A.R. COVERED AREA CALCULATION FOR TYPE UNIT - 1 | | | |
|---|-------------------|----------------|---|
| S.NO. | PARTICULARS | AREA (SQM) | |
| 1 | 1.460 X 0.120 | 0.175 | = |
| 2 | 2.610 X 4.340 | 11.327 | = |
| 3 | 0.910 X 2.955 | 2.689 | = |
| 4 | 3.810 X 2.500 | 9.525 | = |
| 5 | 0.240 X 1.800 X 2 | 0.864 | = |
| 6 | 17.550 X 7.225 | 127.088 | = |
| UNIT FAR AREA = (A) | | 151.668 | |
| AREA SUBTRACTION PLUMBING CUTOFF | | | |
| P1 | 0.750 X 0.625 | 0.469 | = |
| P2 | 0.825 X 0.300 | 0.248 | = |
| P3 | 1.035 X 0.300 | 0.311 | = |
| C1 | 0.750 X 0.975 | 0.731 | = |
| C2 | 0.700 X 1.950 | 1.365 | = |
| C3 | 0.825 X 0.750 | 0.619 | = |
| TOTAL (B) | | 3.415 | |
| TOTAL F.A.R. AREA C = (A - B) | | 148.254 | |
| 1/4 F.A.R. AREA OF BALCONY | | | |
| R1 | 16.510 X 0.300 | 4.953 | = |
| TOTAL AREA (D) | | 4.953 | |
| 1/4 BALCONY F.A.R. AREA (E) | | 1.238 | |
| TOTAL UNIT F.A.R. AREA F = (C + E) | | 149.492 | |

| F.A.R. COVERED AREA CALCULATION FOR TYPE UNIT - 2 | | | |
|---|-------------------|----------------|---|
| S.NO. | PARTICULARS | AREA (SQM) | |
| 1 | 1.460 X 0.120 | 0.175 | = |
| 2 | 2.610 X 3.185 | 8.313 | = |
| 3 | 3.520 X 1.455 | 5.122 | = |
| 4 | 6.140 X 0.300 | 1.842 | = |
| 5 | 3.810 X 2.500 | 9.525 | = |
| 6 | 17.550 X 7.225 | 127.088 | = |
| 7 | 0.240 X 1.800 X 2 | 0.864 | = |
| 8 | 13.535 X 7.225 | 97.790 | = |
| UNIT FAR AREA = (A) | | 130.002 | |
| AREA SUBTRACTION PLUMBING CUTOFF | | | |
| P1 | 0.750 X 0.625 | 0.469 | = |
| P2 | 0.825 X 0.300 | 0.248 | = |
| P3 | 1.035 X 0.300 | 0.311 | = |
| C1 | 0.750 X 0.975 | 0.731 | = |
| C2 | 0.700 X 1.950 | 1.365 | = |
| C3 | 0.825 X 0.750 | 0.619 | = |
| TOTAL (B) | | 3.415 | |
| TOTAL F.A.R. AREA C = (A - B) | | 126.588 | |
| 1/4 F.A.R. AREA OF BALCONY | | | |
| R1 | 12.755 X 0.300 | 3.827 | = |
| TOTAL AREA (D) | | 3.827 | |
| 1/4 BALCONY F.A.R. AREA (E) | | 0.957 | |
| TOTAL UNIT F.A.R. AREA F = (C + E) | | 127.544 | |

| F.A.R. COVERED AREA CALCULATION FOR CIRCULATION AREA | | | |
|--|-------------------|----------------|---|
| S.NO. | PARTICULARS | AREA (SQM) | |
| 1 | 6.620 X 7.120 | 47.134 | = |
| 2 | 4.320 X 3.055 | 13.188 | = |
| 3 | 2.350 X 1.800 X 2 | 7.520 | = |
| 4 | 6.140 X 6.375 | 39.140 | = |
| 5 | 4.320 X 2.955 | 12.768 | = |
| 6 | 6.140 X 3.440 | 21.122 | = |
| TOTAL AREA (A) | | 140.882 | |
| AREA SUBTRACTION | | | |
| FS1 | 6.140 X 5.585 | 34.307 | = |
| LL1 | 1.800 X 5.480 | 9.864 | = |
| LV1 | 0.960 X 0.900 | 0.774 | = |
| FH1 | 0.960 X 1.800 | 1.548 | = |
| EL1 | 1.570 X 2.200 | 3.454 | = |
| L2 | 2.300 X 2.300 X 2 | 10.500 | = |
| H4 | 1.380 X 1.015 X 2 | 2.801 | = |
| H5 | 0.960 X 1.015 X 2 | 1.340 | = |
| H6 | 1.570 X 0.670 | 1.052 | = |
| H7 | 0.910 X 3.100 | 2.821 | = |
| H8 | 2.300 X 0.895 | 2.059 | = |
| H9 | 2.700 X 0.300 | 0.810 | = |
| H10 | 0.700 X 2.800 | 1.960 | = |
| TOTAL (B) | | 78.255 | |
| TOTAL F.A.R. AREA CORRIDOR C = (A - B) | | 62.627 | |

| CORRIDOR AREA CALCULATION TOWARDS 15% ADDITIONAL F.A.R. | | | |
|---|-------------------|---------------|---|
| S.NO. | PARTICULARS | AREA (SQM) | |
| 1 | 6.140 X 5.585 | 34.307 | = |
| 2 | 1.800 X 5.480 | 9.864 | = |
| 3 | 0.960 X 0.900 | 0.774 | = |
| 4 | 0.960 X 1.800 | 1.548 | = |
| 5 | 1.570 X 2.200 | 3.454 | = |
| 6 | 2.300 X 2.300 X 2 | 10.500 | = |
| 7 | 1.380 X 1.015 X 2 | 2.801 | = |
| 8 | 0.960 X 1.015 X 2 | 1.340 | = |
| 9 | 1.570 X 0.670 | 1.052 | = |
| 10 | 0.910 X 3.100 | 2.821 | = |
| 11 | 2.300 X 0.895 | 2.059 | = |
| 12 | 2.700 X 0.300 | 0.810 | = |
| 13 | 0.700 X 2.800 | 1.960 | = |
| TOTAL (B) | | 78.255 | |
| TOTAL 15% ADDITIONAL F.A.R. AREA E = (C - D) | | 92.843 | |

| TOTAL CORRIDOR AREA CALCULATION TOWARDS 15% ADDITIONAL F.A.R. | | | |
|---|-------------------|---------------|---|
| S.NO. | PARTICULARS | AREA (SQM) | |
| 1 | 6.140 X 5.585 | 34.307 | = |
| 2 | 1.800 X 5.480 | 9.864 | = |
| 3 | 0.960 X 0.900 | 0.774 | = |
| 4 | 0.960 X 1.800 | 1.548 | = |
| 5 | 1.570 X 2.200 | 3.454 | = |
| 6 | 2.300 X 2.300 X 2 | 10.500 | = |
| 7 | 1.380 X 1.015 X 2 | 2.801 | = |
| 8 | 0.960 X 1.015 X 2 | 1.340 | = |
| 9 | 1.570 X 0.670 | 1.052 | = |
| 10 | 0.910 X 3.100 | 2.821 | = |
| 11 | 2.300 X 0.895 | 2.059 | = |
| 12 | 2.700 X 0.300 | 0.810 | = |
| 13 | 0.700 X 2.800 | 1.960 | = |
| TOTAL (B) | | 78.255 | |
| TOTAL 15% ADDITIONAL F.A.R. AREA E = (C - D) | | 92.843 | |

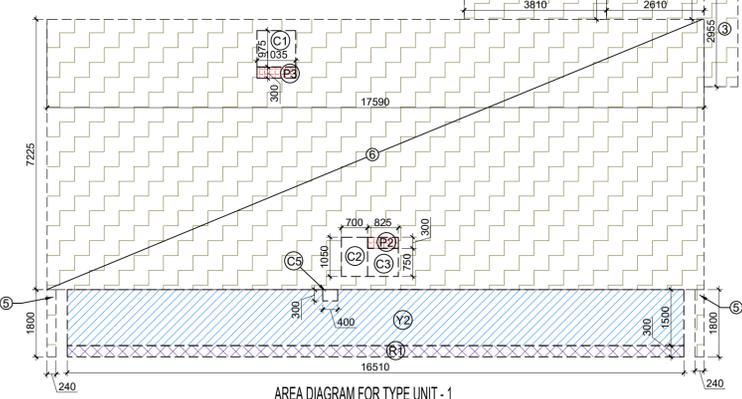

| NON F.A.R. AREA OF BALCONY | | | |
|--|-------------------------------|----------------|---|
| S.NO. | PARTICULARS | AREA (SQM) | |
| Y1 | 2.205 X 1.500 | 4.890 | = |
| Y3 | 16.510 X 1.500 | 24.765 | = |
| 3/4 AREA OF BALCONY (D - E) | | 37.15 | |
| TOTAL (G) | | 33.370 | |
| AREA SUBTRACTION | | | |
| C4 | 0.550 X 0.350 | 0.193 | = |
| C5 | 0.400 X 0.300 | 0.120 | = |
| TOTAL AREA (H) | | 0.313 | |
| TOTAL BALCONY AREA J = (G - H) | | 33.057 | |
| 15% SERVICES AREA OF UNIT (PLUMBING SHAFT) | | | |
| P1 | 0.750 X 0.625 | 0.469 | = |
| P2 | 0.825 X 0.300 | 0.248 | = |
| P3 | 1.035 X 0.300 | 0.311 | = |
| TOTAL 15% SERVICES AREA OF UNIT (K) | | 1.022 | |
| COVERED AREA FOR UNIT = (F + J + K) | | | |
| 1 | TOTAL UNIT F.A.R. AREA (F) | 149.492 | = |
| 2 | NON F.A.R. AREA OF UNIT (J) | 33.057 | = |
| 3 | 15% SERVICES AREA OF UNIT (K) | 1.022 | = |
| TOTAL UNIT COVERAGE AREA | | 183.601 | |

| NON F.A.R. AREA OF BALCONY | | | |
|--|-------------------------------|----------------|---|
| S.NO. | PARTICULARS | AREA (SQM) | |
| Y1 | 2.205 X 1.500 | 4.890 | = |
| Y3 | 12.755 X 1.500 | 19.133 | = |
| 3/4 AREA OF BALCONY (D - E) | | 26.892 | |
| TOTAL (G) | | 26.892 | |
| AREA SUBTRACTION | | | |
| C4 | 0.550 X 0.350 | 0.193 | = |
| C5 | 0.400 X 0.300 | 0.120 | = |
| TOTAL AREA (H) | | 0.313 | |
| TOTAL BALCONY AREA J = (G - H) | | 26.580 | |
| 15% SERVICES AREA OF UNIT (PLUMBING SHAFT) | | | |
| P1 | 0.750 X 0.625 | 0.469 | = |
| P2 | 0.825 X 0.300 | 0.248 | = |
| P3 | 1.035 X 0.300 | 0.311 | = |
| TOTAL 15% SERVICES AREA OF UNIT (K) | | 1.022 | |
| COVERED AREA FOR UNIT = (F + J + K) | | | |
| 1 | TOTAL UNIT F.A.R. AREA (F) | 127.544 | = |
| 2 | NON F.A.R. AREA OF UNIT (J) | 26.580 | = |
| 3 | 15% SERVICES AREA OF UNIT (K) | 1.022 | = |
| TOTAL UNIT COVERAGE AREA | | 155.176 | |

| TOTAL CORRIDOR AREA CALCULATION TOWARDS 15% ADDITIONAL F.A.R. | | | |
|---|-------------------|---------------|---|
| S.NO. | PARTICULARS | AREA (SQM) | |
| 1 | 6.140 X 5.585 | 34.307 | = |
| 2 | 1.800 X 5.480 | 9.864 | = |
| 3 | 0.960 X 0.900 | 0.774 | = |
| 4 | 0.960 X 1.800 | 1.548 | = |
| 5 | 1.570 X 2.200 | 3.454 | = |
| 6 | 2.300 X 2.300 X 2 | 10.500 | = |
| 7 | 1.380 X 1.015 X 2 | 2.801 | = |
| 8 | 0.960 X 1.015 X 2 | 1.340 | = |
| 9 | 1.570 X 0.670 | 1.052 | = |
| 10 | 0.910 X 3.100 | 2.821 | = |
| 11 | 2.300 X 0.895 | 2.059 | = |
| 12 | 2.700 X 0.300 | 0.810 | = |
| 13 | 0.700 X 2.800 | 1.960 | = |
| TOTAL (B) | | 78.255 | |
| TOTAL 15% ADDITIONAL F.A.R. AREA E = (C - D) | | 92.843 | |

| TOTAL CORRIDOR AREA CALCULATION TOWARDS 15% ADDITIONAL F.A.R. | | | |
|---|-------------------|---------------|---|
| S.NO. | PARTICULARS | AREA (SQM) | |
| 1 | 6.140 X 5.585 | 34.307 | = |
| 2 | 1.800 X 5.480 | 9.864 | = |
| 3 | 0.960 X 0.900 | 0.774 | = |
| 4 | 0.960 X 1.800 | 1.548 | = |
| 5 | 1.570 X 2.200 | 3.454 | = |
| 6 | 2.300 X 2.300 X 2 | 10.500 | = |
| 7 | 1.380 X 1.015 X 2 | 2.801 | = |
| 8 | 0.960 X 1.015 X 2 | 1.340 | = |
| 9 | 1.570 X 0.670 | 1.052 | = |
| 10 | 0.910 X 3.100 | 2.821 | = |
| 11 | 2.300 X 0.895 | 2.059 | = |
| 12 | 2.700 X 0.300 | 0.810 | = |
| 13 | 0.700 X 2.800 | 1.960 | = |
| TOTAL (B) | | 78.255 | |
| TOTAL 15% ADDITIONAL F.A.R. AREA E = (C - D) | | 92.843 | |

| TOTAL CORRIDOR AREA CALCULATION TOWARDS 15% ADDITIONAL F.A.R. | | | |
|---|-------------------|---------------|---|
| S.NO. | PARTICULARS | AREA (SQM) | |
| 1 | 6.140 X 5.585 | 34.307 | = |
| 2 | 1.800 X 5.480 | 9.864 | = |
| 3 | 0.960 X 0.900 | 0.774 | = |
| 4 | 0.960 X 1.800 | 1.548 | = |
| 5 | 1.570 X 2.200 | 3.454 | = |
| 6 | 2.300 X 2.300 X 2 | 10.500 | = |
| 7 | 1.380 X 1.015 X 2 | 2.801 | = |
| 8 | 0.960 X 1.015 X 2 | 1.340 | = |
| 9 | 1.570 X 0.670 | 1.052 | = |
| 10 | 0.910 X 3.100 | 2.821 | = |
| 11 | 2.300 X 0.895 | 2.059 | = |
| 12 | 2.700 X 0.300 | 0.810 | = |
| 13 | 0.700 X 2.800 | 1.960 | = |
| TOTAL (B) | | 78.255 | |
| TOTAL 15% ADDITIONAL F.A.R. AREA E = (C - D) | | 92.843 | |

OWNER SIGN: **Rajat pathak** 2025.01.2 3 12:43:06 +05'30'

ARCHITECT SIGN: **AVANISH SRIVASTAV** 2025.01.23 12:42:57 +05'30'

TOWN PLANNER SIGN: _____

DOOR SCHEDULE:

| S.NO. | TYPE | OPENING | HEIGHT | LEVEL | LOCATION | DESCRIPTION |
|-------|------|---------|--------|-------|----------|------------------------|
| 1 | DOOR | 2000 | 2000 | 2000 | LIVING | UPPER FRAME GLASS DOOR |
| 2 | DOOR | 2000 | 2000 | 2000 | LIVING | UPPER FRAME GLASS DOOR |
| 3 | DOOR | 2000 | 2000 | 2000 | LIVING | UPPER FRAME GLASS DOOR |
| 4 | DOOR | 2000 | 2000 | 2000 | LIVING | UPPER FRAME GLASS DOOR |
| 5 | DOOR | 2000 | 2000 | 2000 | LIVING | UPPER FRAME GLASS DOOR |
| 6 | DOOR | 2000 | 2000 | 2000 | LIVING | UPPER FRAME GLASS DOOR |
| 7 | DOOR | 2000 | 2000 | 2000 | LIVING | UPPER FRAME GLASS DOOR |
| 8 | DOOR | 2000 | 2000 | 2000 | | |

M.R.M & O.H.T TOP TERRACE
T.O.S. LVL.+83700 MM

MUMTY TERRACE LVL
T.O.S. LVL.+79300 MM

TERRACE
T.O.S. LVL.+76650 MM

24TH FLOOR FFL
+73750 MM

23RD FLOOR FFL
+70800 MM

22ND FLOOR FFL
+67850 MM

21ST FLOOR FFL
+64900MM

20TH FLOOR FFL
+61950 MM

19TH FLOOR FFL
REFUGE FLOOR
+59000 MM

18TH FLOOR FFL
+56050 MM

17TH FLOOR FFL
+53100 MM

16TH FLOOR FFL
+50150 MM

15TH FLOOR FFL
+47200 MM

14TH FLOOR FFL
+44250 MM

13TH FLOOR FFL
+41300 MM

12TH FLOOR FFL
+38350 MM

11TH FLOOR FFL
+35400 MM

10TH FLOOR FFL
+32450 MM

9TH FLOOR FFL
+29500 MM

8TH FLOOR FFL
+26550 MM

7TH FLOOR FFL
+23600 MM

6TH FLOOR FFL
+20650 MM

5TH FLOOR FFL
+17700 MM

4TH FLOOR FFL
+14750 MM

3RD FLOOR FFL
+11800 MM

2ND FLOOR FFL
+8850 MM

1ST FLOOR FFL
+5900 MM

PODIUM SLAB
F.F.L.+4400 MM

TOWER LOBBY FL.
+900 MM

STILT FLOOR FFL.(PARKING)
+750 MM

EXT. ROAD LVL
F.L.± 00 MM

INT ROAD LVL
F.L.+ 600 MM

BASEMENT FFL.(PARKING)
F.L.-5000 MM

LAL SINGH
Digitally signed
by LAL SINGH
Date:
2025.01.27
17:58:06 +05'30'


Sudheer Kumar
Digitally signed by Sudheer
Kumar
Date: 2025.01.28 14:51:47 +05'30'

Amit Varma
Digitally signed
by Amit Varma
Date:
2025.01.25
17:22:55 +05'30'

OWNER SIGN
Rajat pathak
Rajat pathak
2025.01.23
12:44:50
+05'30'

ARCHITECT SIGN
AVANISH SRIVASTAV
AVANISH SRIVASTAV
2025.01.23
12:44:41
+05'30'

TOWN PLANNER SIGN

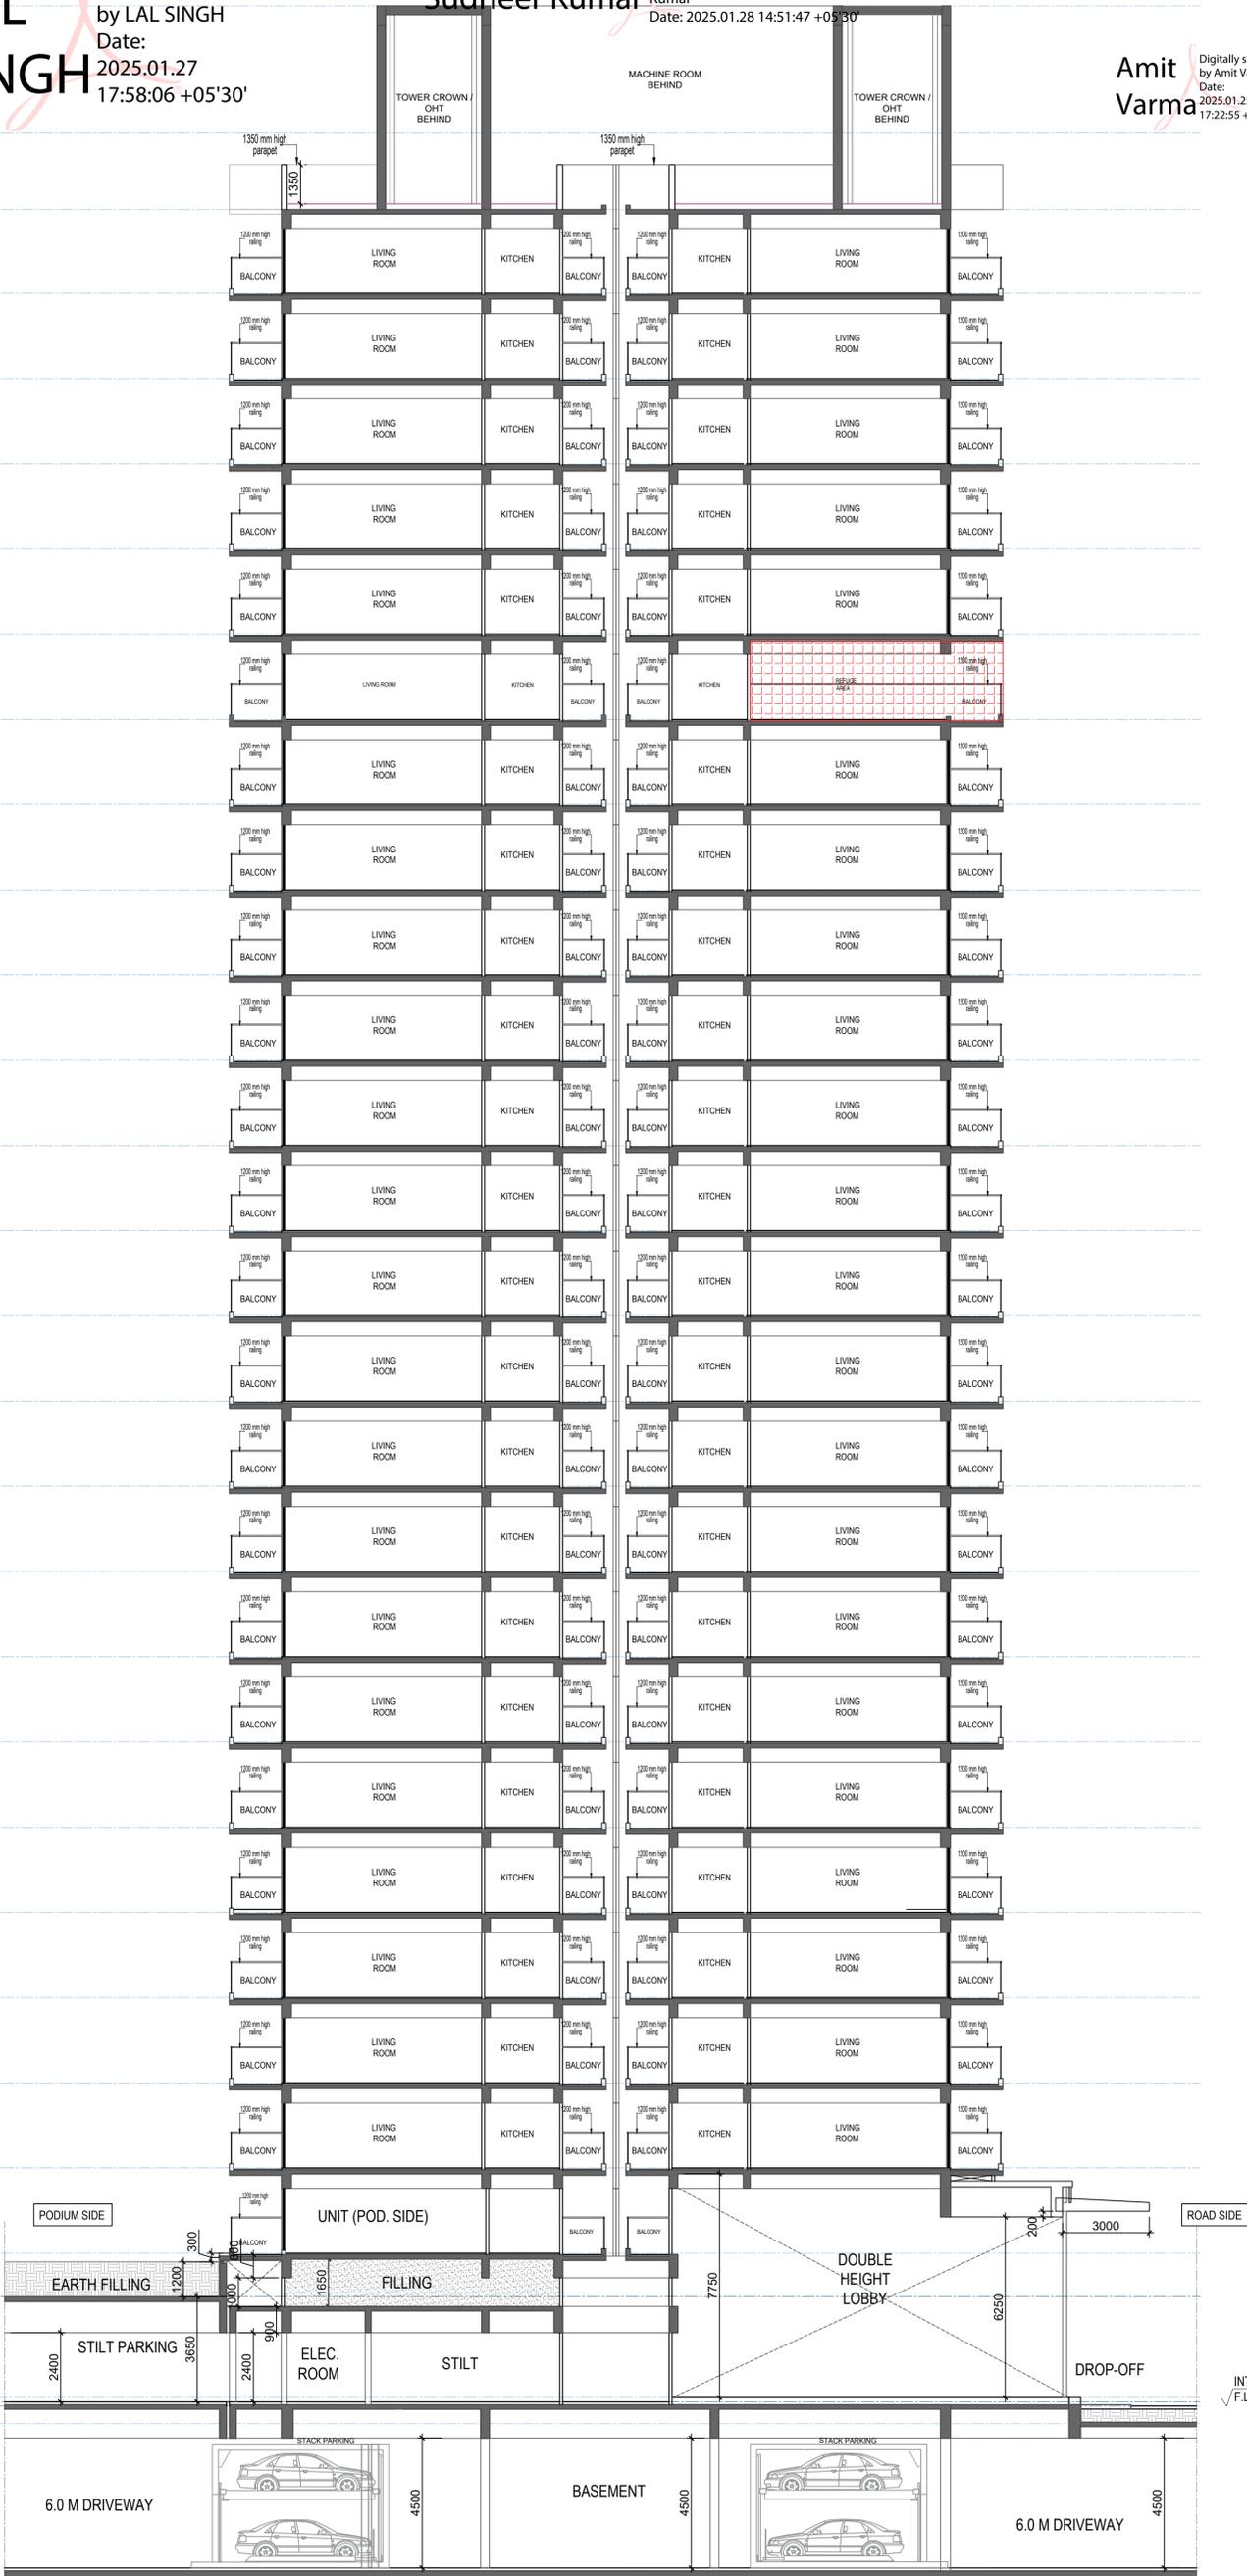

TOWER 7 SECTION A-A'

OWNER
GODREJ PROPERTIES LIMITED

SUBMISSION DRAWING

KEY PLAN TOWER - 7
S+24

PROJECT
PROPOSED GROUP HOUSING FOR
PLOT NO :- GH-01/B,C,D,E,J & K SECTOR -12,
GREATER NOIDA, G.B. NAGAR, (U.P.)

| | | |
|----------------|---------------|---------------|
| DATE | PROJECT INCH. | CHECKED BY |
| 08 - 01 - 2025 | BALRAJ SINGH | BALRAJ SINGH |
| SCALE | DEALT BY | APPROVED BY |
| 1:100 | ABDHESH JHA | VISHAL SHARMA |

DRAWING TITLE
SECTION - A-A'

TOWER 7


ARCHITECTS
GOLDEN INDIA ARCHITECTS
THE TEAM OF ARCHITECTS
FF-37, KADAMBA SHOPPING COMPLEX
GAMMA-IGREATER NOIDA
CON...+91-94-1585-6777

DESIGN BY:
Confluence
NEW DELHI, INDIA

F-1, FIRST FLOOR, MIRA CORPORATE SUITES,
ISHWAR NAGAR, NEW DELHI 110065

PH: +91-11-26925684 ccs@confluence.com Member of IGBC
P: +91-11-40564768 www.confluence.com ISO - 9001 : 2000
architecture urban design hospitality Interiors


DRAWING NO. S-68 REVISION

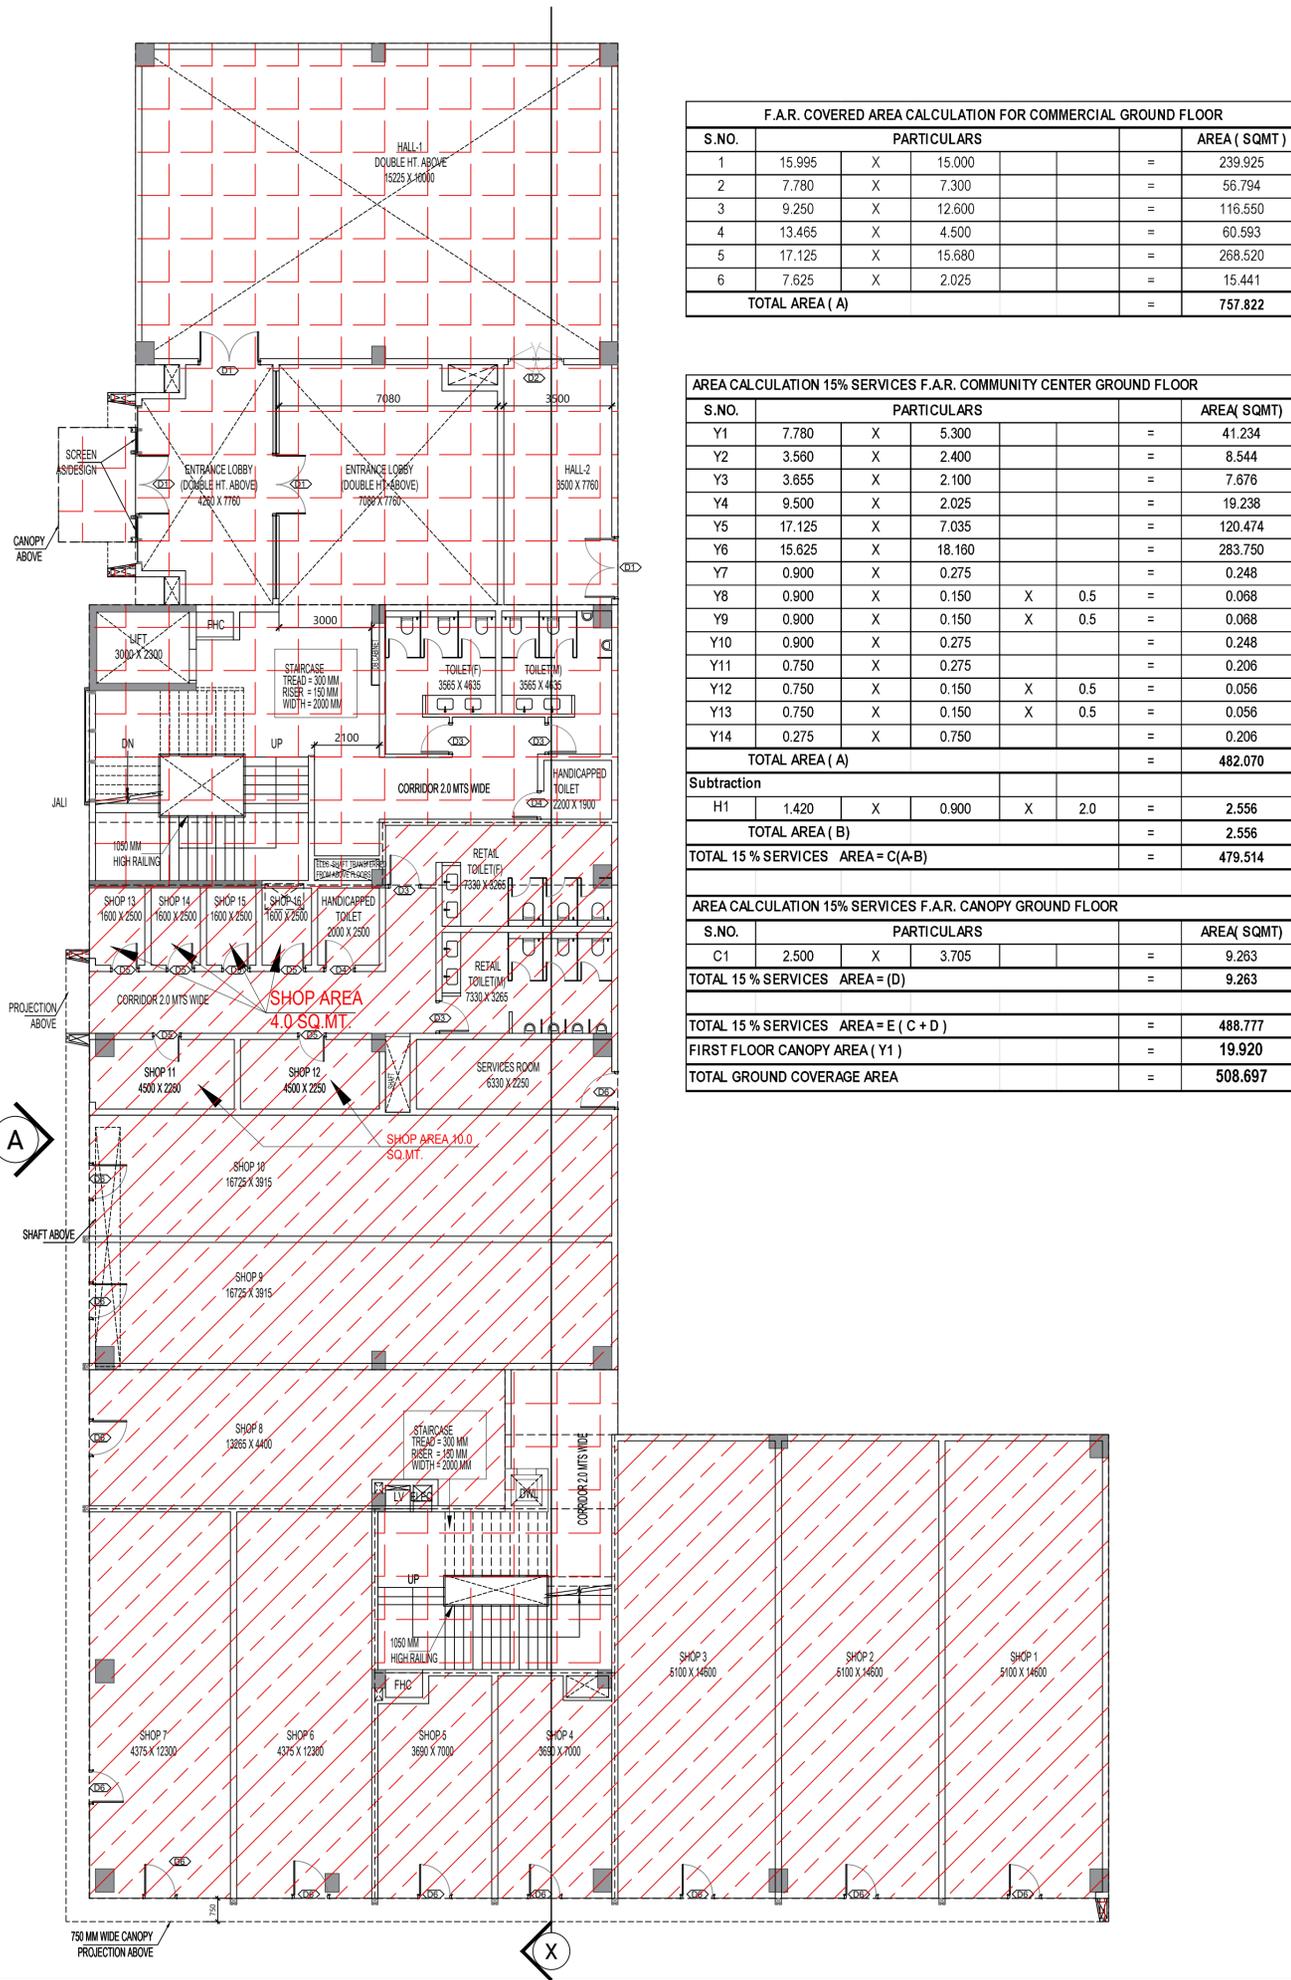

| F.A.R. COVERED AREA CALCULATION FOR COMMERCIAL GROUND FLOOR | | | | | |
|---|-------------|---|--------|---|----------------|
| S.NO. | PARTICULARS | | | | AREA (SQMT) |
| 1 | 15.995 | X | 15.000 | = | 239.925 |
| 2 | 7.780 | X | 7.300 | = | 56.794 |
| 3 | 9.250 | X | 12.600 | = | 116.550 |
| 4 | 13.465 | X | 4.500 | = | 60.593 |
| 5 | 17.125 | X | 15.680 | = | 268.520 |
| 6 | 7.625 | X | 2.025 | = | 15.441 |
| TOTAL AREA (A) | | | | | 757.822 |

| AREA CALCULATION 15% SERVICES F.A.R. COMMUNITY CENTER GROUND FLOOR | | | | | | |
|--|-------------|---|--------|---|----------------|-------|
| S.NO. | PARTICULARS | | | | AREA(SQMT) | |
| Y1 | 7.780 | X | 5.300 | = | 41.234 | |
| Y2 | 3.560 | X | 2.400 | = | 8.544 | |
| Y3 | 3.655 | X | 2.100 | = | 7.676 | |
| Y4 | 9.500 | X | 2.025 | = | 19.238 | |
| Y5 | 17.125 | X | 7.035 | = | 120.474 | |
| Y6 | 15.625 | X | 18.180 | = | 283.750 | |
| Y7 | 0.900 | X | 0.275 | = | 0.248 | |
| Y8 | 0.900 | X | 0.150 | X | 0.5 | 0.068 |
| Y9 | 0.900 | X | 0.150 | X | 0.5 | 0.068 |
| Y10 | 0.900 | X | 0.275 | = | 0.248 | |
| Y11 | 0.750 | X | 0.275 | = | 0.206 | |
| Y12 | 0.750 | X | 0.150 | X | 0.5 | 0.056 |
| Y13 | 0.750 | X | 0.150 | X | 0.5 | 0.056 |
| Y14 | 0.275 | X | 0.750 | = | 0.206 | |
| TOTAL AREA (A) | | | | | 482.070 | |
| Subtraction | | | | | | |
| H1 | 1.420 | X | 0.900 | X | 2.0 | 2.556 |
| TOTAL AREA (B) | | | | | 2.556 | |
| TOTAL 15 % SERVICES AREA = C(A-B) | | | | | 479.514 | |

| AREA CALCULATION 15% SERVICES F.A.R. CANOPY GROUND FLOOR | | | | | |
|--|-------------|---|----------------|---|-------|
| S.NO. | PARTICULARS | | AREA(SQMT) | | |
| C1 | 2.500 | X | 3.705 | = | 9.263 |
| TOTAL 15 % SERVICES AREA = (D) | | | 9.263 | | |
| TOTAL 15 % SERVICES AREA = E (C + D) | | | 488.777 | | |
| FIRST FLOOR CANOPY AREA (Y1) | | | 19.920 | | |
| TOTAL GROUND COVERAGE AREA | | | 508.697 | | |

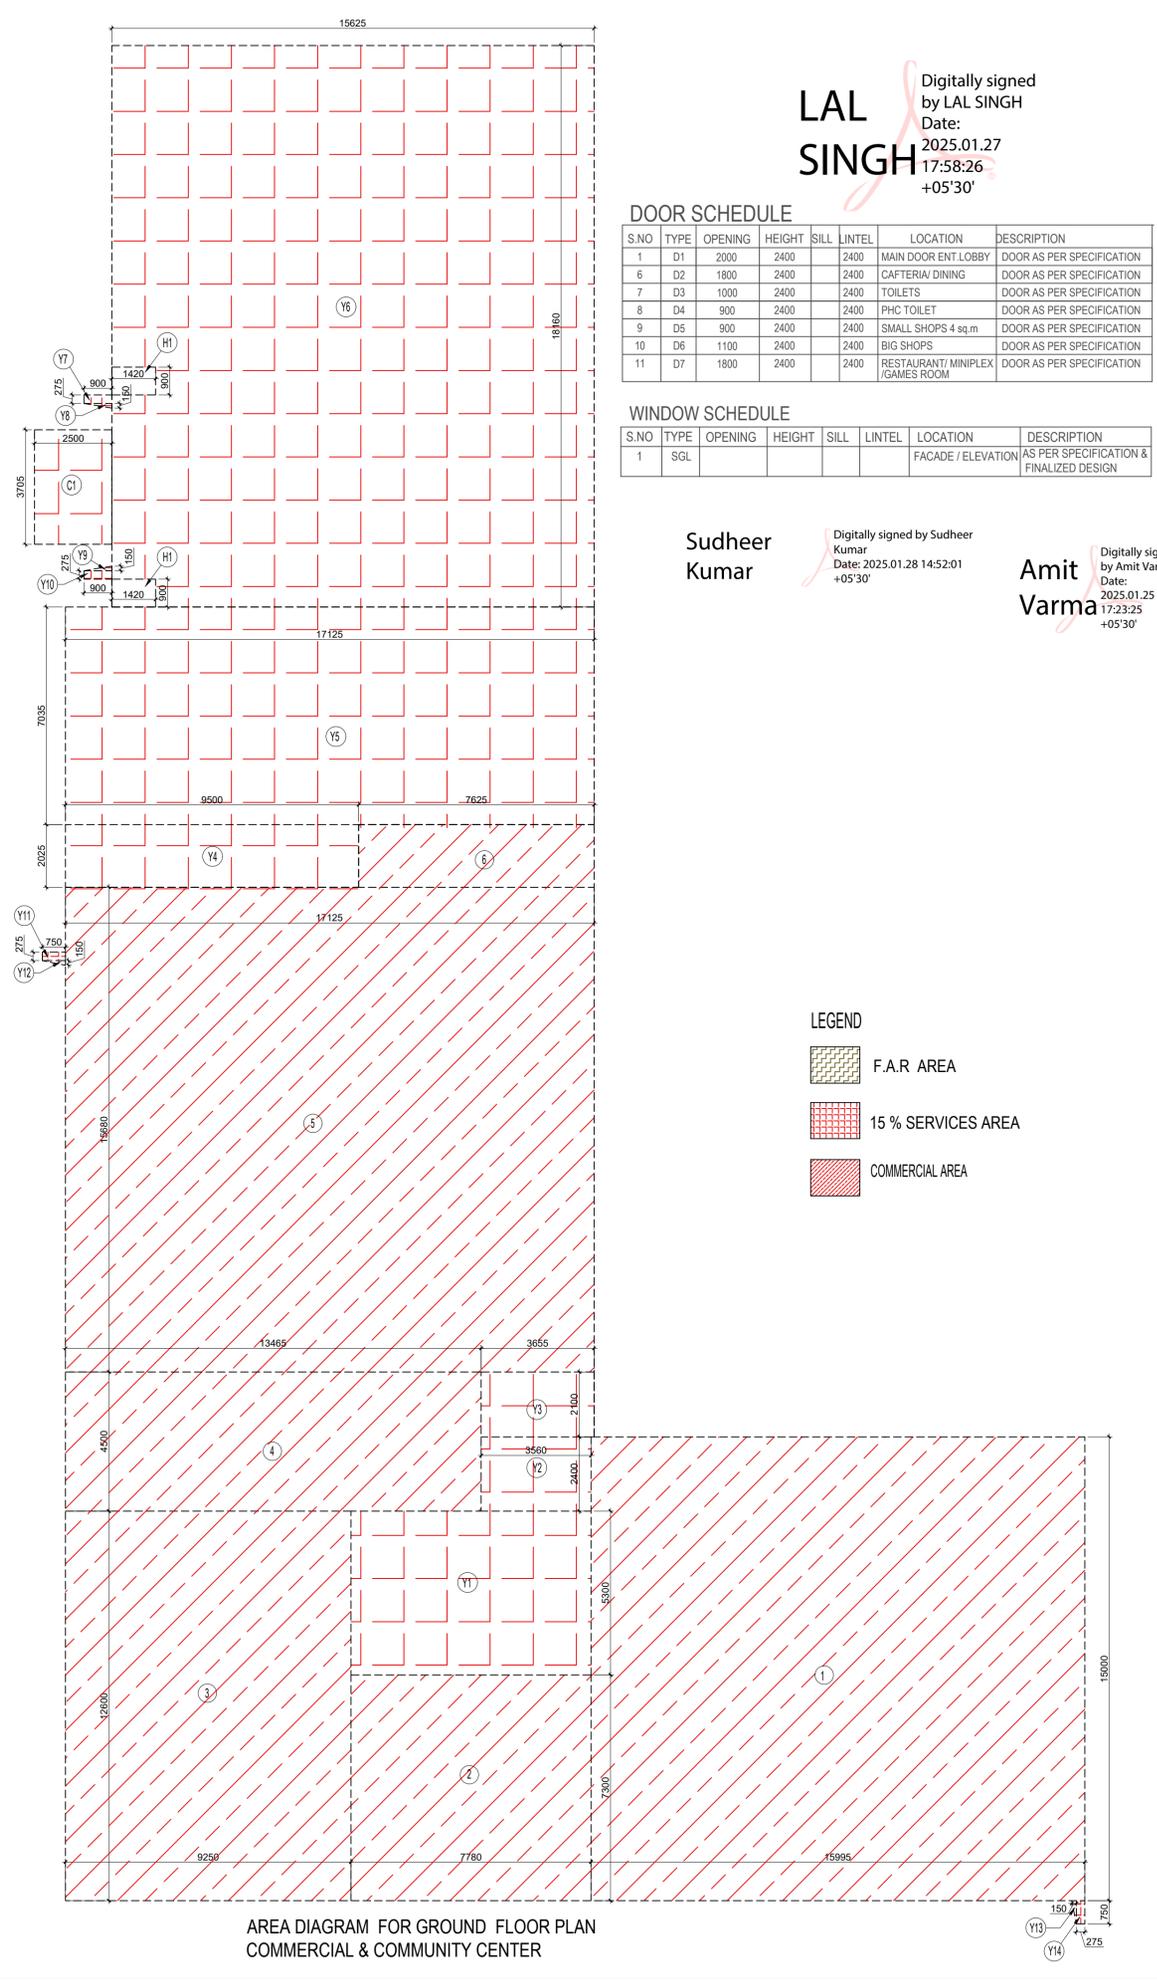

AREA DIAGRAM FOR GROUND FLOOR PLAN COMMERCIAL & COMMUNITY CENTER

LAL SINGH
Digitally signed by LAL SINGH
Date: 2025.01.27 17:58:26 +05'30'

| DOOR SCHEDULE | | | | | | | |
|---------------|------|---------|--------|------|--------|----------------------------------|---------------------------|
| S.NO | TYPE | OPENING | HEIGHT | SILL | LINTEL | LOCATION | DESCRIPTION |
| 1 | D1 | 2000 | 2400 | | 2400 | MAIN DOOR ENT LOBBY | DOOR AS PER SPECIFICATION |
| 6 | D2 | 1800 | 2400 | | 2400 | CAFTERIA/ DINING | DOOR AS PER SPECIFICATION |
| 7 | D3 | 1000 | 2400 | | 2400 | TOILETS | DOOR AS PER SPECIFICATION |
| 8 | D4 | 900 | 2400 | | 2400 | PHC TOILET | DOOR AS PER SPECIFICATION |
| 9 | D5 | 900 | 2400 | | 2400 | SMALL SHOPS 4 sq.m | DOOR AS PER SPECIFICATION |
| 10 | D6 | 1100 | 2400 | | 2400 | BIG SHOPS | DOOR AS PER SPECIFICATION |
| 11 | D7 | 1800 | 2400 | | 2400 | RESTAURANT/ MINIPLEX /GAMES ROOM | DOOR AS PER SPECIFICATION |

| WINDOW SCHEDULE | | | | | | | |
|-----------------|------|---------|--------|------|--------|--------------------|---|
| S.NO | TYPE | OPENING | HEIGHT | SILL | LINTEL | LOCATION | DESCRIPTION |
| 1 | SGL | | | | | FACADE / ELEVATION | AS PER SPECIFICATION & FINALIZED DESIGN |

Sudheer Kumar
Digitally signed by Sudheer Kumar
Date: 2025.01.28 14:52:01 +05'30'

Amit Varma
Digitally signed by Amit Varma
Date: 2025.01.25 17:23:25 +05'30'

LEGEND

- F.A.R. AREA
- 15 % SERVICES AREA
- COMMERCIAL AREA

| | | |
|--|--|------------------------------|
| OWNER SIGN Rajat pathak Rajat pathak 2025.01.2 3 12:45:08 +05'30' | ARCHITECT SIGN AVANI SH SRIVAS TAV AVANISH SRIVASTAV 2025.01.23 12:45:21 +05'30' | |
| TOWN PLANNER SIGN | | |
| OWNER GODREJ PROPERTIES LIMITED | | |
| SUBMISSION DRAWING | | |
| KEY PLAN | | |
| PROJECT PROPOSED GROUP HOUSING FOR PLOT NO :- GH-01/B,C,D,E,J & K SECTOR -12, GREATER NOIDA, G.B. NAGAR, (U.P.) | | |
| DATE 08 - 01 -2025 | PROJECT INCH. BALRAJ SINGH | CHECKED BY BALRAJ SINGH |
| SCALE 1:100 | DEALT BY ABDHESH JHA | APPROVED BY VISHAL SHARMA |
| DRAWING TITLE GROUND FLOOR PLAN | | |
| COMMERCIAL & COMMUNITY CENTER | | |
| ARCHITECTS GOLDEN INDIA ARCHITECTS THE TEAM OF ARCHITECTS FF-37, KADAMBA SHOPPING COMPLEX GAMMA-IGREATER NOIDA CON. +91-94-1585-6777 | | |
| DESIGN BY: Confluence NEW DELHI, INDIA F-1, FIRST FLOOR, MIRA CORPORATE SUITES, ISHWAR NAGAR, NEW DELHI 110065 Ph- +91-11-26925684 ccs@inconfluence.com Member of IGBC Ph- +91-11-40564768 www.inconfluence.com ISO - 9001: 2000 architecture urban design hospitality interiors | | |
| DRAWING NO. S-69 | REVISION | |